

1ST AND 2ND FLOOR COUNTER REMODEL AND ENTRANCE REPLACEMENT CITY OF SUN PRAIRIE Sun Prairie, WI

Consultant:

Project Owner:
City of Sun Prairie
300 East Main St.
Sun Prairie, WI 53590

Project Address:
300 East Main St.
Sun Prairie, WI 53590

**1ST AND 2ND FLOOR COUNTER REMODEL
AND ENTRANCE REPLACEMENT
CITY OF SUN PRAIRIE
Sun Prairie, WI**

Sheet Title:
TITLE SHEET

Revisions:

No.	Date	Description
02/10/2023		Plan Review Documents

Graphic Scale: 1" = 24X36"

Project Number: 2138

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Sheet Number: **T100**


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Regional Location Map



Building Aerial



WORK AREA

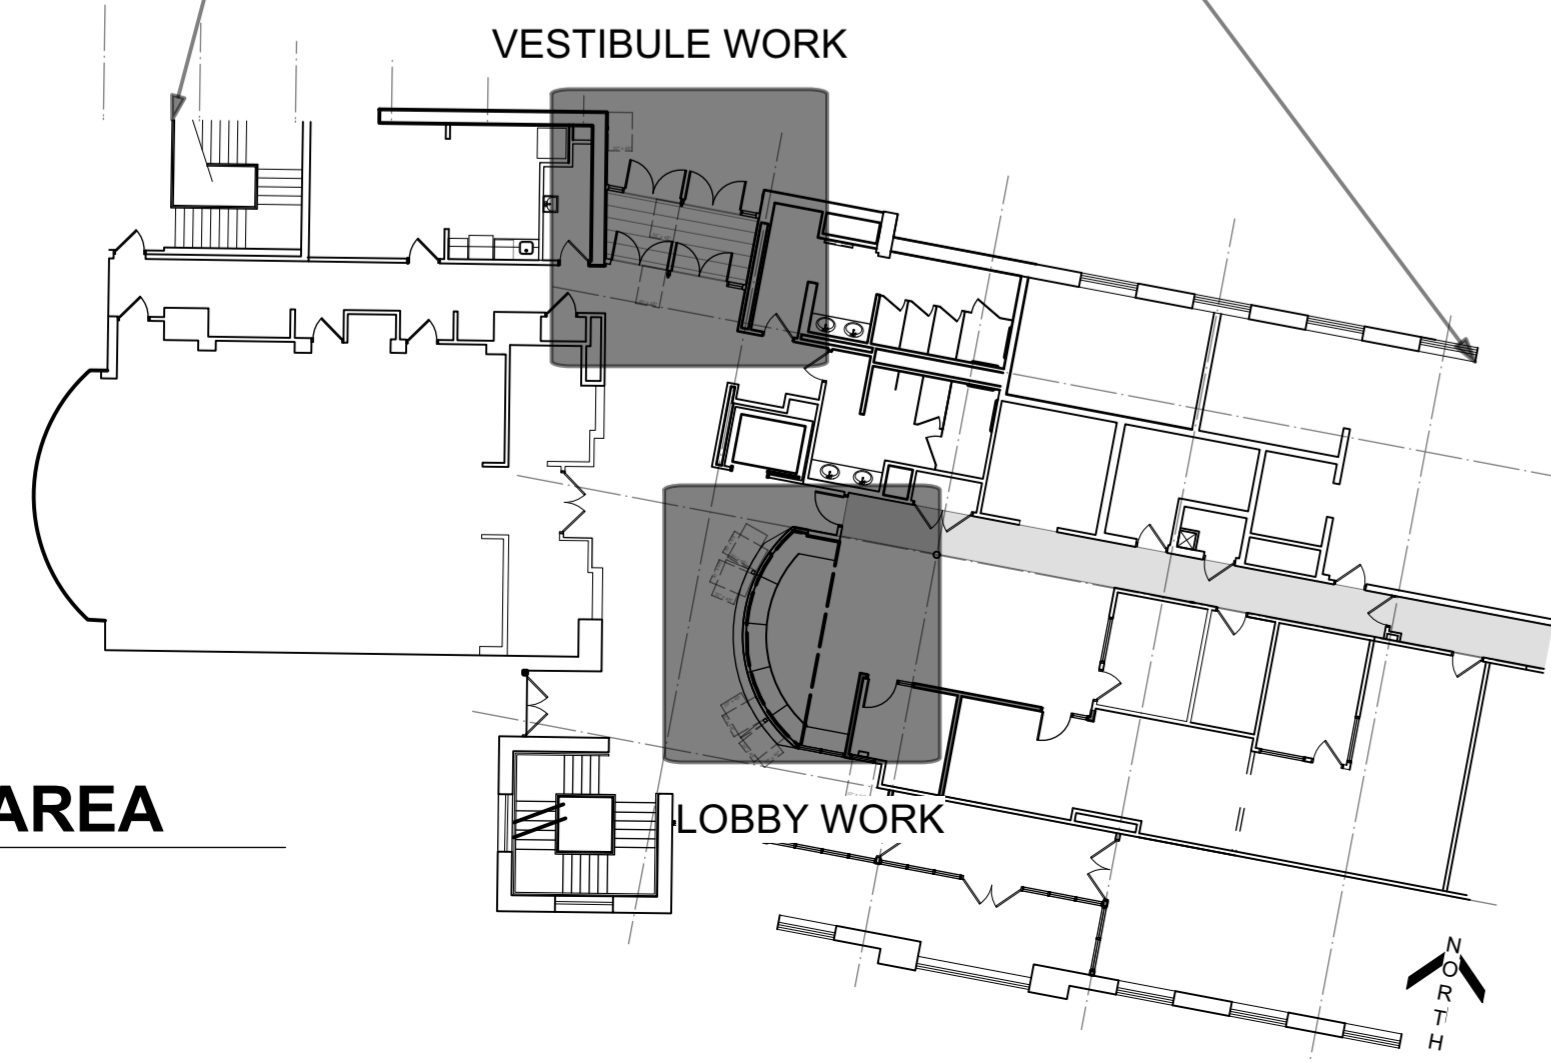2
T100



FIRST FLOOR PROPOSED RECEPTION DESK - VIEW 1

LEGEND

- Detail Reference
- Scale:
- BAR SCALE
- ELEVATION REFERENCE
- DETAIL REFERENCE
- SECTION REFERENCE
- DOOR TYPE
- FIXTURE TYPE
- DEMOLITION KEYED NOTE
- SHEET KEYED NOTE
- NORTH ARROW

SHEET INDEX

- T100** TITLE SHEET
- A100** FIRST FLOOR PLANS
- A101** SECOND FLOOR PLANS
- A102** FIRST FLOOR ENTRY DOORS PLANS
- A400** FIRST FLOOR REFLECTED CEILING PLANS
- A401** SECOND FLOOR REFLECTED CEILING PLANS
- A500** WALL TYPES
- A600** RECEPTION AREA SCHEDULES and INTERIOR DETAILS
- A601** ENTRY AREA DOOR SCHEDULE and DETAILS
- A602** ROOM FINISH SCHEDULE
- M100** DEMOLITION - MECHANICAL
- M101** PROPOSED - MECHANICAL
- E/F000** ELECTRICAL / FIRE PROTECTION NOTES and SCHEDULES
- E/F100** FIRST FLOOR - POWER AND DATA & LIGHTING AND FIRE PROTECTION PLANS
- E/F101** SECOND FLOOR - POWER AND DATA & LIGHTING AND FIRE PROTECTION PLANS
- E/F102** FIRST FLOOR ENTRY - POWER & LIGHTING AND FIRE PROTECTION PLANS

Project Description

IN GENERAL, THE WORK CONSISTS OF THE REMODELING OF THE 1ST AND 2ND FLOOR RECEPTION COUNTERS AT THE CITY HALL TO ACCOMMODATE NEW OPEN OFFICE AREA. THIS PROJECT WILL ALSO REPLACE THE EXISTING CITY HALL ENTRANCE DOORS AND HARDWARE TO PROVIDE AN UPDATED SECURE ENTRY SYSTEM.

CODE INFORMATION

IEBC & IBC 2015 with SPS 361 - 366 Amendments
City of Sun Prairie Administration Building, 1st, 2nd and Entry Remodel

Project is a level 2 alteration remodeling 1st floor reception space. Second floor reception area remodeled into open office space. and replacing the North vestibule doors at the the parking lot entry with attack resistant glazing. No change of use or exit width

Altered Area:
Total Building 42,966 SF (total building area) existing,
Are of Work(Vestibule - 126 sf; 1st Floor Reception -1,303 sf; 2nd Floor Reception - 289 sf) = 1,718/42,966 = 4%

CHAPTER 3: USE and OCCUPANCY CLASSIFICATION
Existing Building has: Group B Office uses, Including A-3 Meeting Rooms, Accessory Storage & Mechanical


CHAPTER 5: GENERAL BUILDING HEIGHT and AREA
2 Story above grade unchanged
1 Story below grade unchanged

CHAPTER 6: TYPES OF CONSTRUCTION
Table 601: Type IB

CHAPTER 7: FIRE AND SMOKE PROTECTION FEATURES

CHAPTER 9: FIRE PROTECTION SYSTEMS
Existing building is sprinklered per NFPA 13. A Fire alarm system exists and will need to be modified or calibrated for the new space configurations.

CHAPTER 10: MEANS OF EGRESS
Existing to Remain

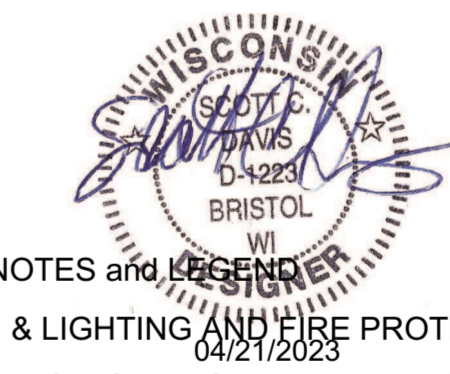

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AND ENTRANCE REPLACEMENT**
CITY OF SUN PRAIRIE
Sun Prairie, WI

Sheet Title:
FIRST FLOOR PLANS

Revisions:	
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FLOOR PLAN REMOVAL NOTES

- ① REMOVE WALL
- ② REMOVE WINDOW AND FRAME
- ③ REMOVE DOOR & FRAME; SALVAGE AND DELIVER TO OWNER
- ④ REMOVE CASE WORK
- ⑤ REMOVE TILE FLOORING AND BASE IN THIS AREA AND PREP FOR NEW FLOORING. PROTECT EXISTING FLOORING TO REMAIN,
- ⑥ REMOVE AND SALVAGE CARPET TILES FOR REUSE. DISPOSE OF CARPET DEEMED NOT SALVAGABLE BY OWNER. ASSUME 67% SALVAGE
- ⑦ REMOVE CARPET, PREPARE FOR NEW FLOORING.
- ⑧ PROTECT FLOORING IN THIS AREA
- ⑨ REMOVE MAG LOCK AND ASSOCIATED HARDWARE, PREP FOR NEW ELECTRIC STRIKE

GENERAL REMOVAL NOTES


- 1 REPAIR GYPSUM WALL BOARD WHERE WALL WAS REMOVED; PAINT INCLUDE EDGE TO EDGE OF ADJACENT SURFACES.

FLOOR PLAN CONSTRUCTION NOTES

- A ALIGN NEW WALL WITH EXISTING
- B PANIC BUTTON - SEE ELECTRICAL
- C NEW TRANSACTION WINDOW
- D NEW STOREFRONT WINDOWS (08 41 13) WITH MOTORIZED ROLLER SHADE (SECTION 12 24 13)
- E PATCH WALL WHERE PARTITION REMOVED
- F NEW CASEWORK
- G PROTEX WALL DROP BOX WITH ADJUSTABLE CHUTE & KEYED LOCK MDL-170 1/2"x6"x16" BEIGE; PROVIDED AND INSTALLED BY CONTRACTOR
- H NEW FLOORING AND BASE TO MATCH EXISTING. USE SALVAGED WHERE SALVAGED CAN BE USED IN ONE ENCLOSED SPACE.
- J NEW FLOORING WITH RESILIENT TRANSITION TO EXISTING CARPET
- K TRANSACTION MONITOR SUPPLIED BY OWNER; INSTALLED AND WIRED BY CONTRACTOR
- L NEW RESILIENT FLOOR TRANSITION BETWEEN CARPET (NEW OR EXISTING) AND EXISTING FLOORING (CARPET, PORCELAIN TILE OR M)
- M APPLY DECORATIVE FILM OVERLAY, TO LOWER TWO WINDOW PANES ALONG WINDOW WALL, FROM THE OFFICE SIDE
- N EXISTING FRAME AND DOOR TO BE MODIFIED TO ACCOMMODATE NEW HARDWARE. WORK INCLUDES LOW AND LINE VOLTAGE WORK - SEE ELECTRICAL.

GENERAL CONSTRUCTION NOTES:

- 1. PARTITION TYPES CAN BE FOUND ON SHEET A500

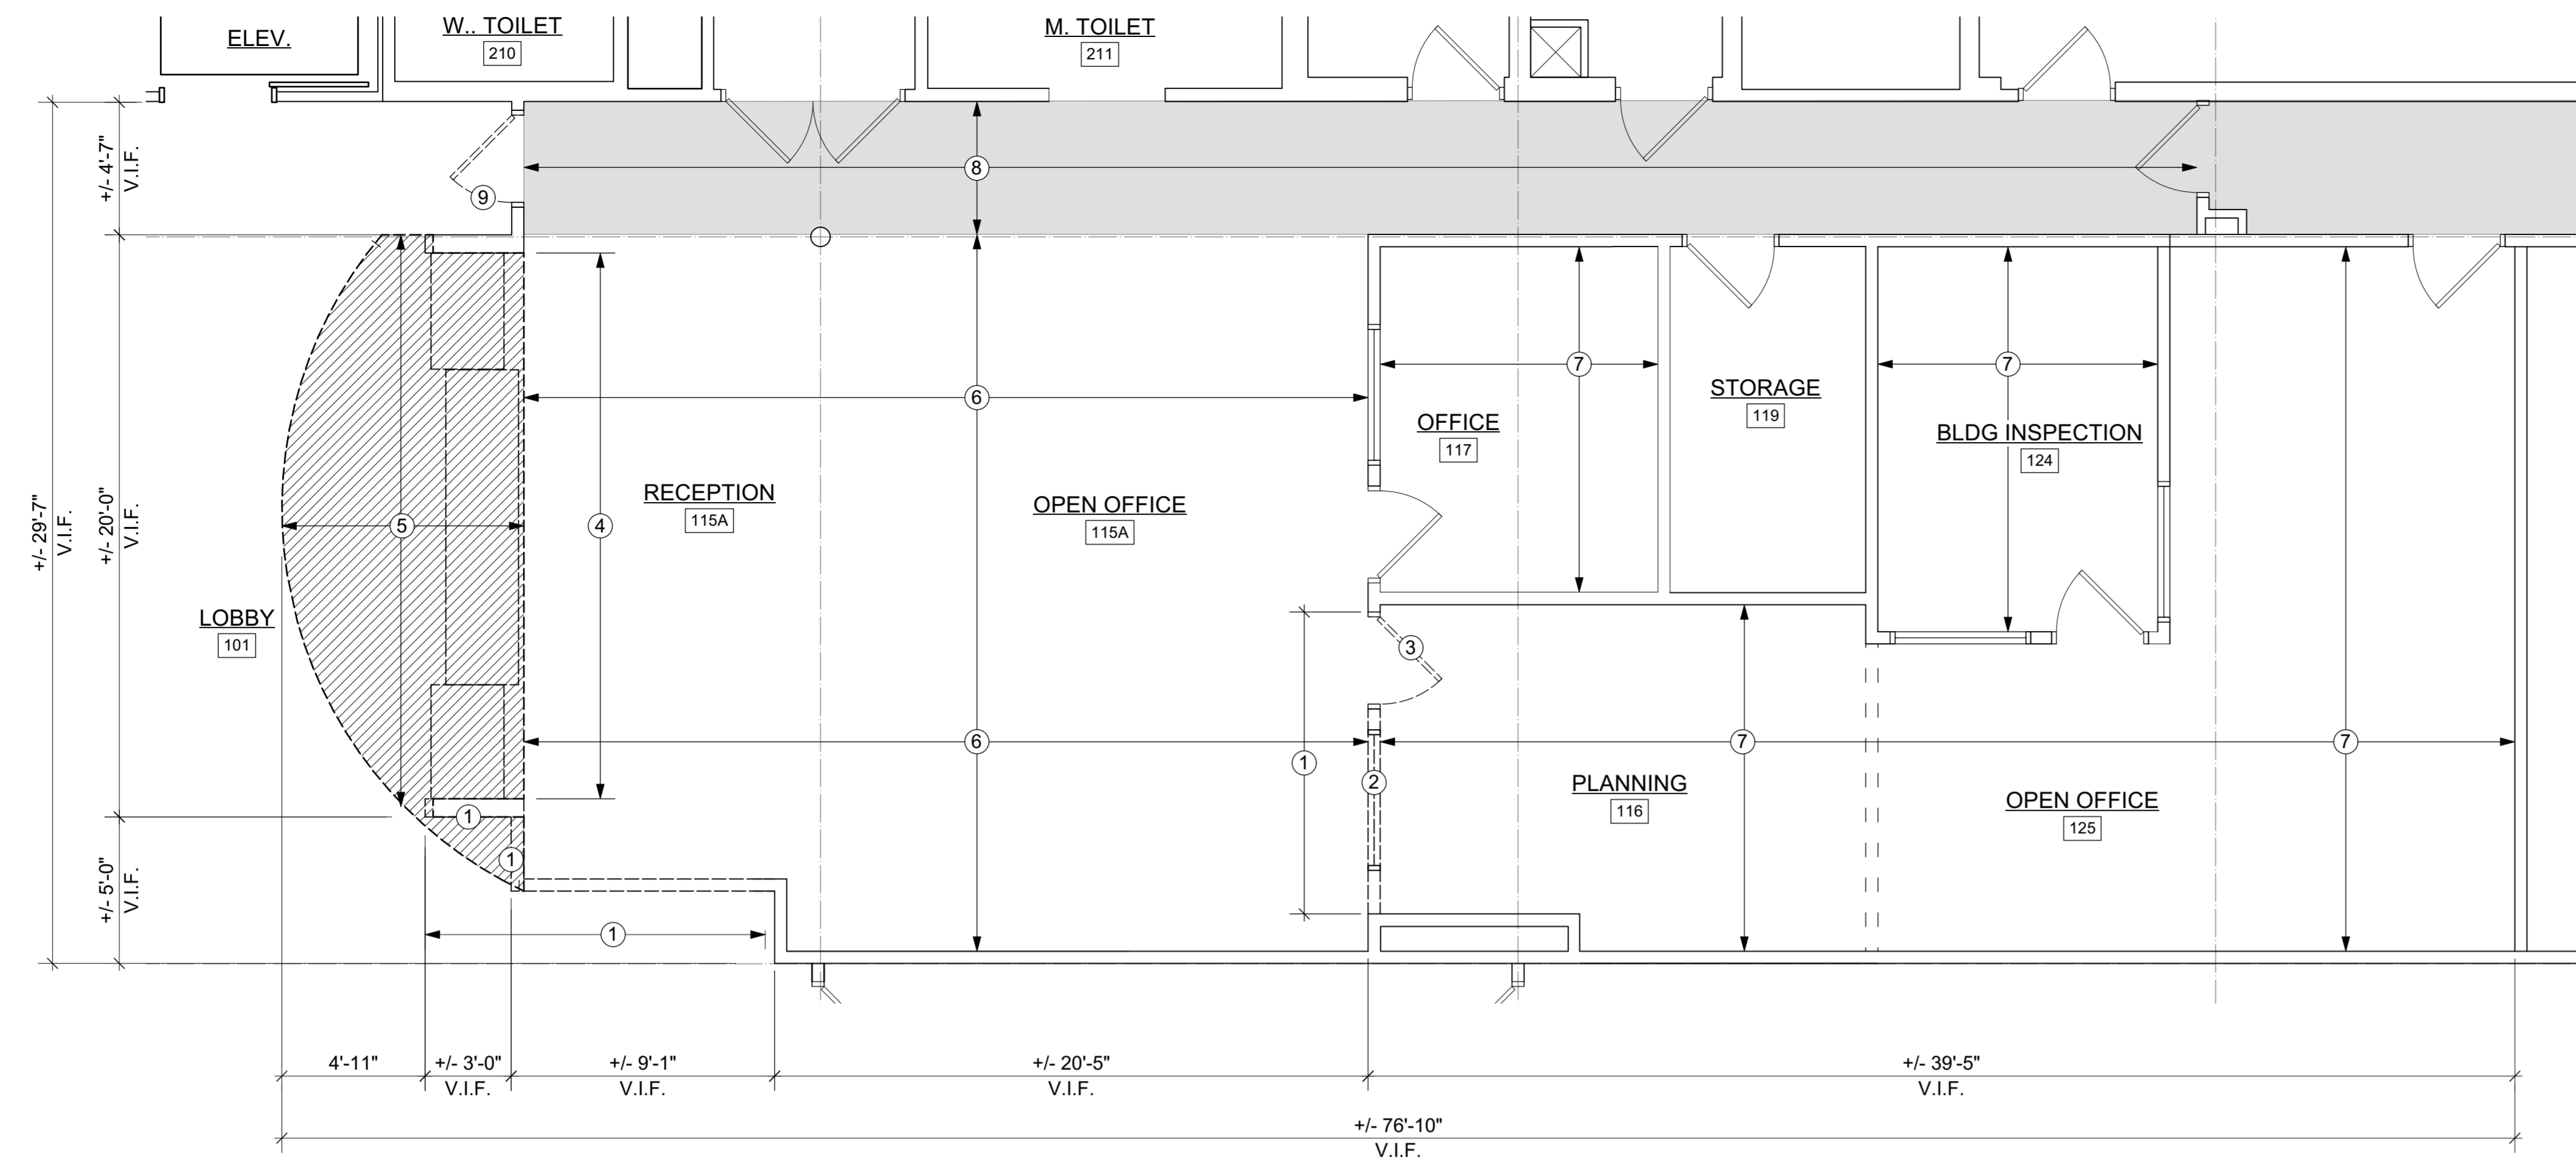


1 FIRST FLOOR RECEPTION DEMOLITION PLAN
Scale: 1/4" = 1'-0"



STOREFRONT DETAILS

3 A600

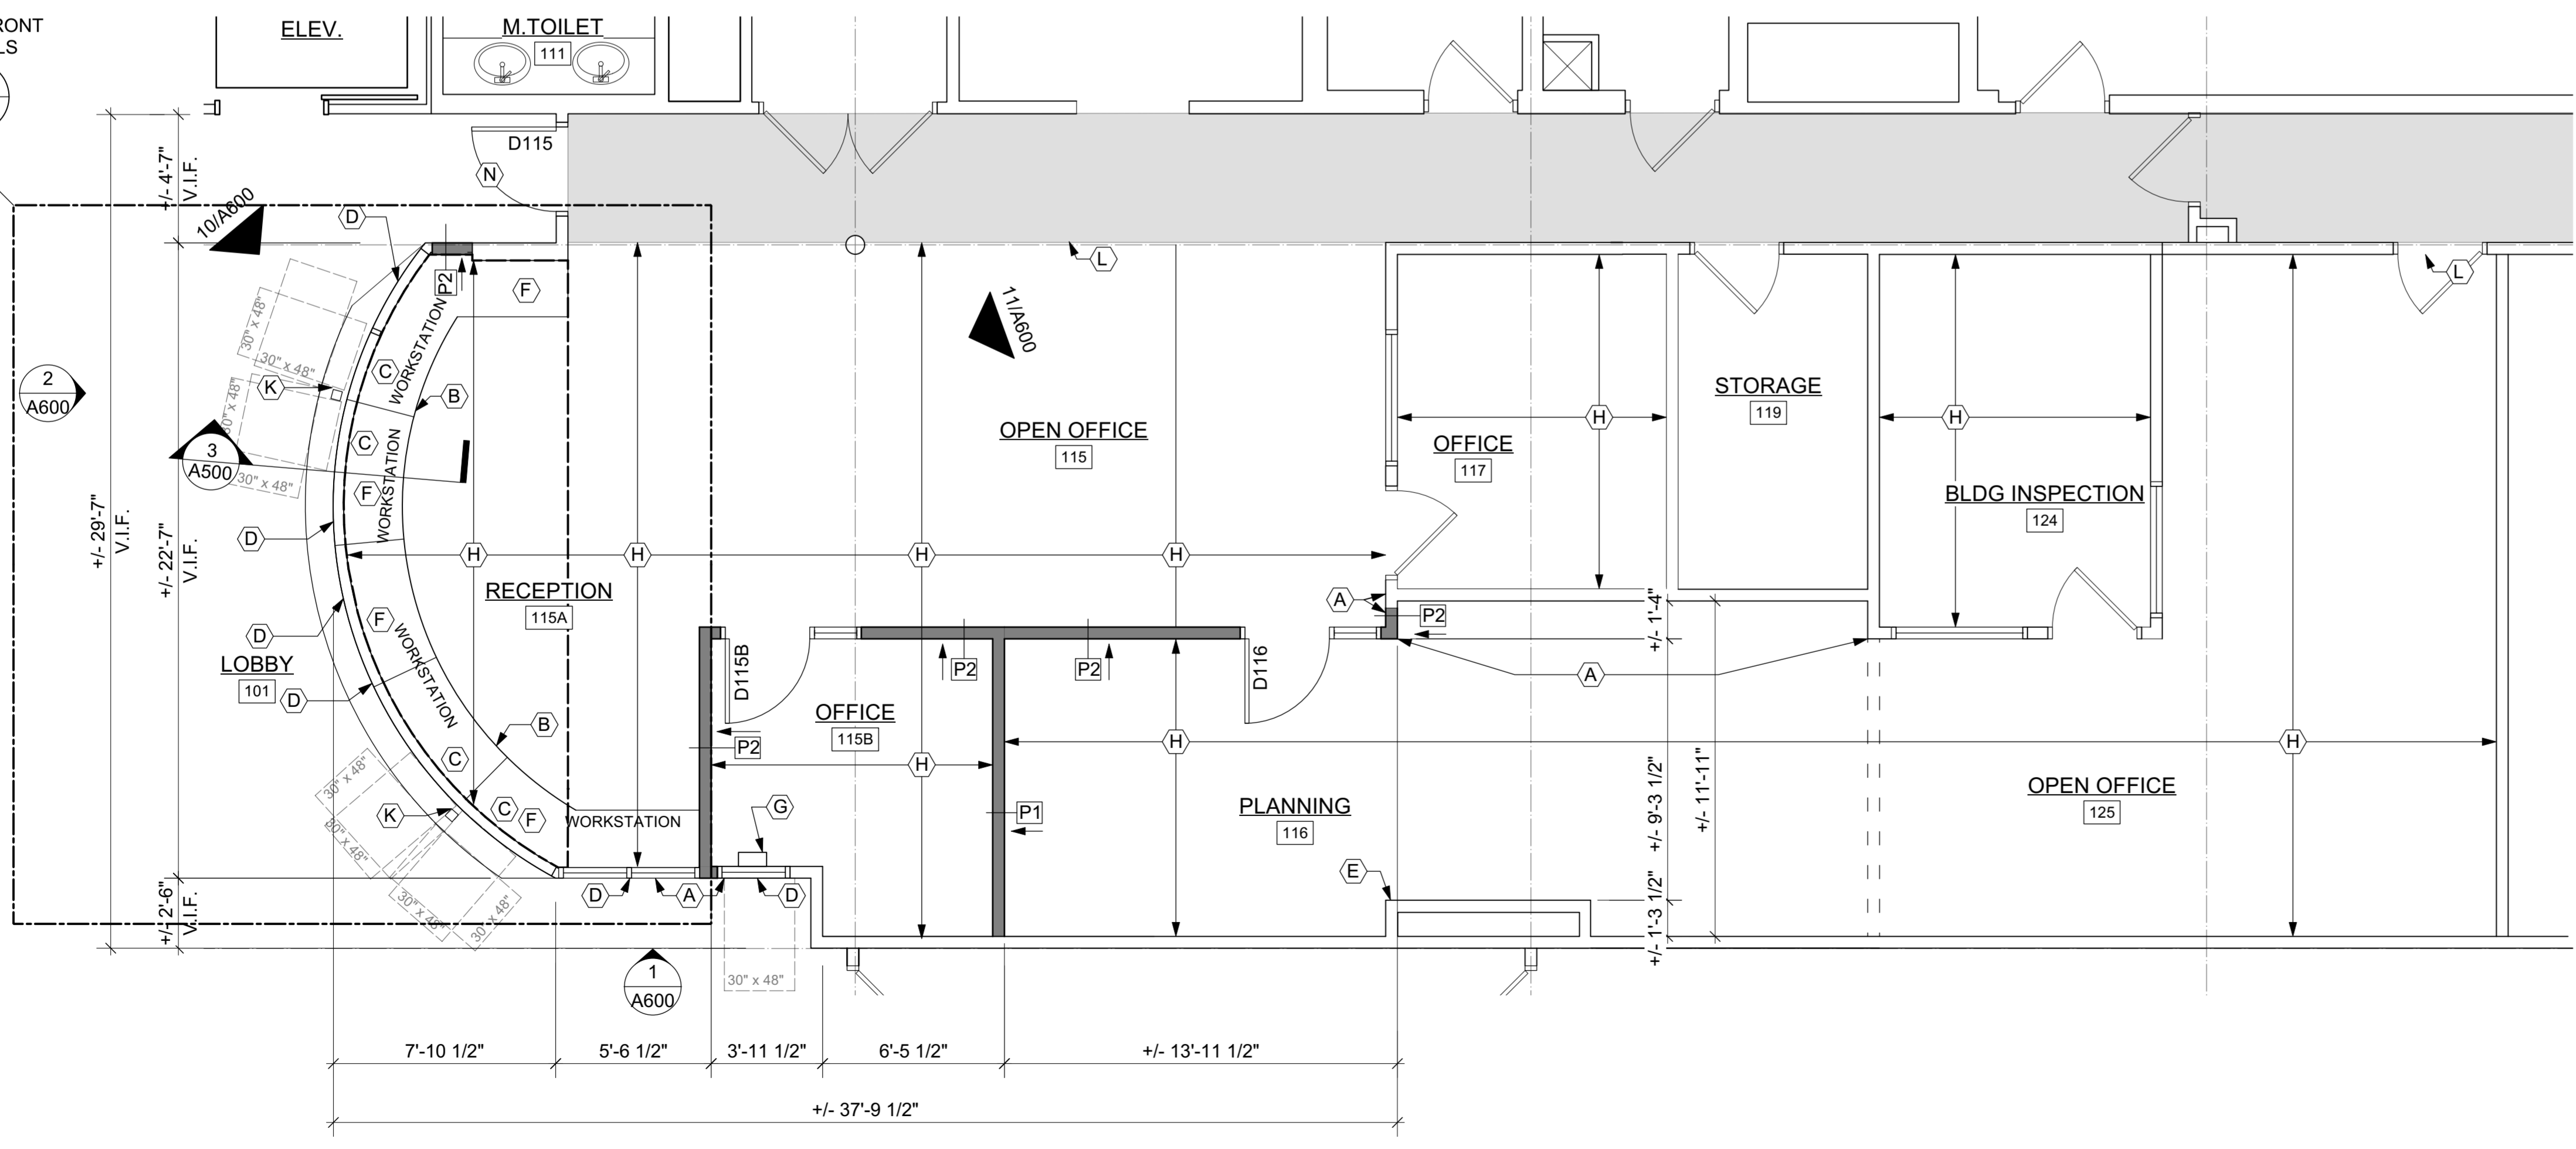

2 FIRST FLOOR RECEPTION PROPOSED PLAN
Scale: 1/4" = 1'-0"



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Sun Prairie, WI

Sheet Title:
SECOND FLOOR PLANS

Revisions:

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Graphic Scale: Print 24X36
Scale: 1/4" = 1'-0"


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Sheet Number: **A101**

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1
A101 SECOND FLOOR RECEPTION DEMOLITION PLAN
Scale: 1/4" = 1'-0"




FLOOR PLAN REMOVAL NOTES

- ① REMOVE WALL
- ② REMOVE WINDOW AND FRAME
- ③ REMOVE DOOR & FRAME; SALVAGE AND DELIVER TO OWNER
- ④ REMOVE CASE WORK
- ⑤ REMOVE TILE FLOORING AND BASE IN THIS AREA AND PREP FOR NEW FLOORING. PROTECT EXISTING FLOORING TO REMAIN.
- ⑥ REMOVE AND SALVAGE CARPET TILES FOR REUSE. DISPOSE OF CARPET DEEMED NOT SALVAGABLE BY OWNER. ASSUME 67% SALVAGE
- ⑦ REMOVE CARPET, PREPARE FOR NEW FLOORING.
- ⑧ PROTECT FLOORING IN THIS AREA
- ⑨ REMOVE MAG LOCK AND ASSOCIATED HARDWARE, PREP FOR NEW ELECTRIC STRIKE

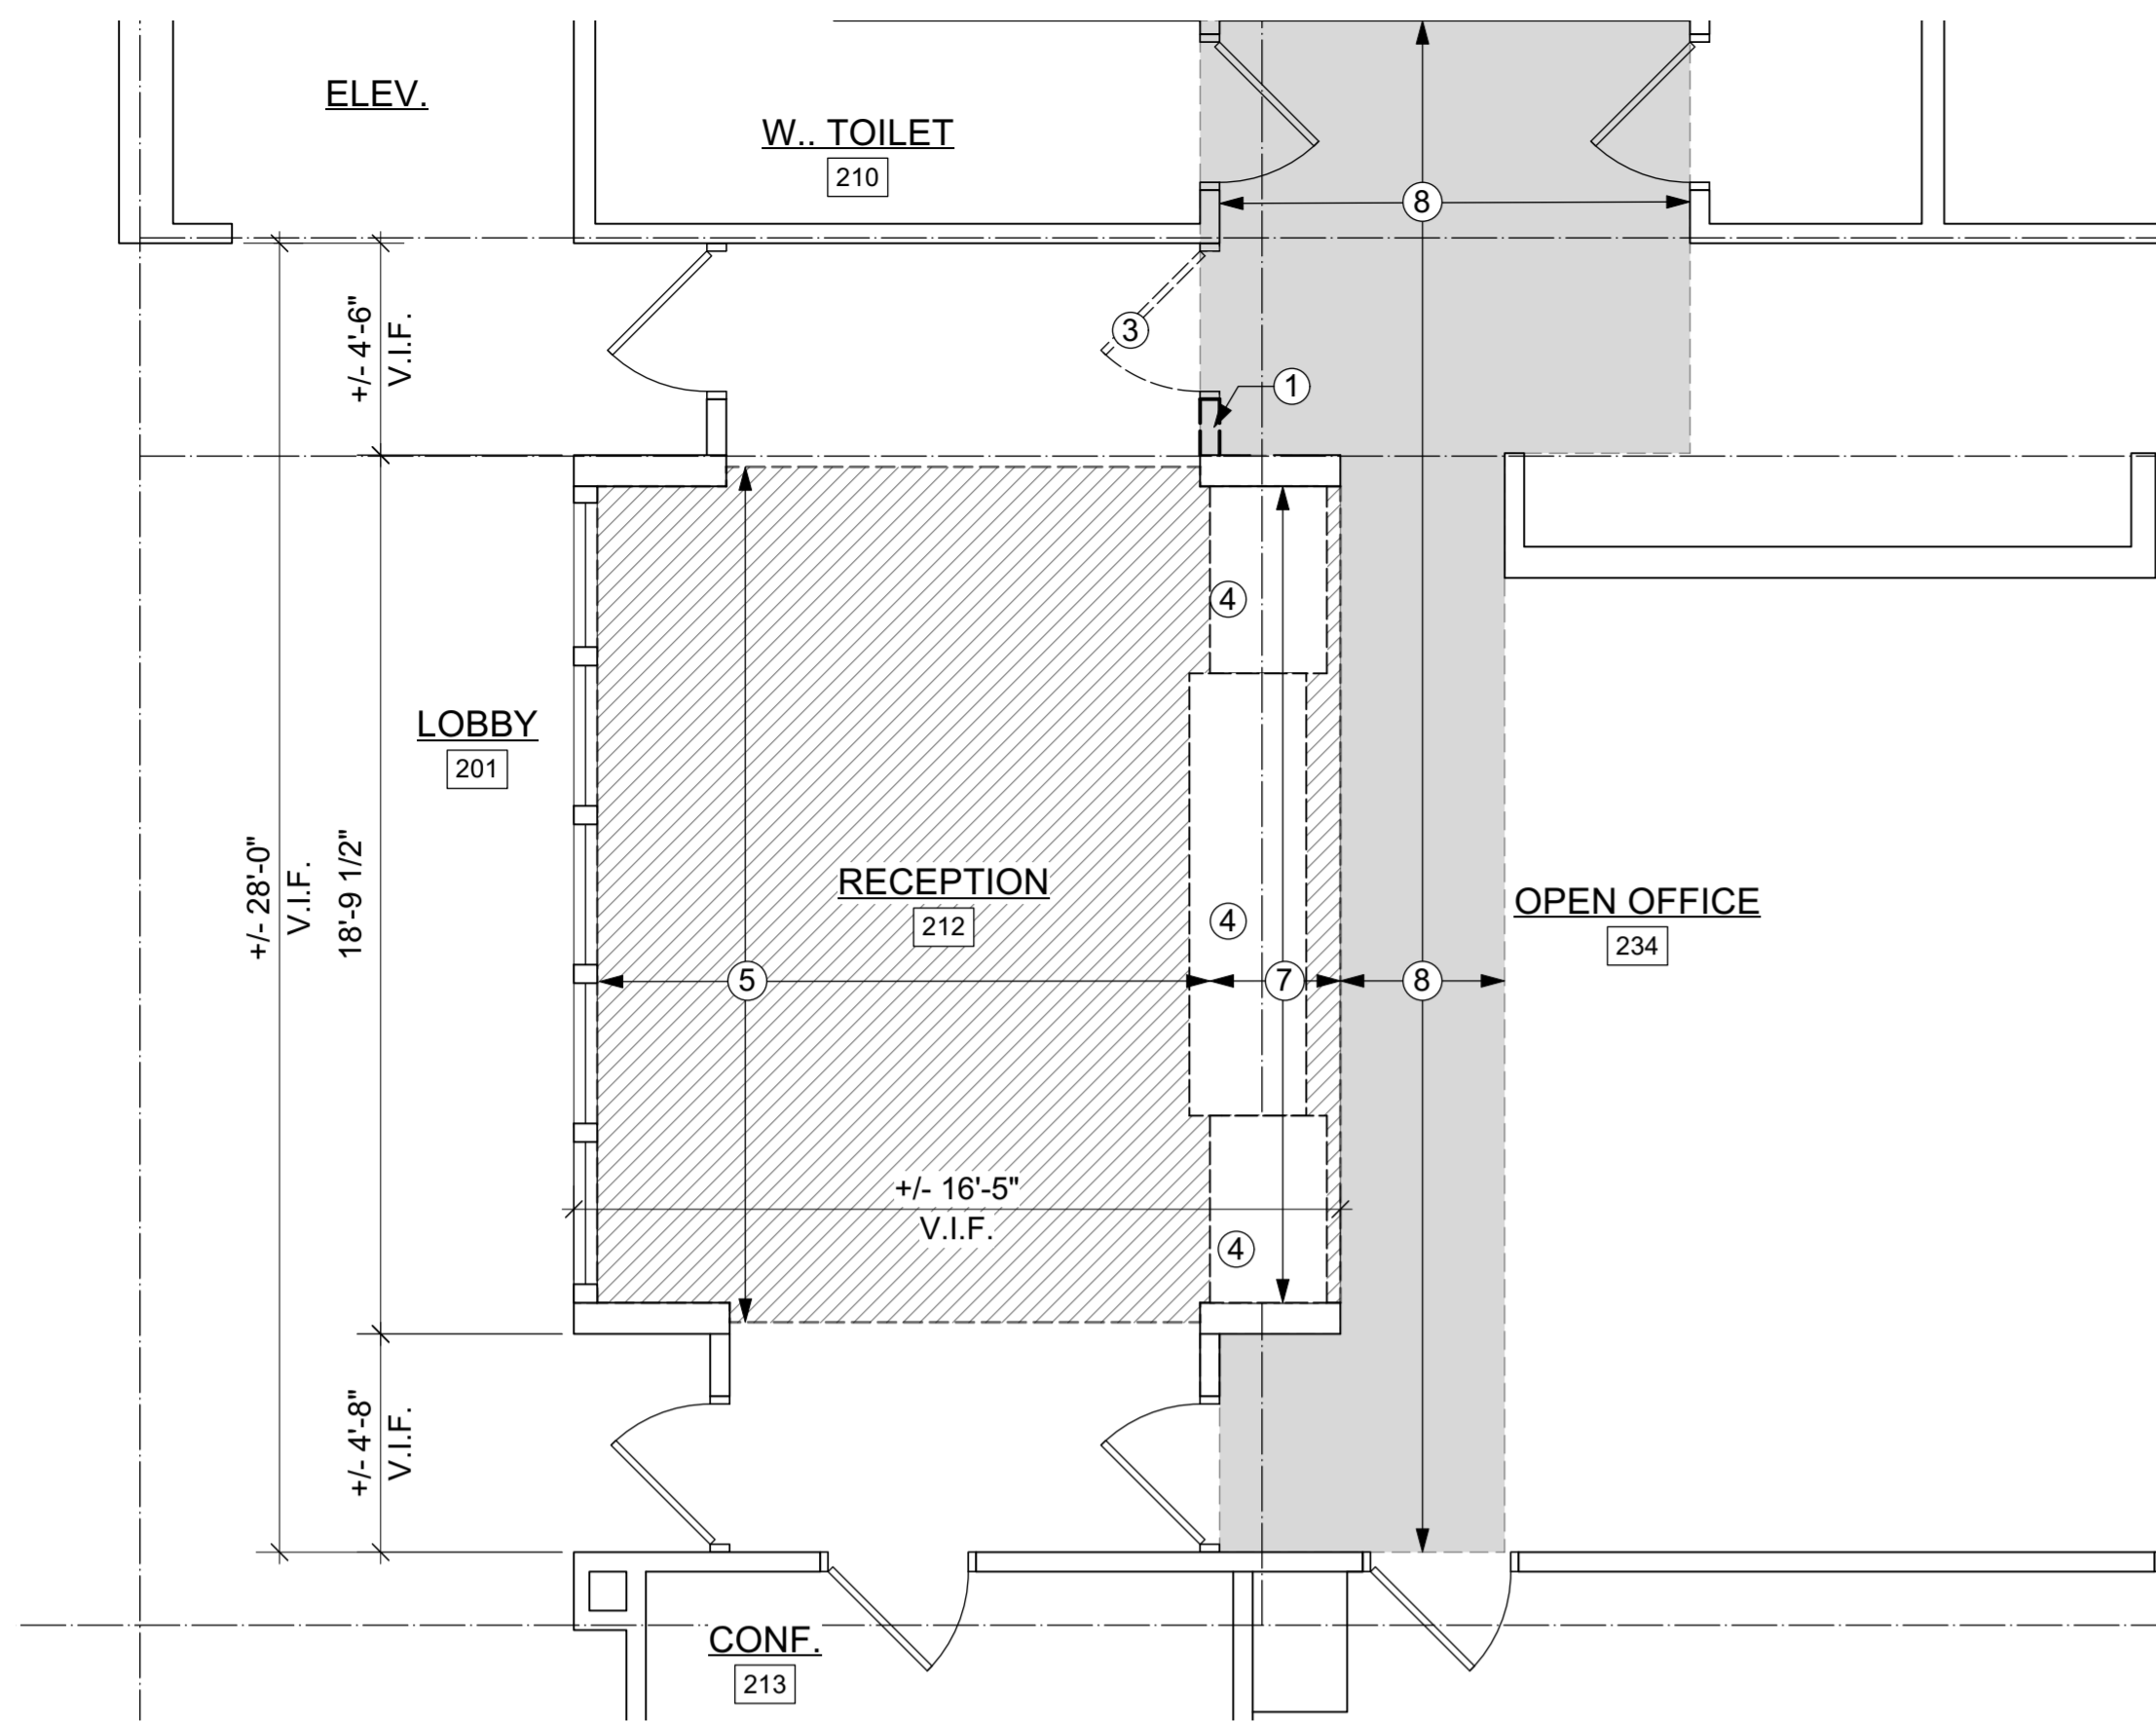GENERAL REMOVAL NOTES

- 1 REPAIR GYPSUM WALL BOARD WHERE WALL WAS REMOVED; PAINT INCLUDE EDGE TO EDGE OF ADJACENT SURFACES.

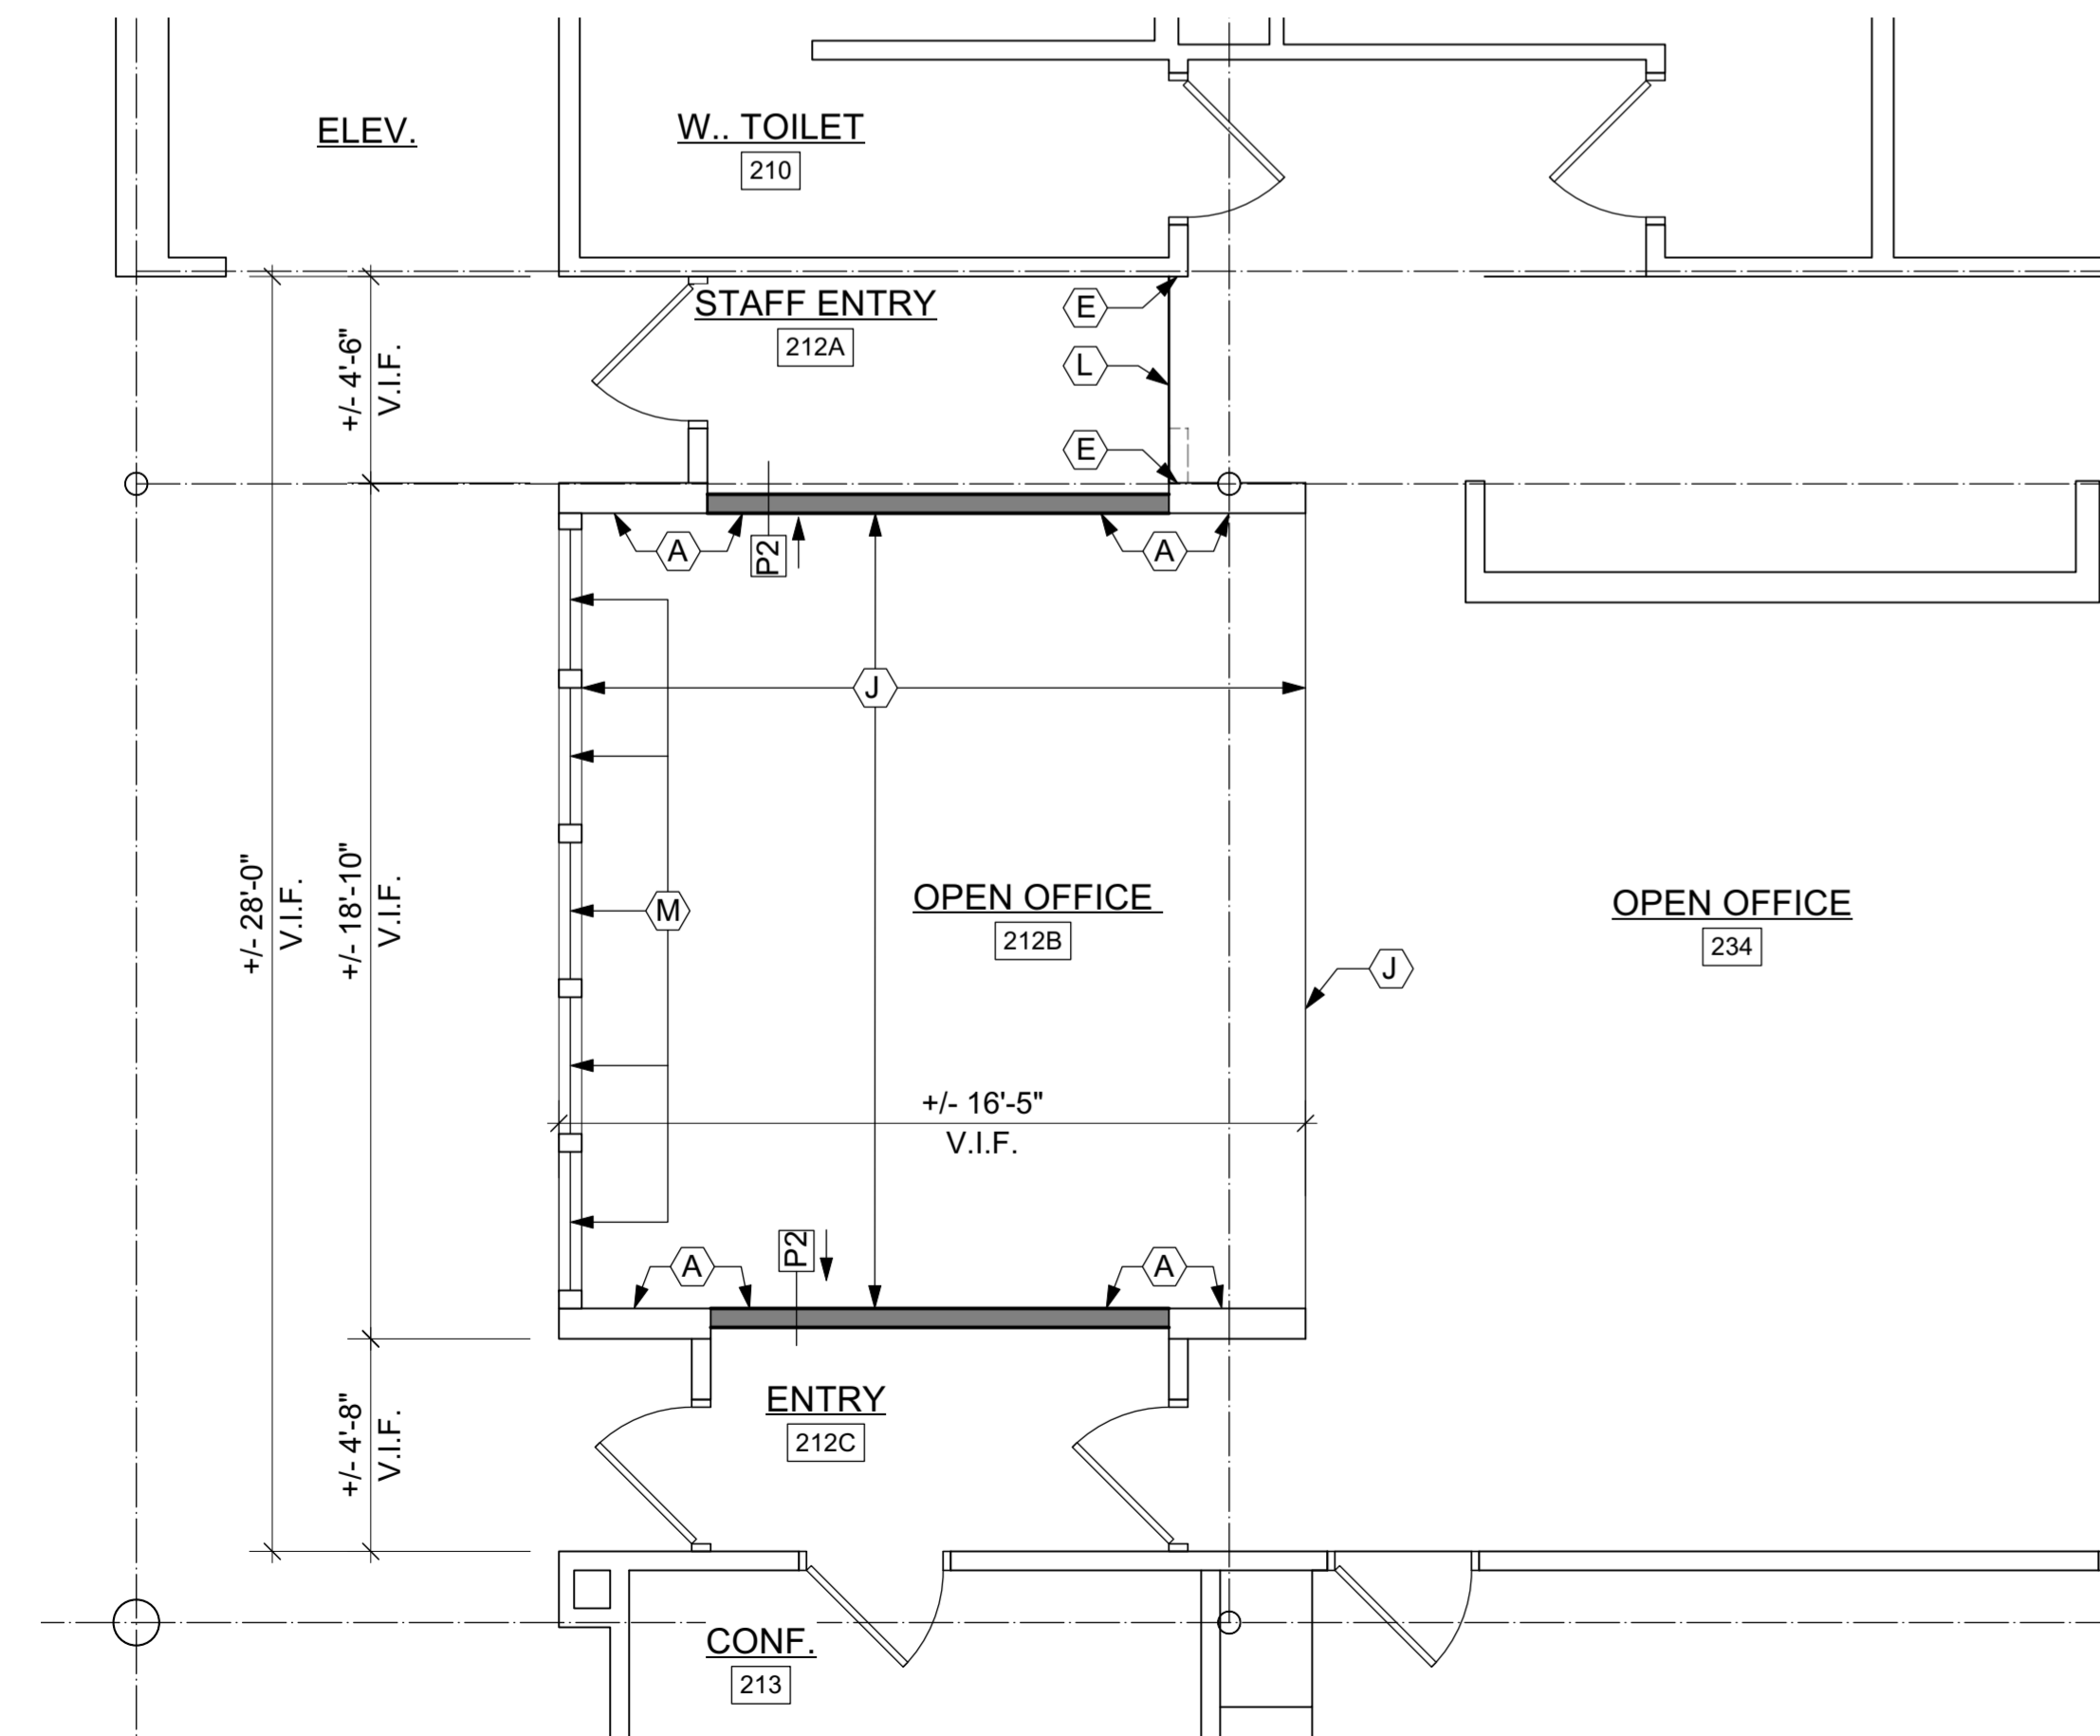

2
A101 SECOND FLOOR MEETING ROOM AND OFFICE ENTRY
Scale: 1/4" = 1'-0"




FLOOR PLAN CONSTRUCTION NOTES

- (A) ALIGN NEW WALL WITH EXISTING
- (B) PANIC BUTTON - SEE ELECTRICAL
- (C) NEW TRANSACTION WINDOW
- (D) NEW STOREFRONT WINDOWS (08 41 13) WITH MOTORIZED ROLLER SHADE (SECTION 12 24 13)
- (E) PATCH WALL WHERE PARTITION REMOVED
- (F) NEW CASEWORK
- (G) PROTEx WALL DROP BOX WITH ADJUSTABLE CHUTE & KEYED LOCK MDL-170 1/2"x6"x16" BEIGE; PROVIDED AND INSTALLED BY CONTRACTOR
- (H) NEW FLOORING AND BASE TO MATCH EXISTING. USE SALVAGED WHERE SALVAGED CAN BE USED IN ONE ENCLOSED SPACE.
- (J) NEW FLOORING WITH RESILIENT TRANSITION TO EXISTING CARPET
- (K) TRANSACTION MONITOR SUPPLIED BY OWNER; INSTALLED AND WIRED BY CONTRACTOR
- (L) NEW RESILIENT FLOOR TRANSITION BETWEEN CARPET (NEW OR EXISTING) AND EXISTING FLOORING (CARPET, PORCELAIN TILE OR APPLY DECORATIVE FILM OVERLAY, TO LOWER TWO WINDOW PANES ALONG WINDOW WALL, FROM THE OFFICE SIDE
- (N) EXISTING FRAME AND DOOR TO BE MODIFIED TO ACCOMMODATE NEW HARDWARE. WORK INCLUDES LOW AND LINE VOLTAGE WORK - SEE ELECTRICAL.


GENERAL CONSTRUCTION NOTES

- 1. PARTITION TYPES CAN BE FOUND IN 7/A600.

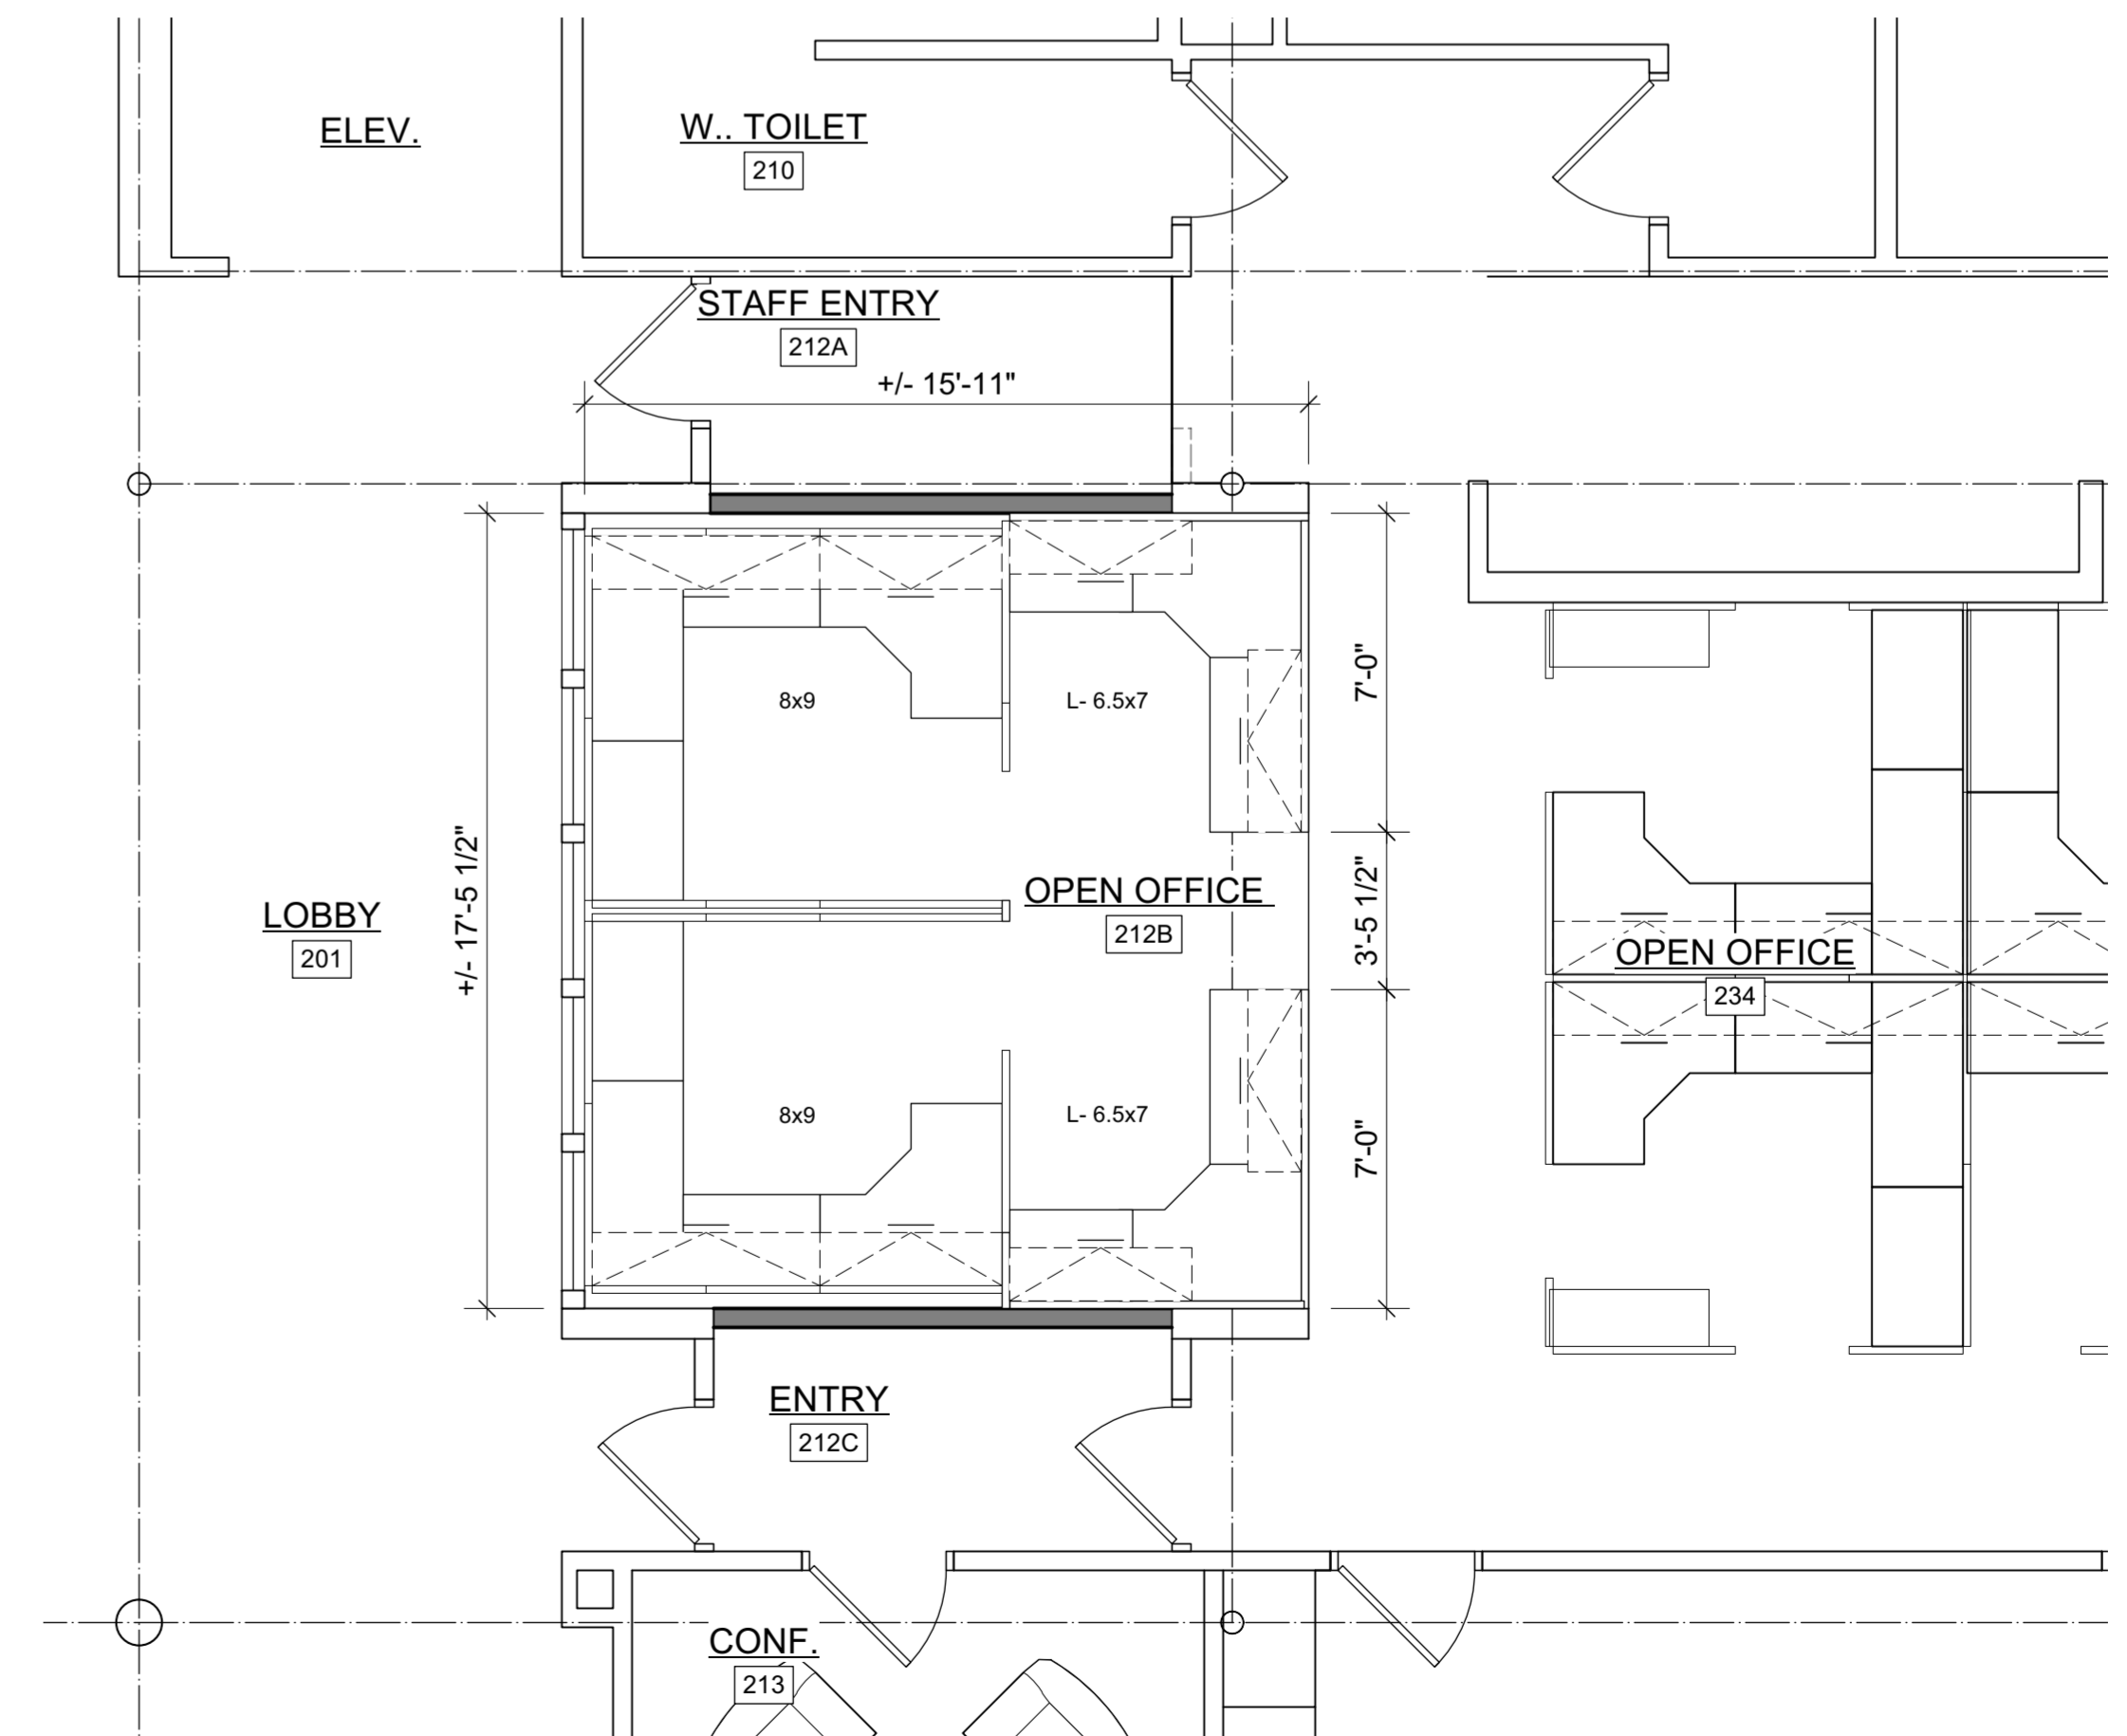

3
A101 SECOND FLOOR NEW OPEN OFFICE FURNITURE PLAN - REFERENCE ONLY
Scale: 1/4" = 1'-0"




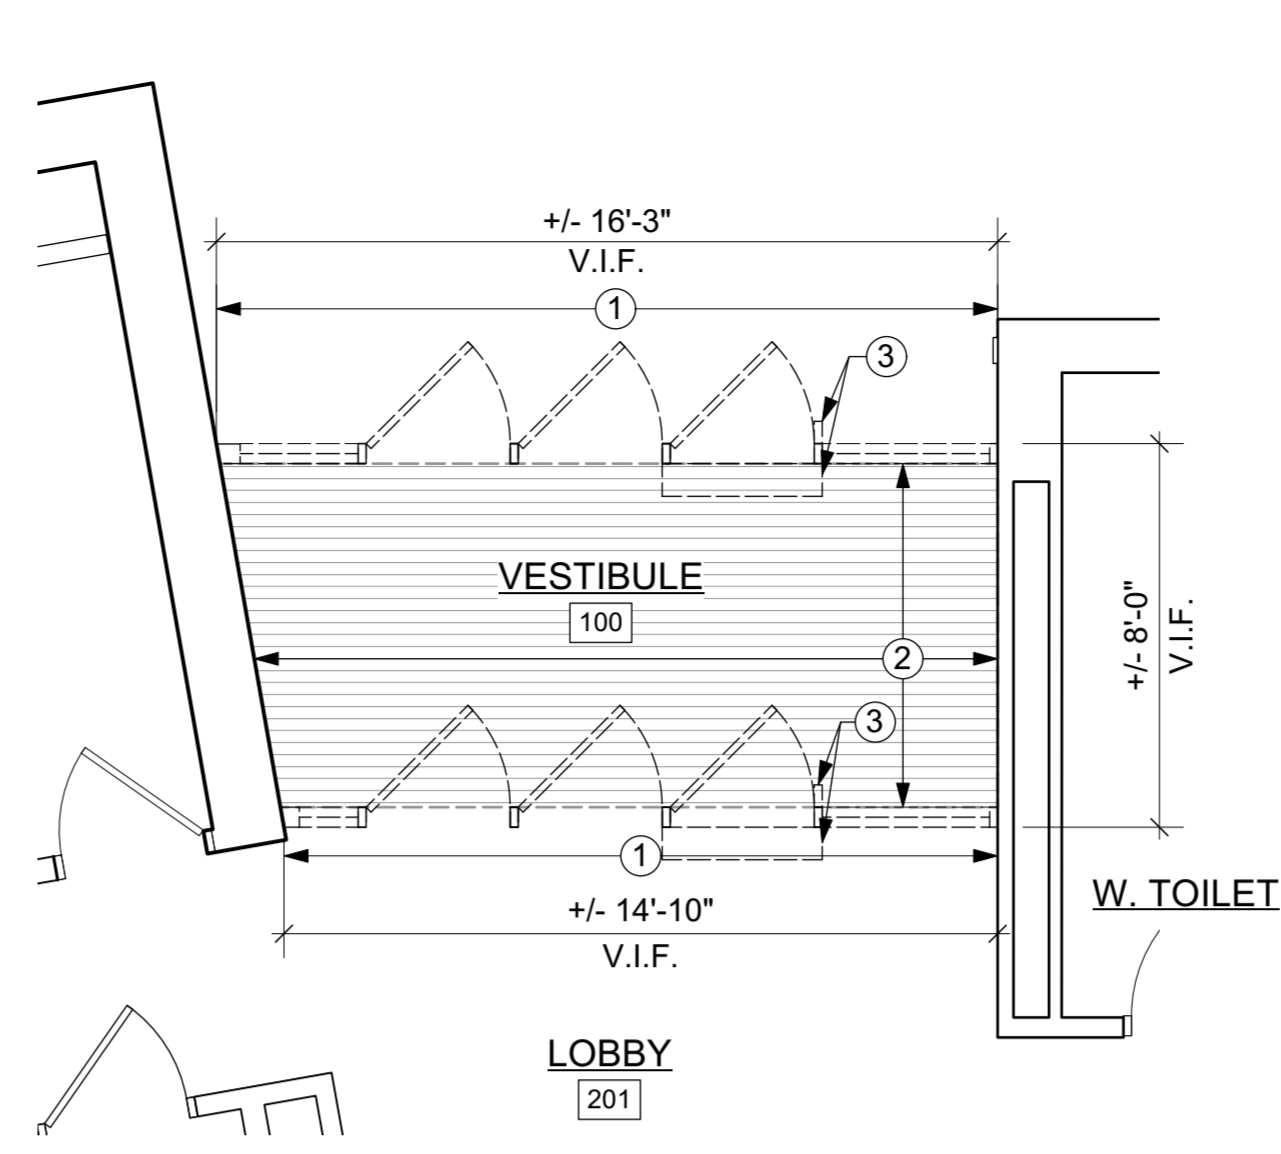

1 FIRST FLOOR VESTIBULE DOORS - DEMOLITION
Scale: 1/4" = 1'-0" NORTH

VESTIBULE DEMOLITION NOTES:


- ① REMOVE ENTRY SYSTEM AND TEMPORARILY SECURE OPENING
- ② REMOVE EXISTING WALK OFF MATT AND PREP FOR NEW RECESSED WALK OFF MATT; CLEAN EXISTING RECESS
- ③ REMOVE & SALVAGE AUTOMATIC DOOR OPERATOR and CONTROLS

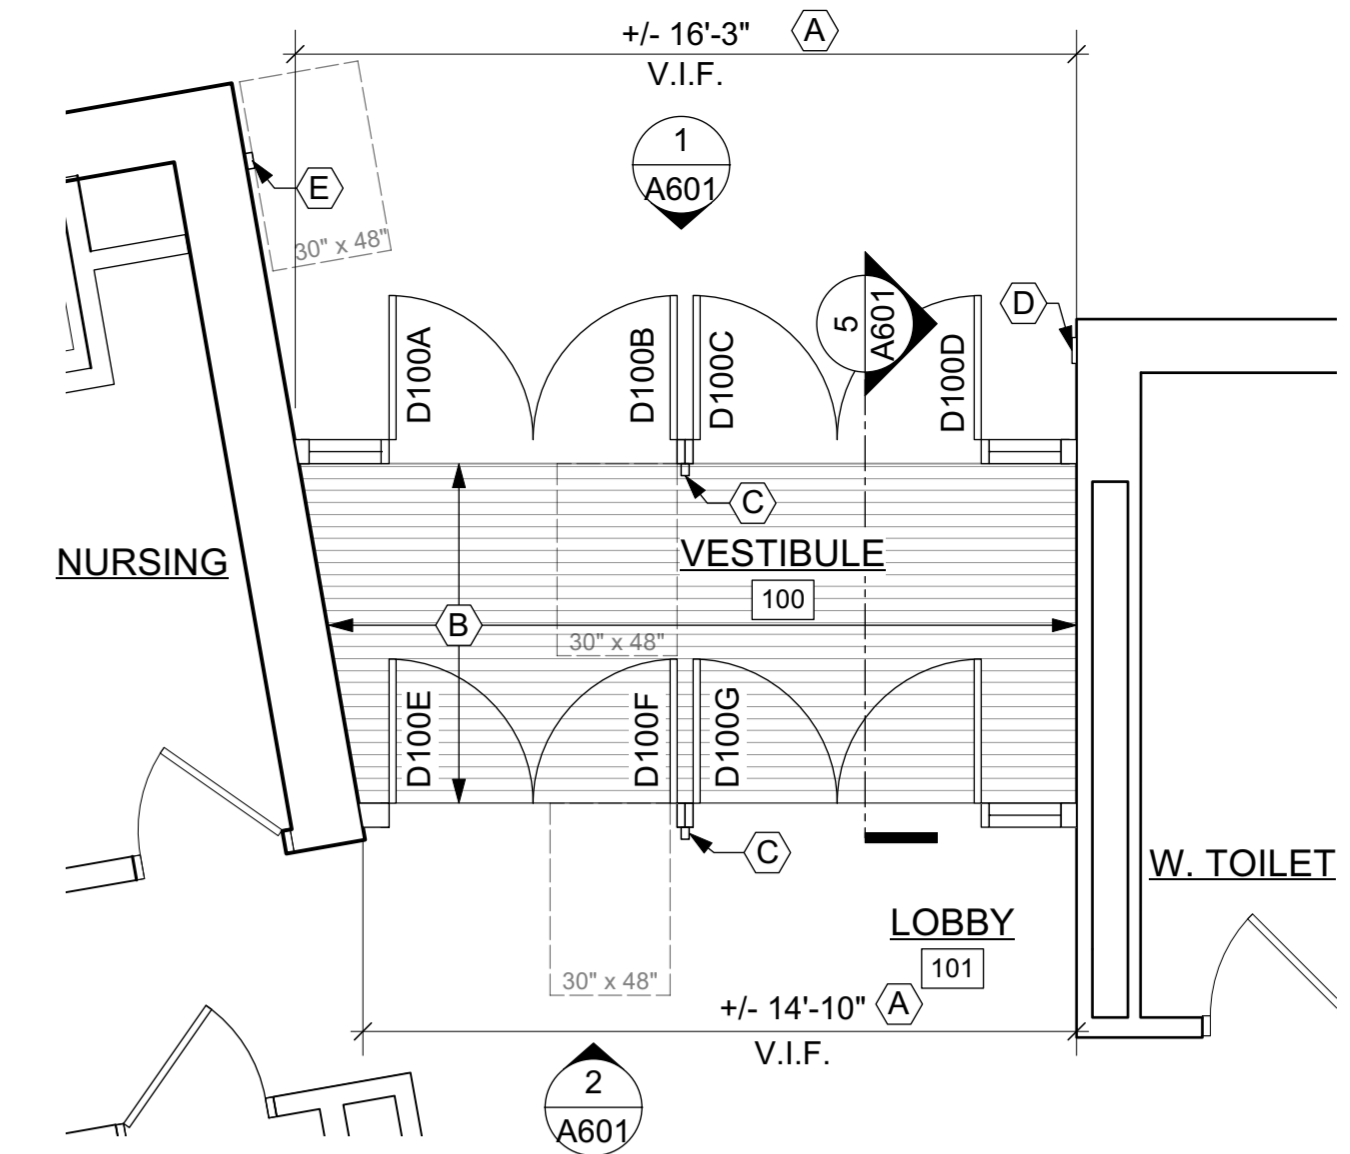

2 FIRST FLOOR PROPOSED VESTIBULE
Scale: 1/4" = 1'-0" NORTH

VESTIBULE CONSTRUCTION NOTES:


- Ⓐ NEW ALUMINUM ENTRY SYSTEM WITH LAMINATED SECURITY GLAZING
- Ⓑ NEW WALK OFF MAT AND TRANSITION AT INTERIOR DOORS
- Ⓒ REINSTALL AUTOMATIC SALVAGED DOOR OPERATOR WITH NEW CONTROLS AND WIRING
- Ⓓ EXISTING KEY CARD ENTRY TO BE PROGRAMED WITH NEW DOOR SYSTEM AND REWIRED BY CONTRACTOR
- Ⓔ NEW AUTOMATIC DOOR OPERATOR, CONTROLS AND WIRING

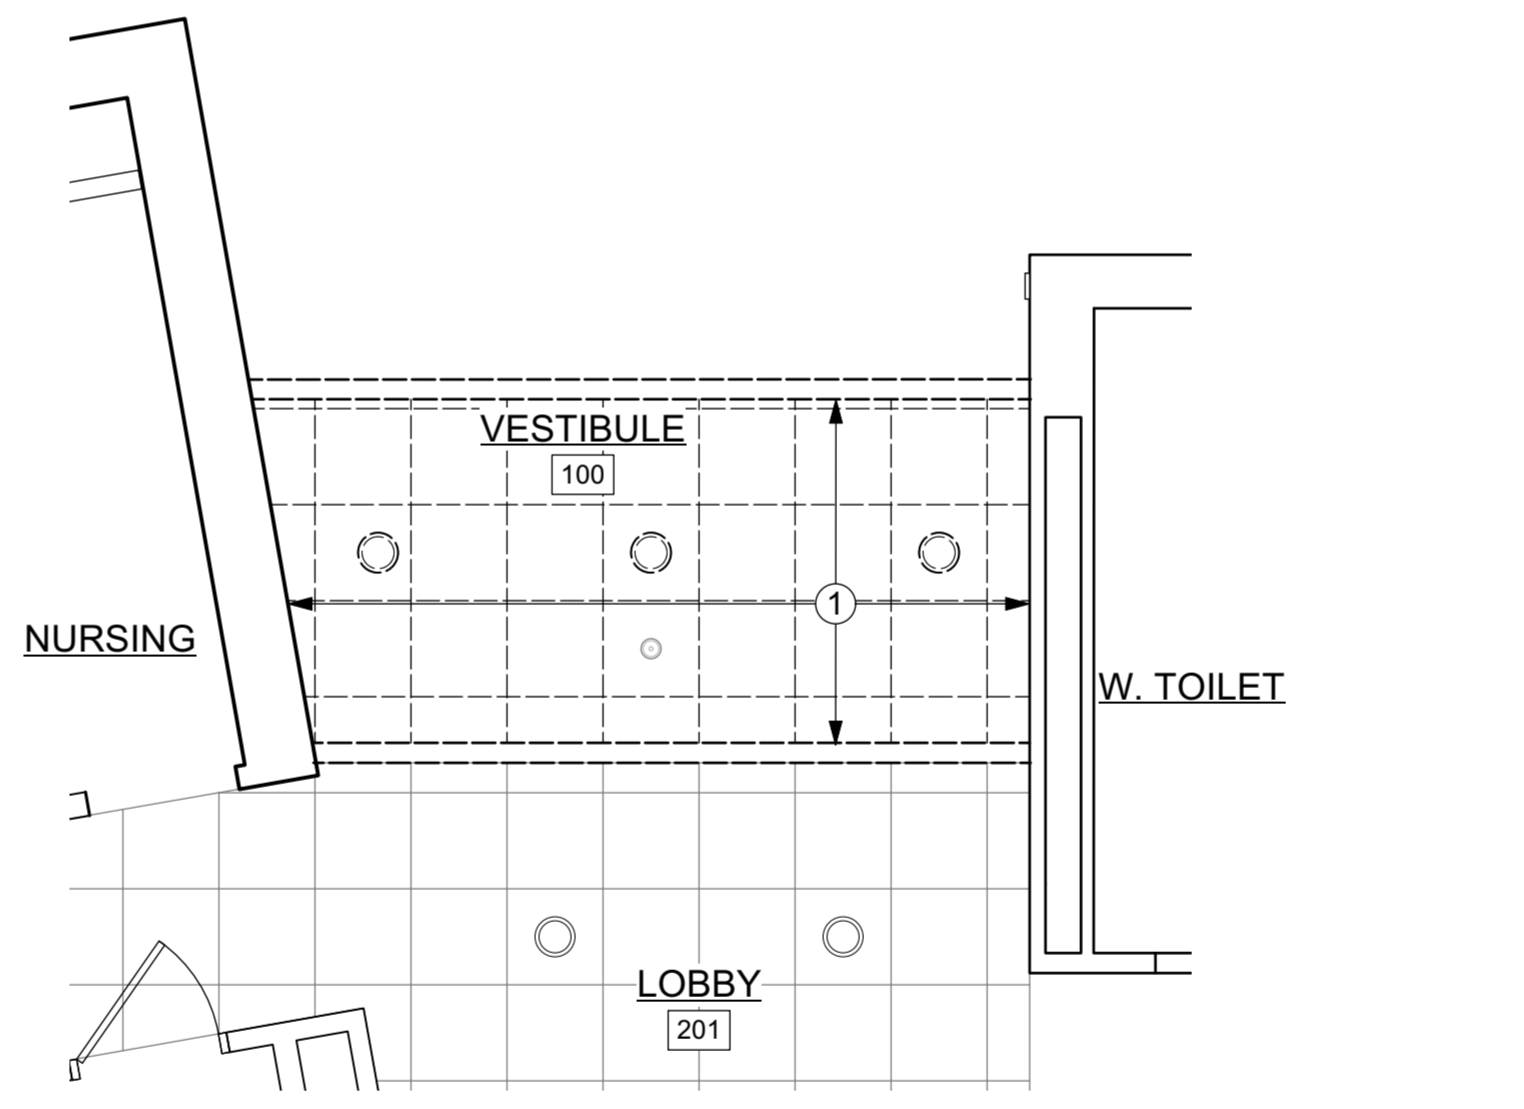

3 FIRST FLOOR VESTIBULE REFELCTED CEILING PLAN - PROPOSED
Scale: 1/4" = 1'-0" NORTH

REFLECTED CEILING PLAN REMOVAL NOTES

- ① REMOVE CEILING TILE AND GRID

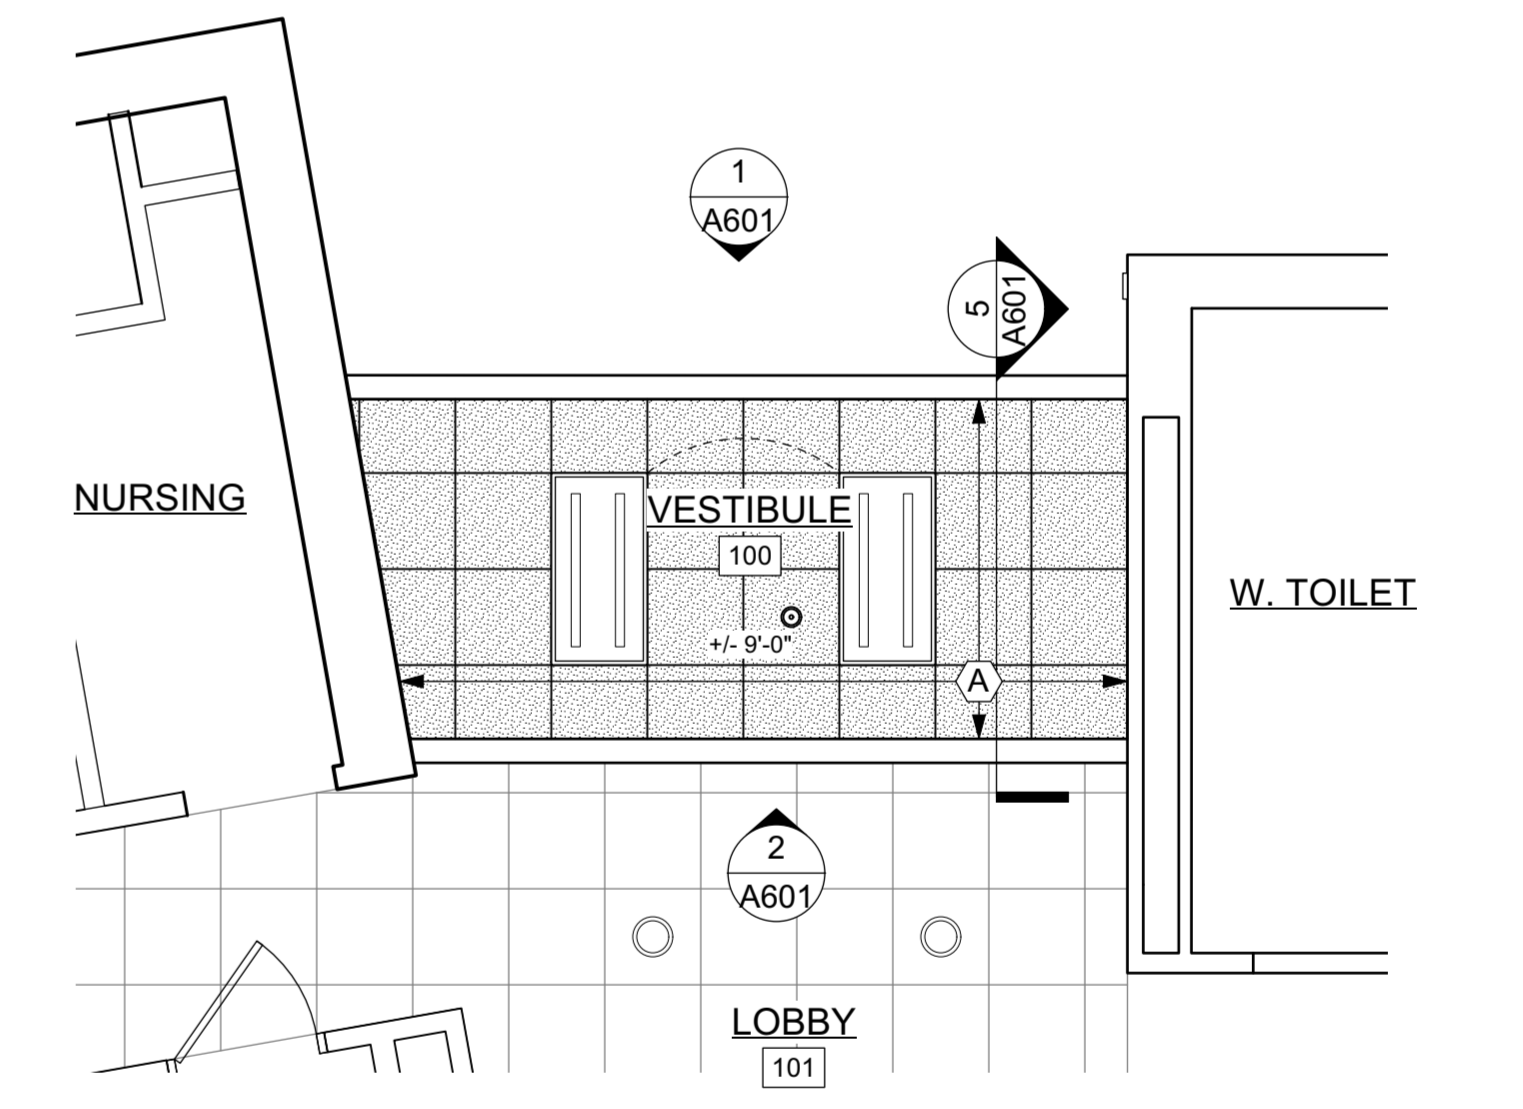

4 FIRST FLOOR VESTIBULE REFLECTED CEILING PLAN - PROPOSED
Scale: 1/4" = 1'-0" NORTH

CEILING CONSTRUCTION NOTES:

- Ⓐ NEW GRID AND CEILING TILE; ALIGN WITH EXISTING WHERE NEW AND OLD ABUTT EACH OTHER

CEILING LEGEND

- ☒ SUPPLY
- ☒ TRANSFER GRILLE, SEE M101
- ☐ LIGHT FIXTURE
- SP EXISTING SPEAKER
- ⊙ SPRINKLER HEAD
- OS CEILING MOUNTED OCCUPANCY SENSOR (N - NEW; E-EXISTING)
- \$ SWITCHING (N FOR NEW, E FOR EXISTING)

ACP NEW / RESTORED SUSPENDED ACOUSTICAL PANEL CEILING SYSTEM
MATCH EXISTING WHERE APPLICABLE
ACP - ACOUSTICAL PANEL CEILING SYSTEM

ACP DEMOLITION SUSPENDED ACOUSTICAL PANEL CEILING SYSTEM

X- EXISTING CEILING EQUIPMENT
+###-## CEILING HEIGHT ABOVE FINISH FLOOR

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1ST AND 2ND FLOOR COUNTER REMODEL AND ENTRANCE REPLACEMENT CITY OF SUN PRAIRIE Sun Prairie, WI

Sheet Title:
FIRST FLOOR ENTRY DOORS PLANS, SECTIONS, AND ELEVATIONS

Revisions:

No.	Date	Description
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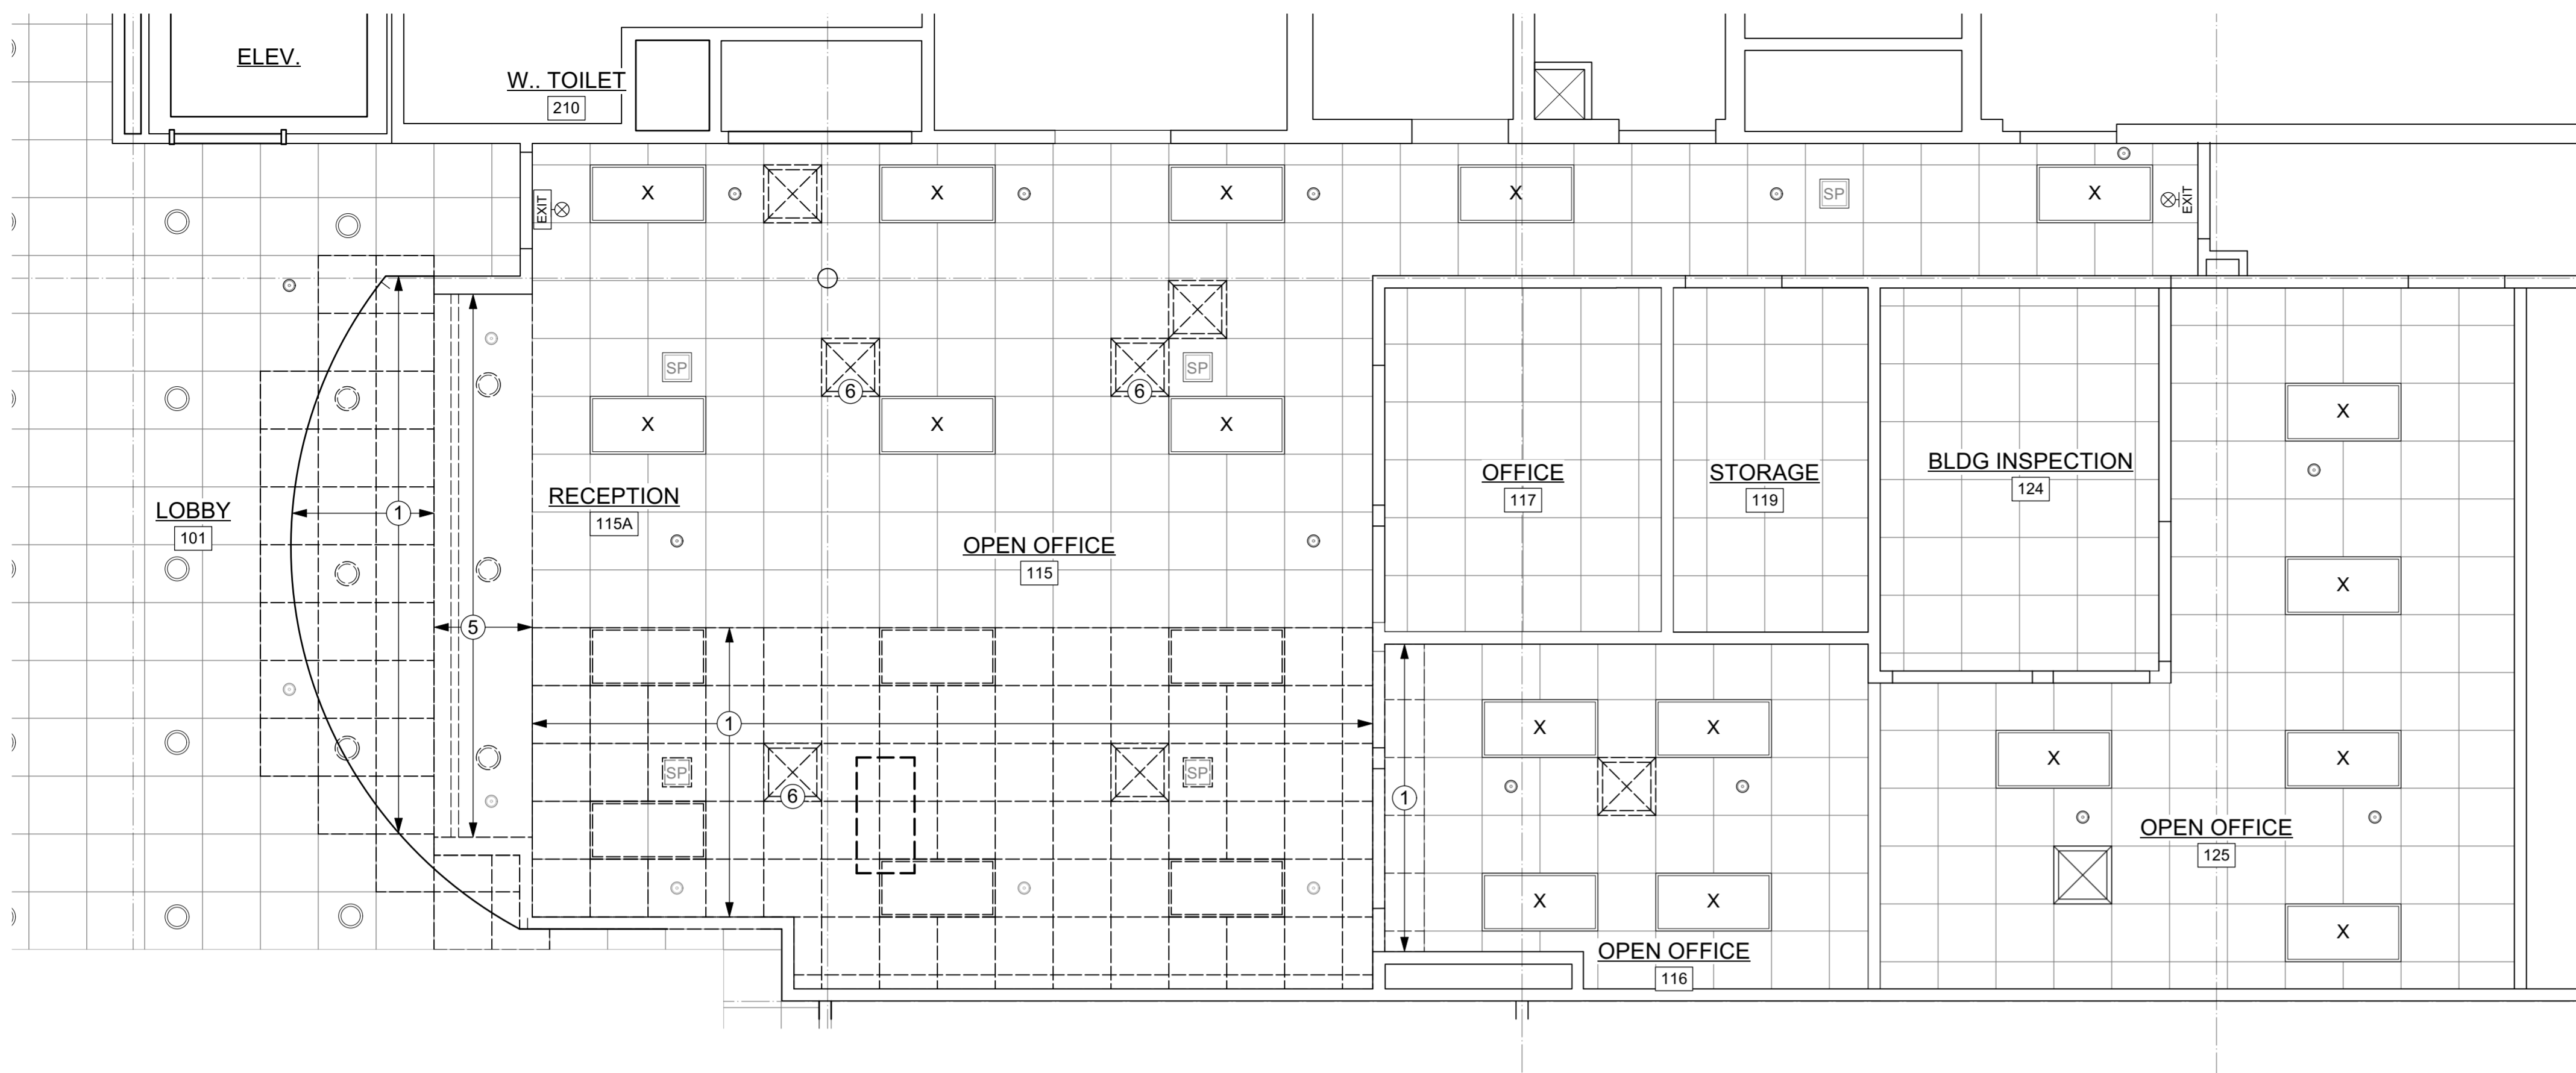
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Project Number: 2138


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Date Issued: 04/21/2023

Sheet Number: **A102**



1 FIRST FLOOR REFLECTED CEILING DEMOLITION PLAN
Scale: 1/4" = 1'-0"

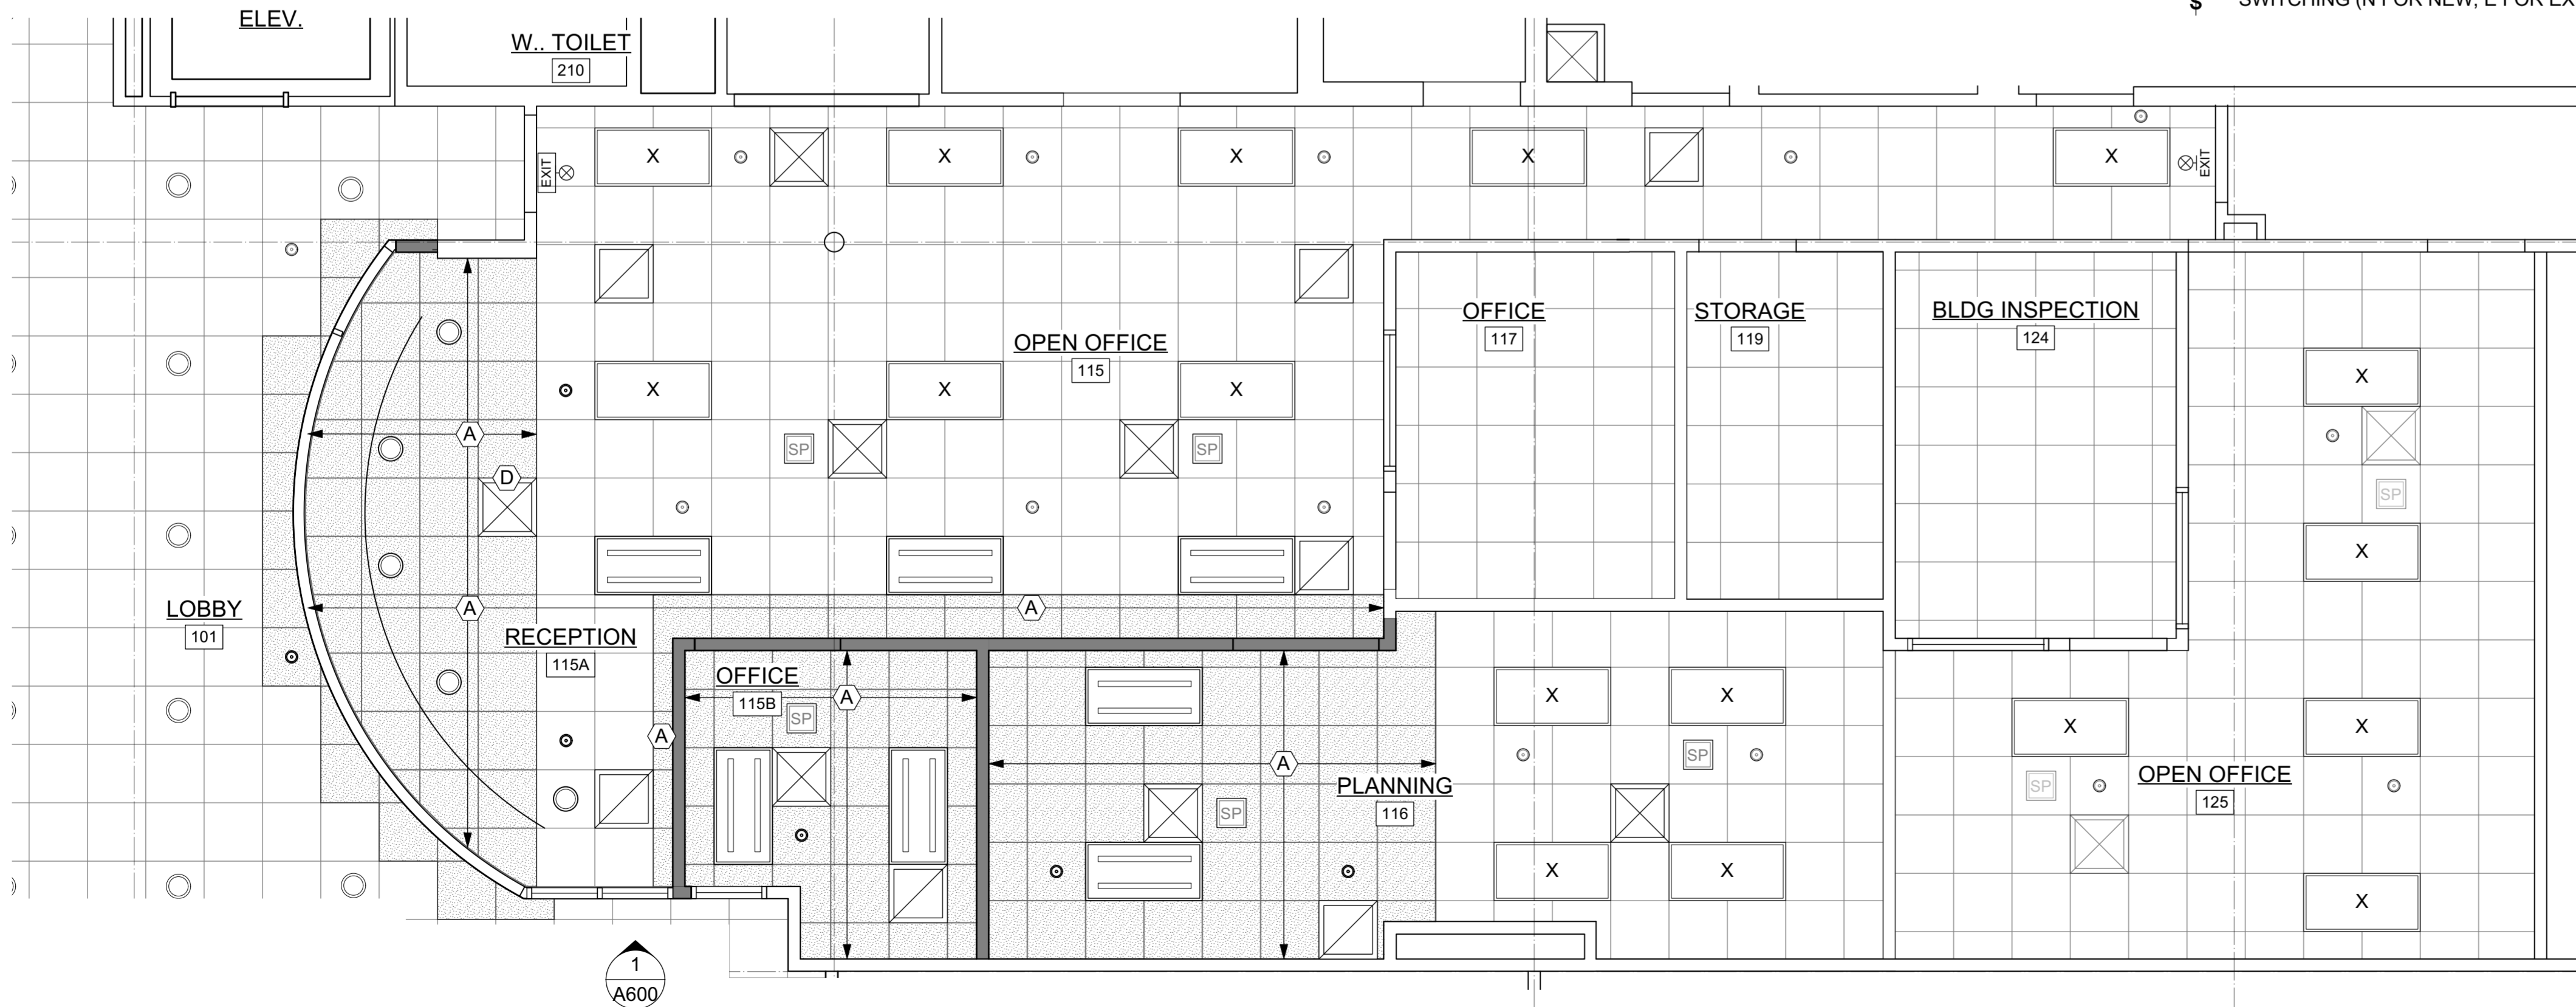

2 FIRST FLOOR REFLECTED CEILING PLAN
Scale: 1/4" = 1'-0"

REFLECTED CEILING PLAN REMOVAL NOTES

- ① REMOVE CEILING TILE AND GRID
- ⑤ REMOVE GYPSUM BOARD SOFFIT

CEILING LEGEND

- SUPPLY
- TRANSFER GRILLE, SEE M101
- LIGHT FIXTURE
- EXISTING SPEAKER
- SPRINKLER HEAD
- CEILING MOUNTED OCCUPANCY SENSOR (N - NEW; E-EXISTING)
- SWITCHING (N FOR NEW, E FOR EXISTING)

- NEW / RESTORED SUSPENDED ACOUSTICAL PANEL CEILING SYSTEM
MATCH EXISTING WHERE APPLICABLE
ACP - ACOUSTICAL PANEL CEILING SYSTEM
- DEMOLITION SUSPENDED ACOUSTICAL PANEL CEILING SYSTEM
- X- EXISTING CEILING EQUIPMENT
- ###-### CEILING HEIGHT ABOVE FINISH FLOOR

CEILING CONSTRUCTION NOTES:

- Ⓐ NEW GRID AND CEILING TILE; ALIGN WITH EXISTING WHERE NEW AND OLD ABUTT EACH OTHER

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**1ST AND 2ND FLOOR COUNTER REMODEL
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Sun Prairie, WI**
Sheet Title:
FIRST FLOOR REFLECTED CEILING PLANS

Revisions:	
No.	Description:
02/10/2023	Plan Review Documents


Graphic Scale:

Project Number: 2138

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Sheet Number: **A400**



1 SECOND FLOOR REFLECTED CEILING DEMOLITION PLAN
Scale: 1/4" = 1'-0"

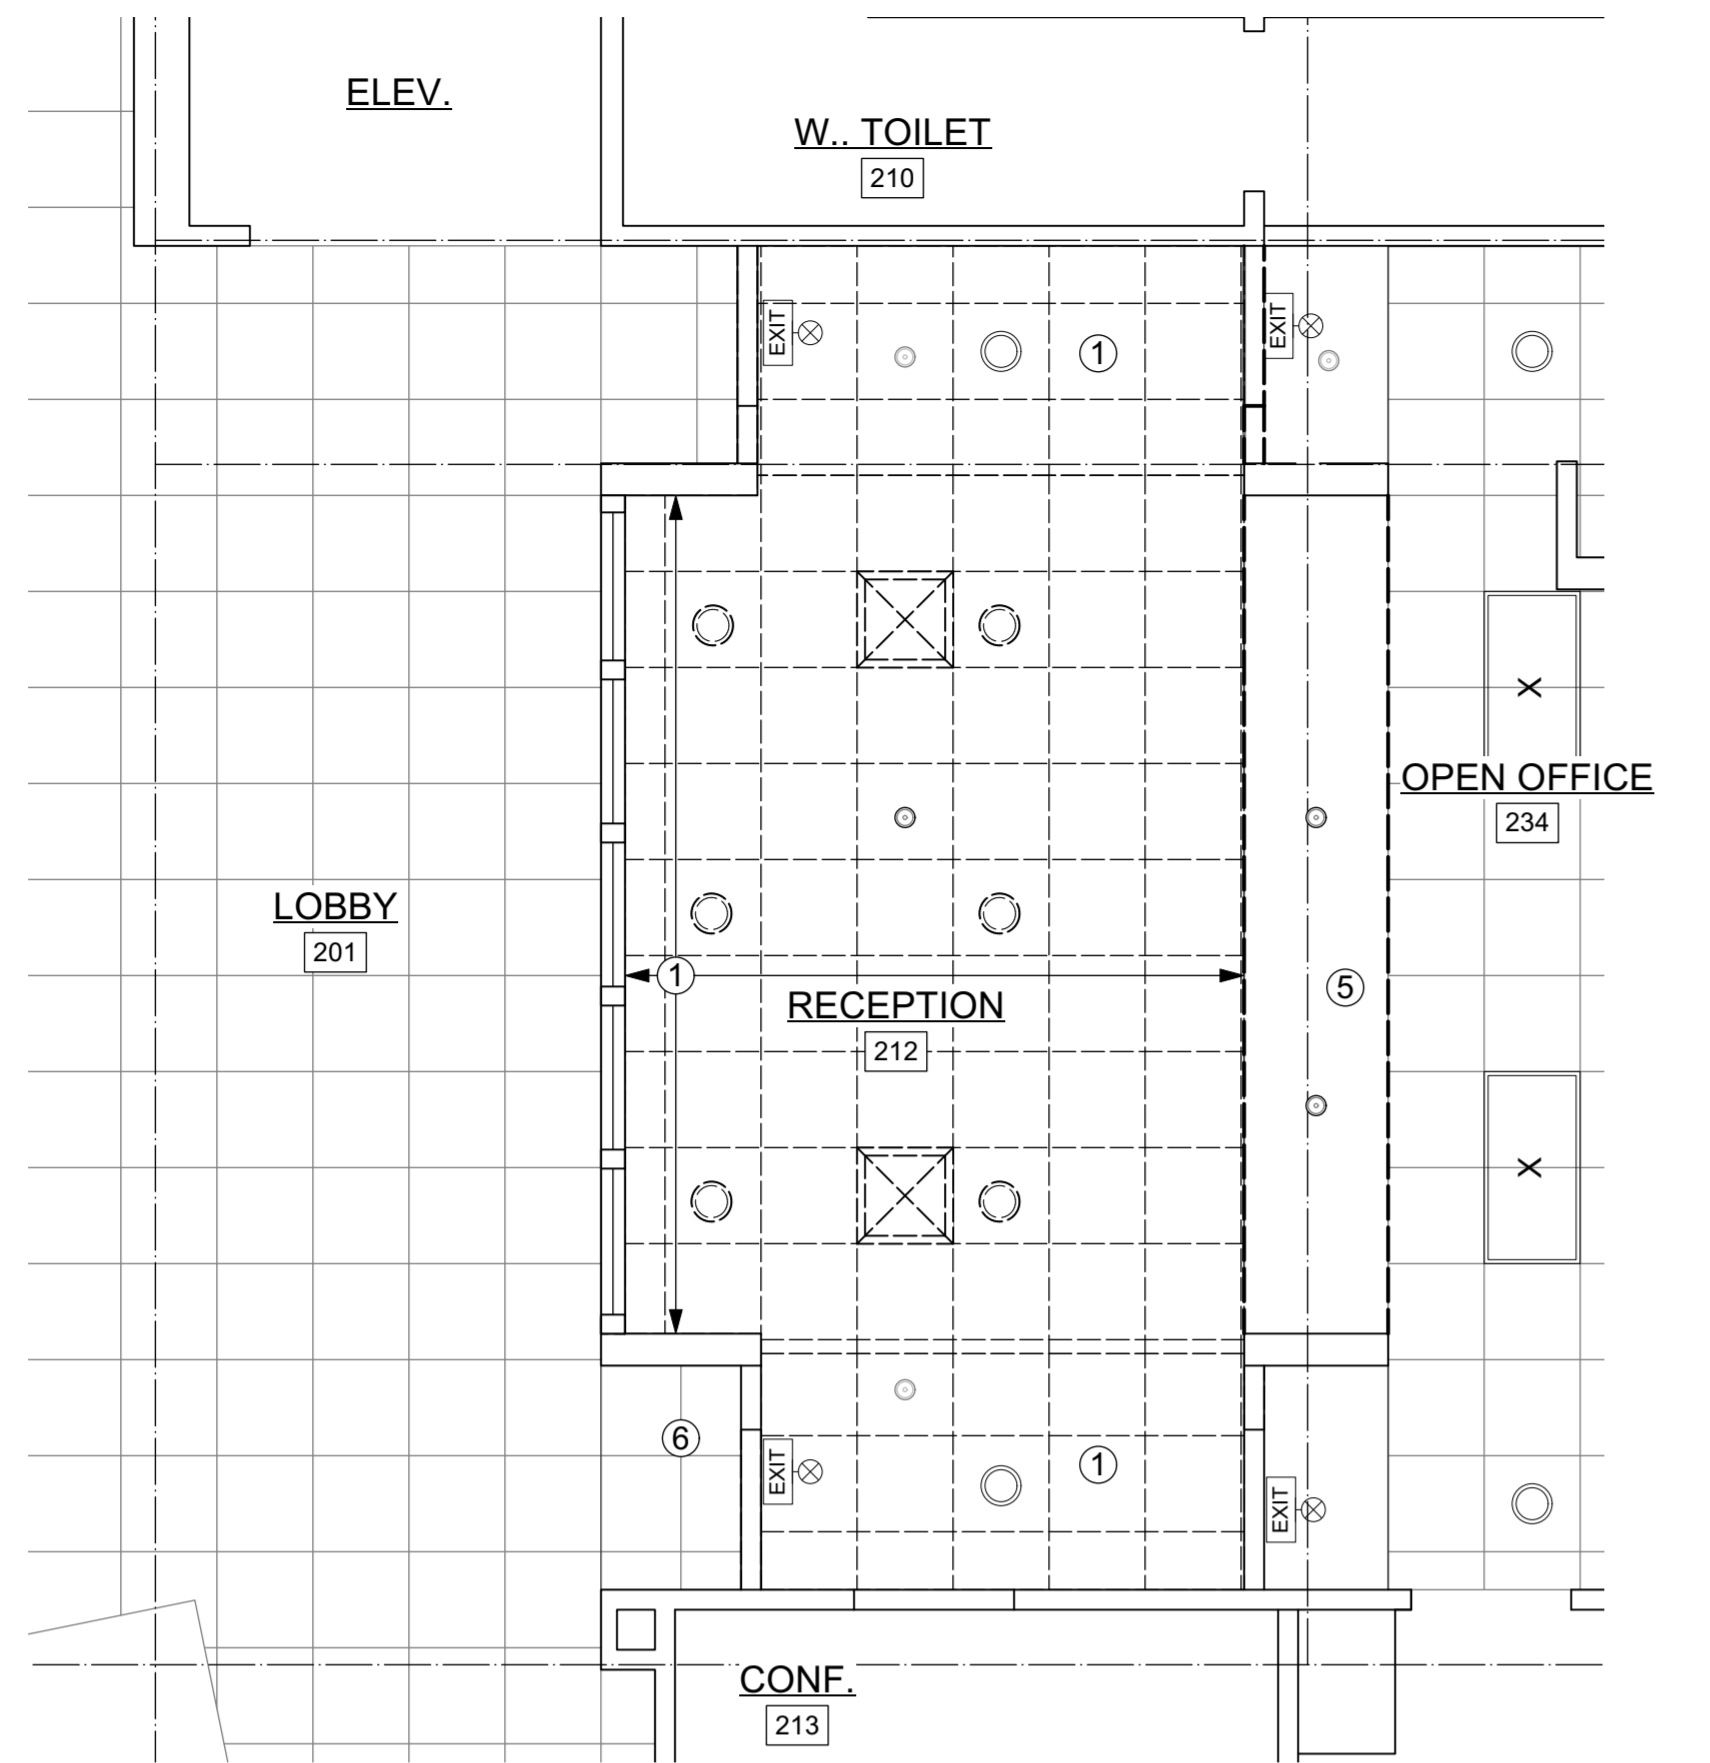

REFLECTED CEILING PLAN REMOVAL NOTES

- ① REMOVE CEILING TILE AND GRID
- ⑤ REMOVE GYPSUM BOARD SOFFIT


GENERAL REFLECTED CEILING NOTES:

1. EXISTING FIRE RATED WALLS SHALL NOT BE COMPROMISED WITH NEW FRAMING, HVAC OR ELECTRICAL WORK.
2. VERIFY LOCATION OF EXISTING MECHANICAL AND ELECTRICAL BEFORE NEW CONSTRUCTION BEGINS
3. IN THE AREAS OF WORK ALL GRILLES WILL BE REPLACED AND DUCTS CLEANED BACK TO THE MAIN
4. PROTECT ANY CEILING EQUIPMENT THAT IS TO REMAIN

CEILING LEGEND

- SUPPLY
- TRANSFER GRILLE. SEE M101
- LIGHT FIXTURE
- EXISTING SPEAKER
- SPRINKLER HEAD
- CEILING MOUNTED OCCUPANCY SENSOR (N - NEW; E-EXISTING)
- SWITCHING (N FOR NEW, E FOR EXISTING)

- NEW / RESTORED SUSPENDED ACOUSTICAL PANEL CEILING SYSTEM
MATCH EXISTING WHERE APPLICABLE
ACP - ACOUSTICAL PANEL CEILING SYSTEM
- DEMOLITION SUSPENDED ACOUSTICAL PANEL CEILING SYSTEM
- X- EXISTING CEILING EQUIPMENT
- +##-## CEILING HEIGHT ABOVE FINISH FLOOR

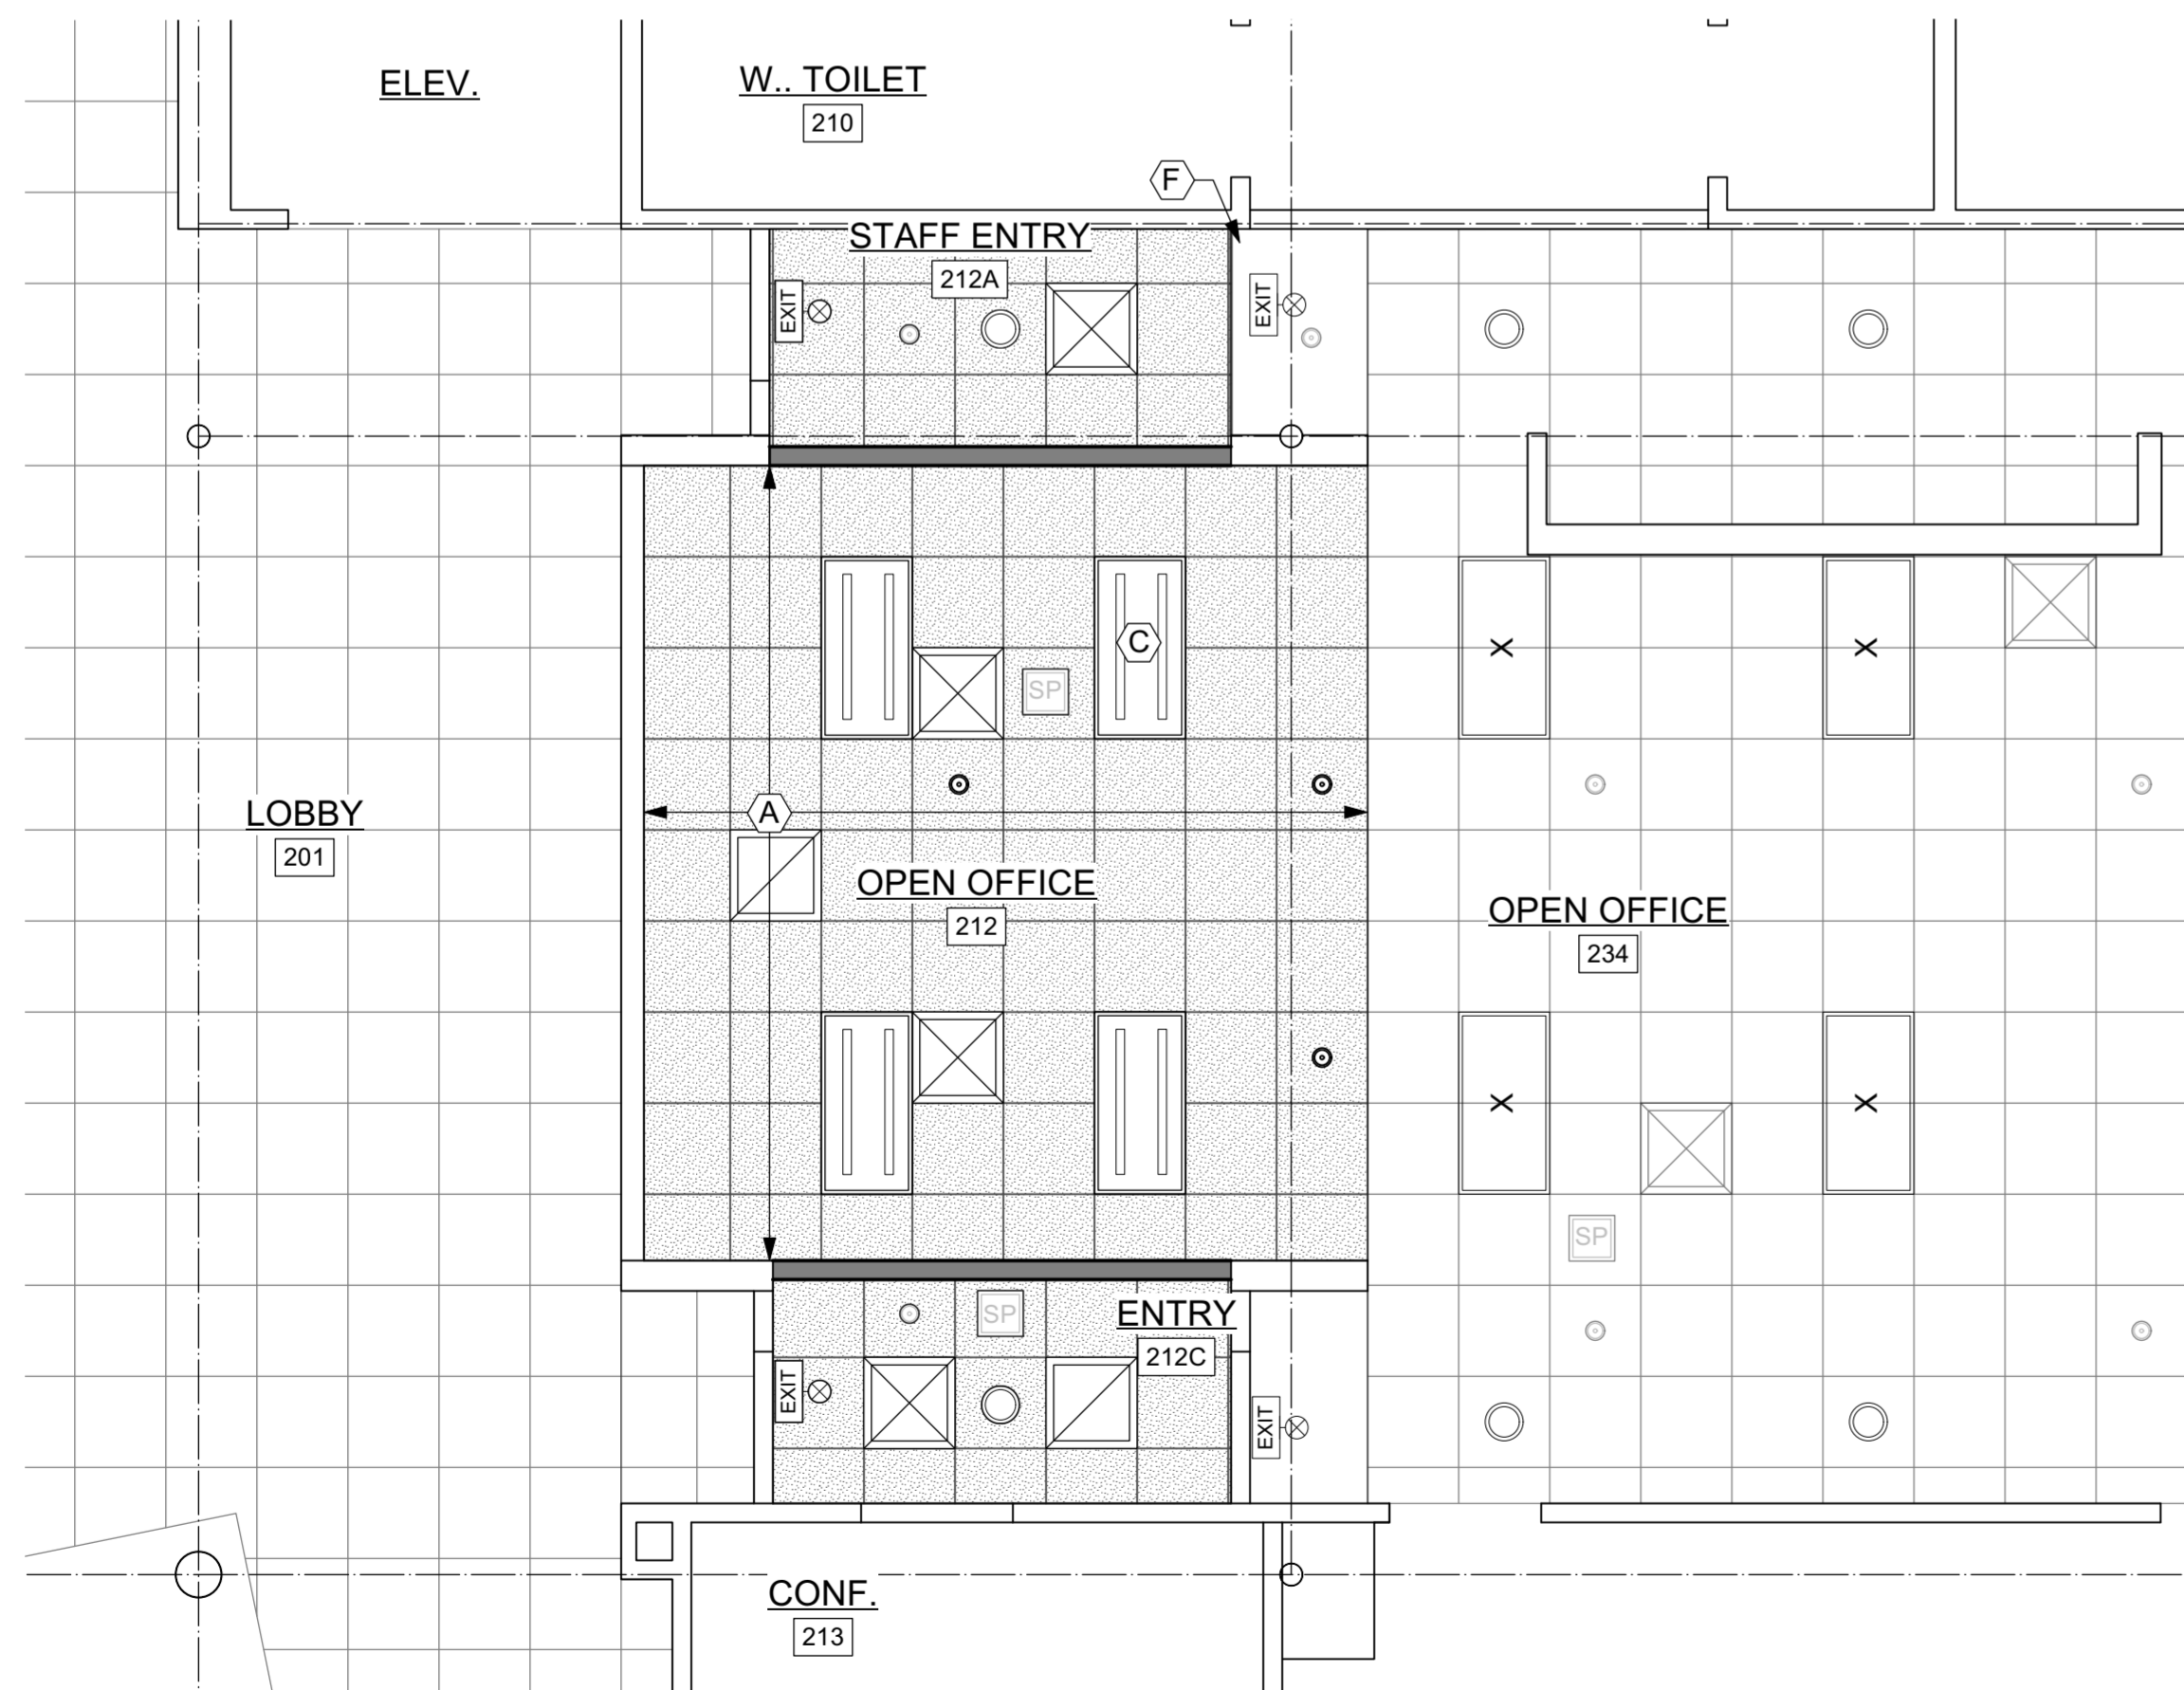

2 SECOND FLOOR REFLECTED CEILING PLAN
Scale: 1/4" = 1'-0"



CEILING CONSTRUCTION NOTES:

- Ⓐ NEW GRID AND CEILING TILE; ALIGN WITH EXISTING WHERE NEW AND OLD ABUTT EACH OTHER
- Ⓕ PATCH SOFFIT WHERE DOOR AND WALL REMOVED

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**1ST AND 2ND FLOOR COUNTER REMODEL
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Sheet Title:
SECOND FLOOR REFLECTED CEILING PLANS

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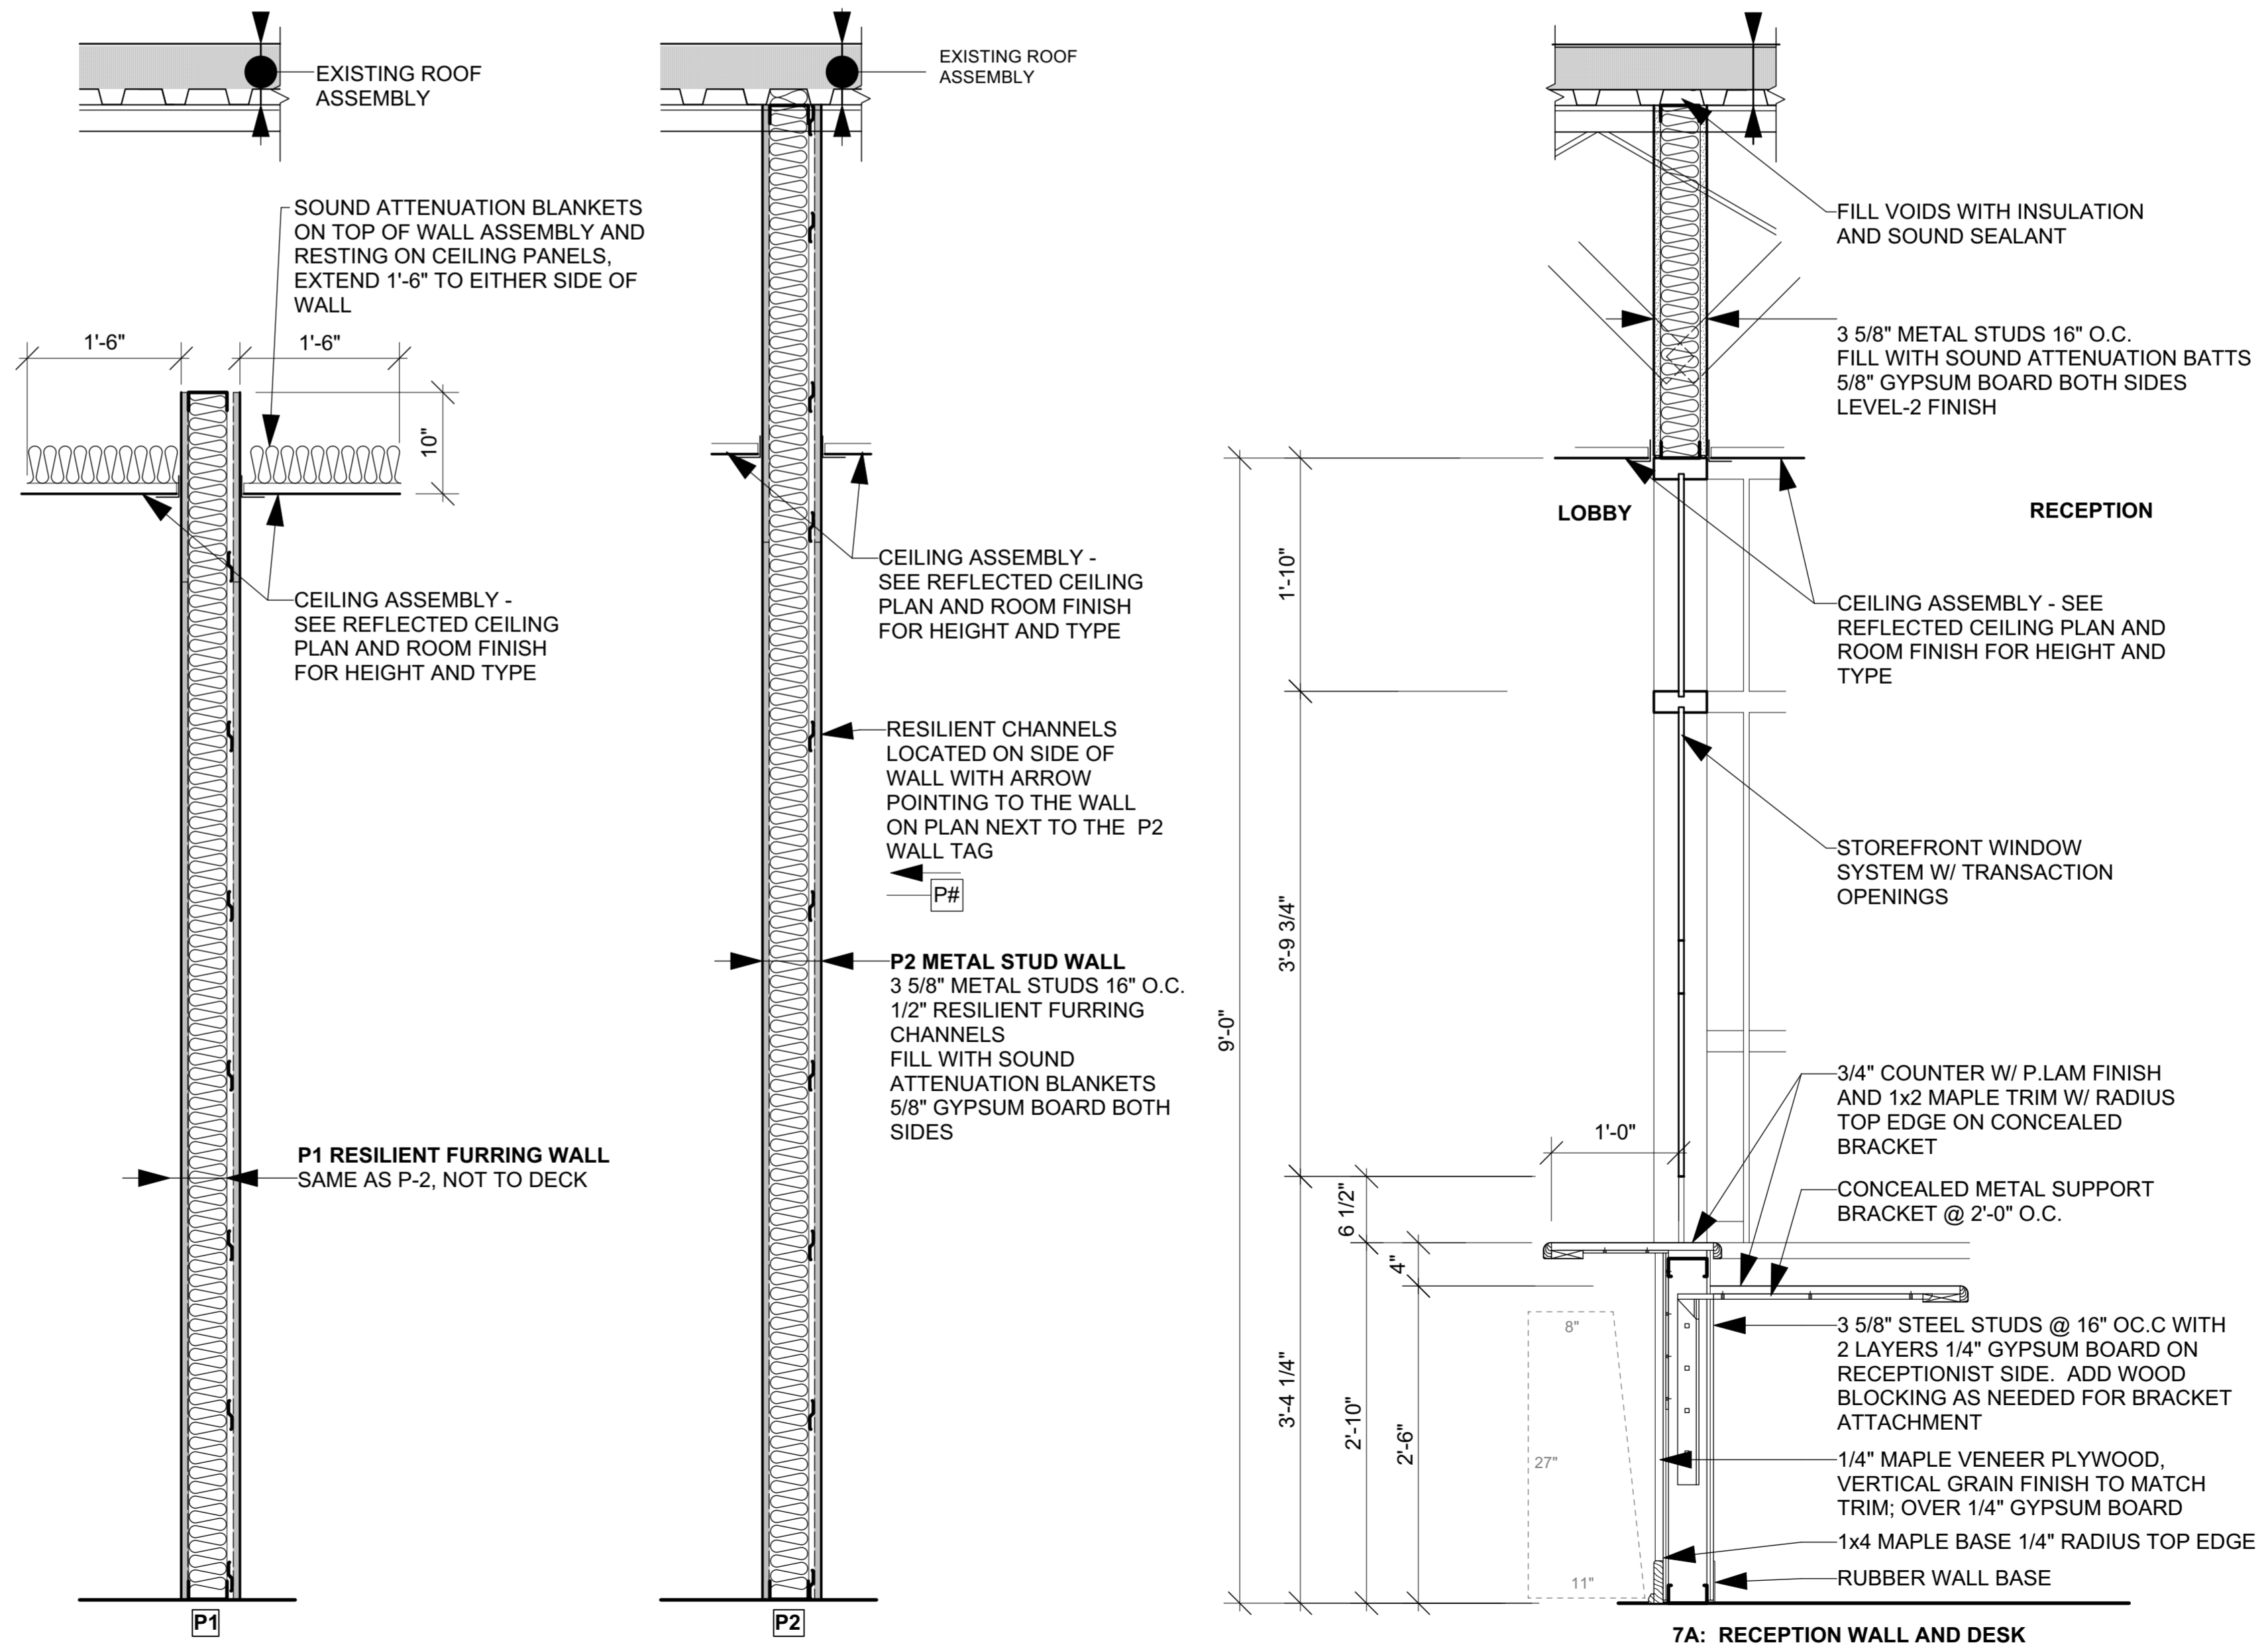
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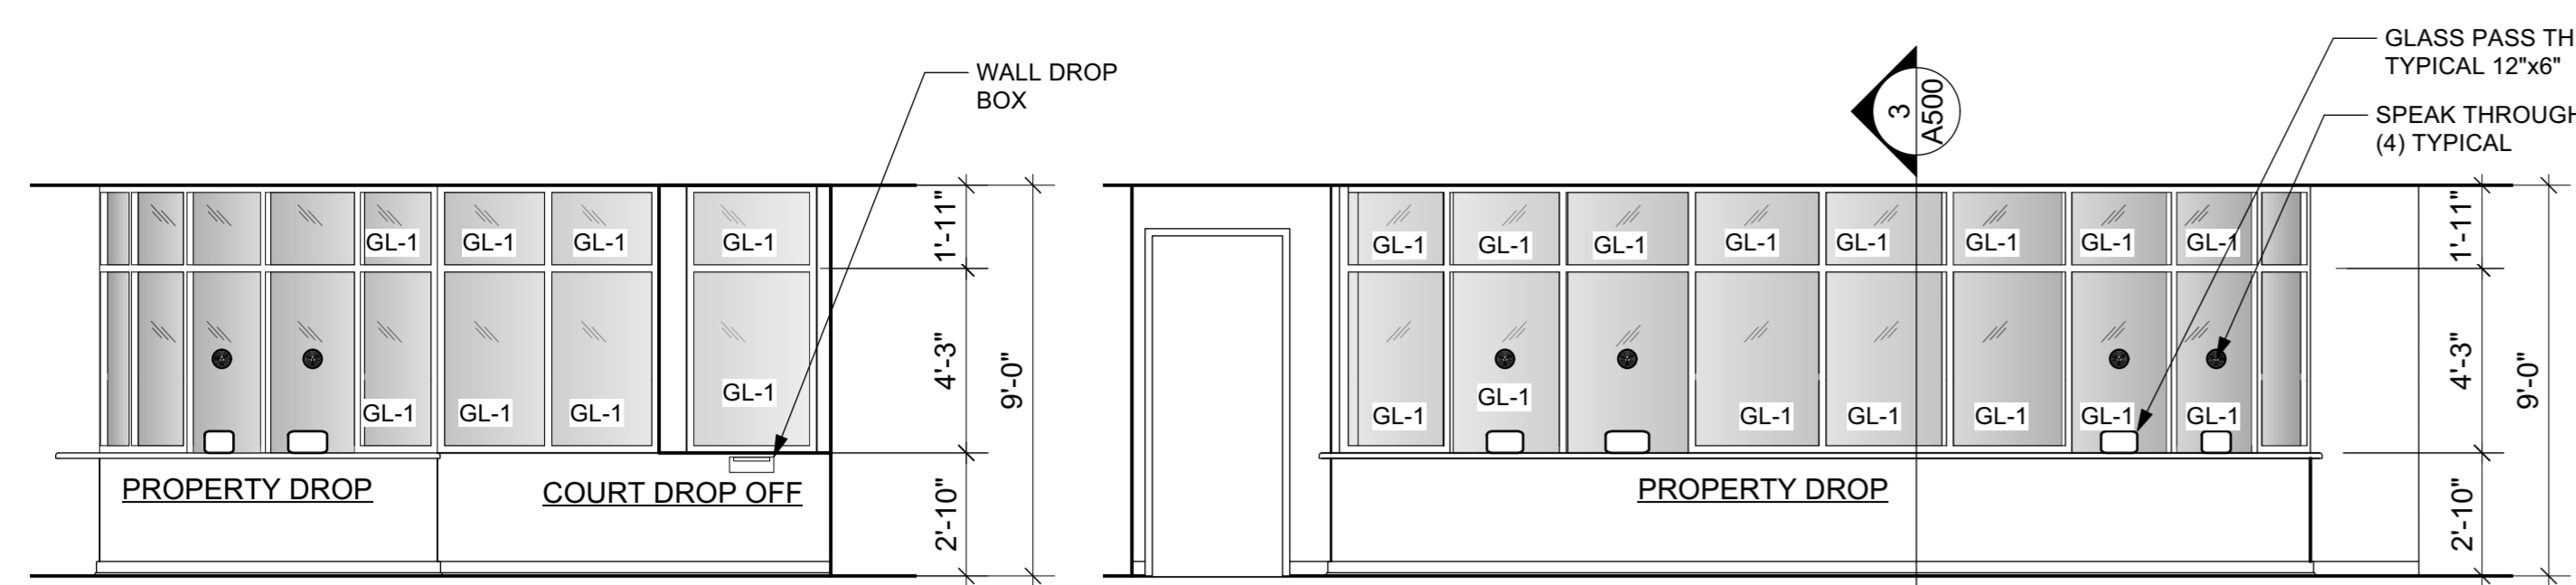
Sheet Number: **A401**

No.	Date	Description
02	10/20/23	Plan Review Documents



1 WALL PARTITION TYPES
Scale: 1" = 1'-0"

2 SPECIAL WALL CONDITIONS
Scale: 1" = 1'-0"



ROLLER SHADE NOTES

ROLLER SHADES TO BE HUNG INSIDE JAMBS OF THE LOWER STOREFRONT WINDOWS. SIZES VARY WITH THE CURVE. VERIFY SIZES PRIOR TO ORDERING. APPROXIMATE SIZES ARE AS FOLLOWS:
 [A] - 2'-3" x 4'-0"
 [B] - 3'-2" x 4'-0"
 [C] - 3'-9" x 4'-0"

RECEPTION DOOR SCHEDULE


TAG	DOOR				FRAME				DETAIL	HARD. SET
	SIZE	MAT	TYPE	FINISH	MAT.	TYPE	FINISH	GLAZING		
D-115	3'0"x7'-0"	X-WD	-	-	X-HM	F1	PT-5	-	8/A600	6
D-115B	3'0"x7'-0"	WD	A	FF	HM	F1	PT-5	GL-1	8/A600	4
D-116	3'0"x7'-0"	WD	A	FF	HM	F1	PT-5	GL-1	8/A600	5

ABBREVIATIONS:

- HM HOLLOW METAL
- PT-4 HIGH PERFORMANCE COATING HM FRAMES
- GL-1 TEMPERED GLASS - SEE SPECIFICATION 08 80 00
- WD WOOD
- X EXISTING MATERIAL

1 SOUTH ELEVATION MAIN DESK
Scale: 1/4" = 1'-0"

2 WEST ELEVATION MAIN DESK
Scale: 1/4" = 1'-0"

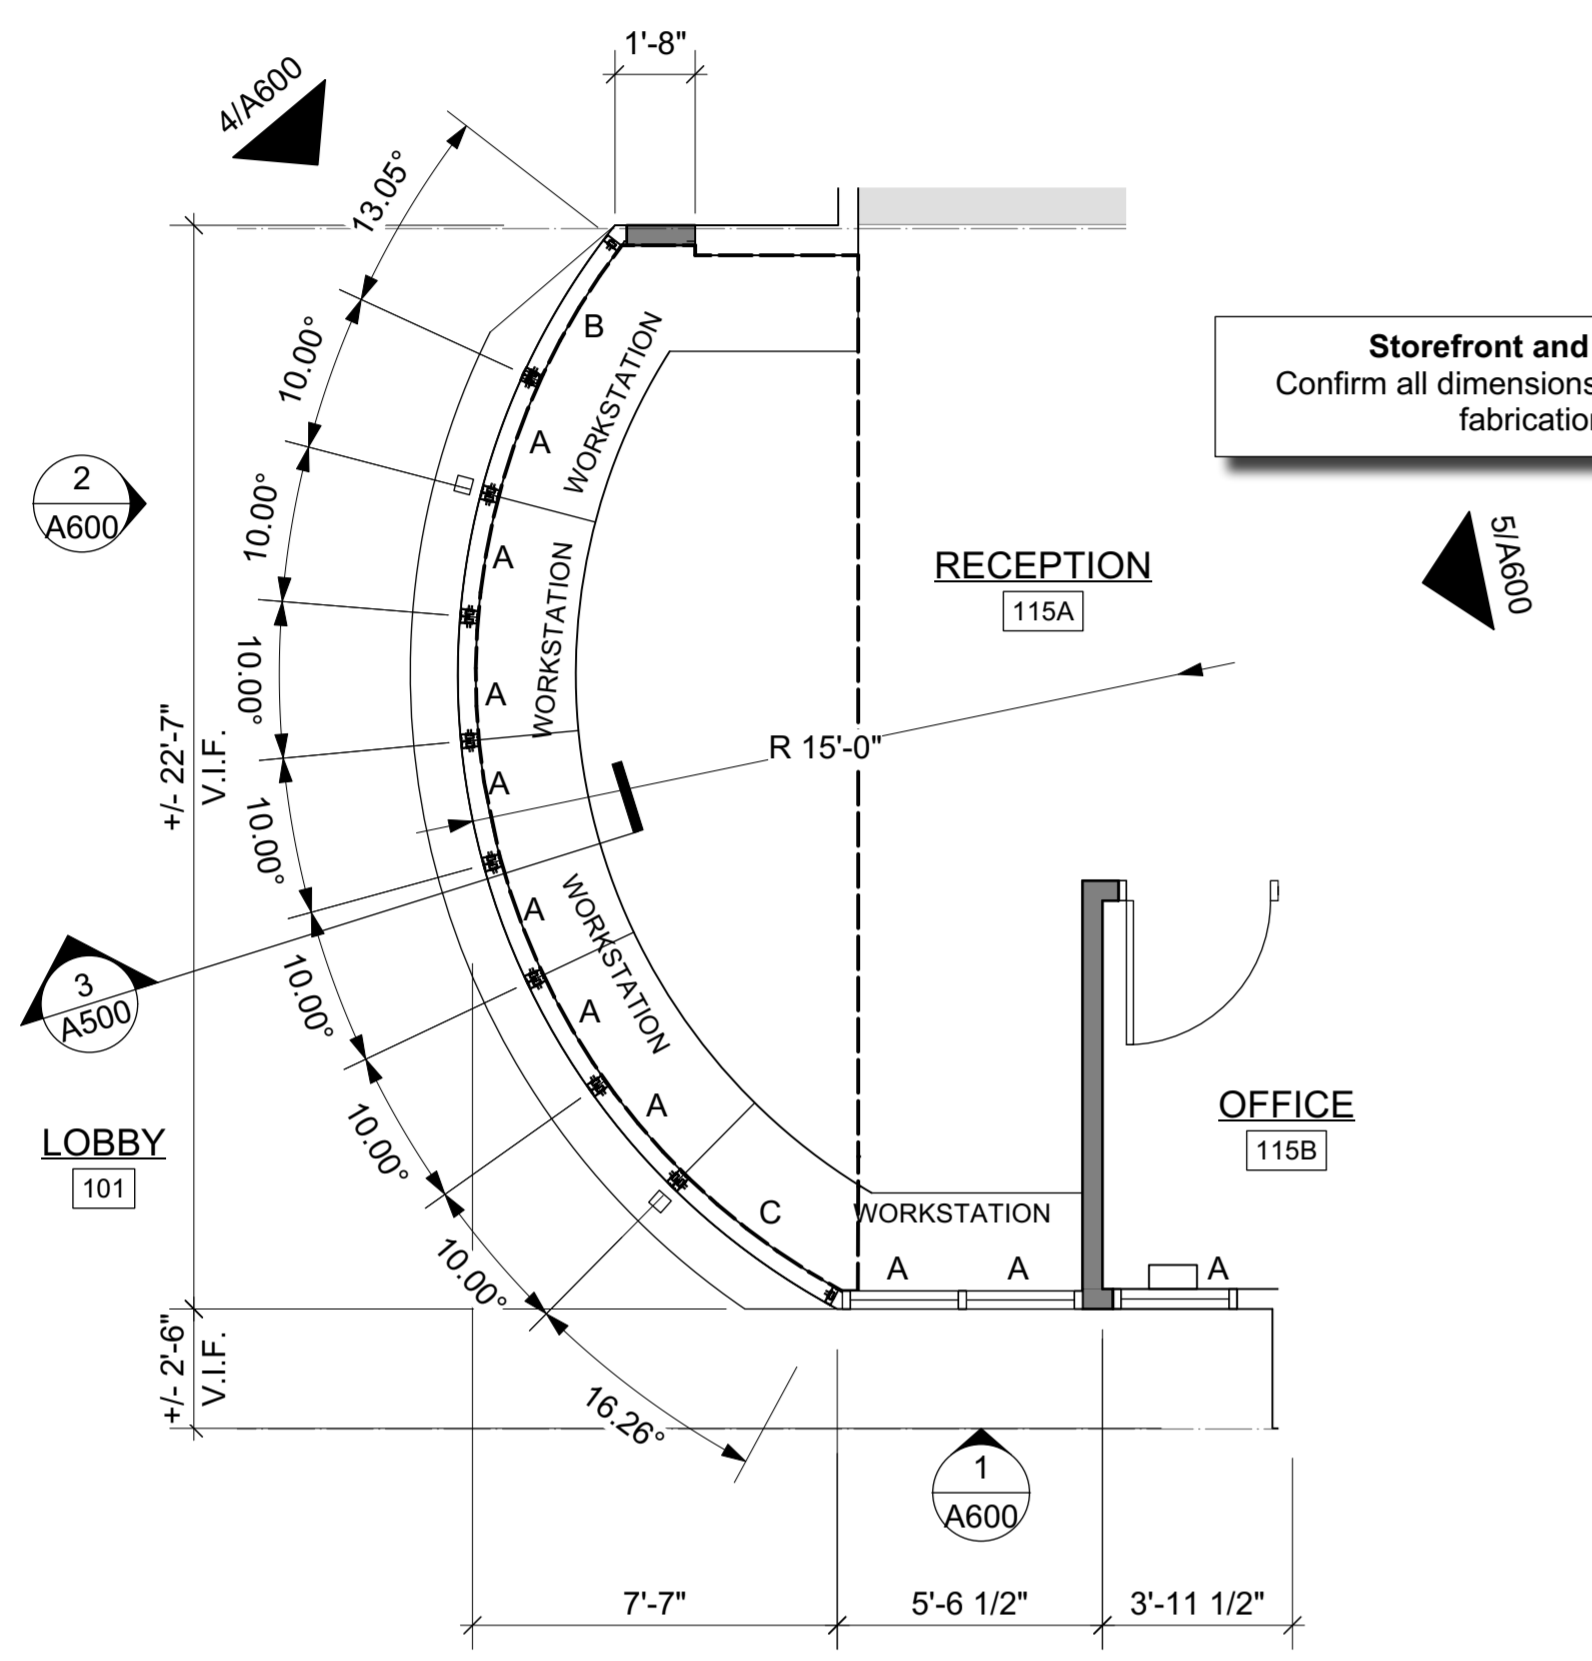

3 ALUMINUM STOREFRONT CURVE AND RECEPTION DESK CURVE
Scale: 1/4" = 1'-0"





4 FIRST FLOOR RECEPTION DESK W/ HALF WALL - VIEW 1
Scale: Not to Scale




5 FIRST FLOOR RECEPTION DESK W/ HALF WALL - VIEW 2
Scale: Not to Scale

Storefront and Blinds:
Confirm all dimensions if field prior to fabrication.

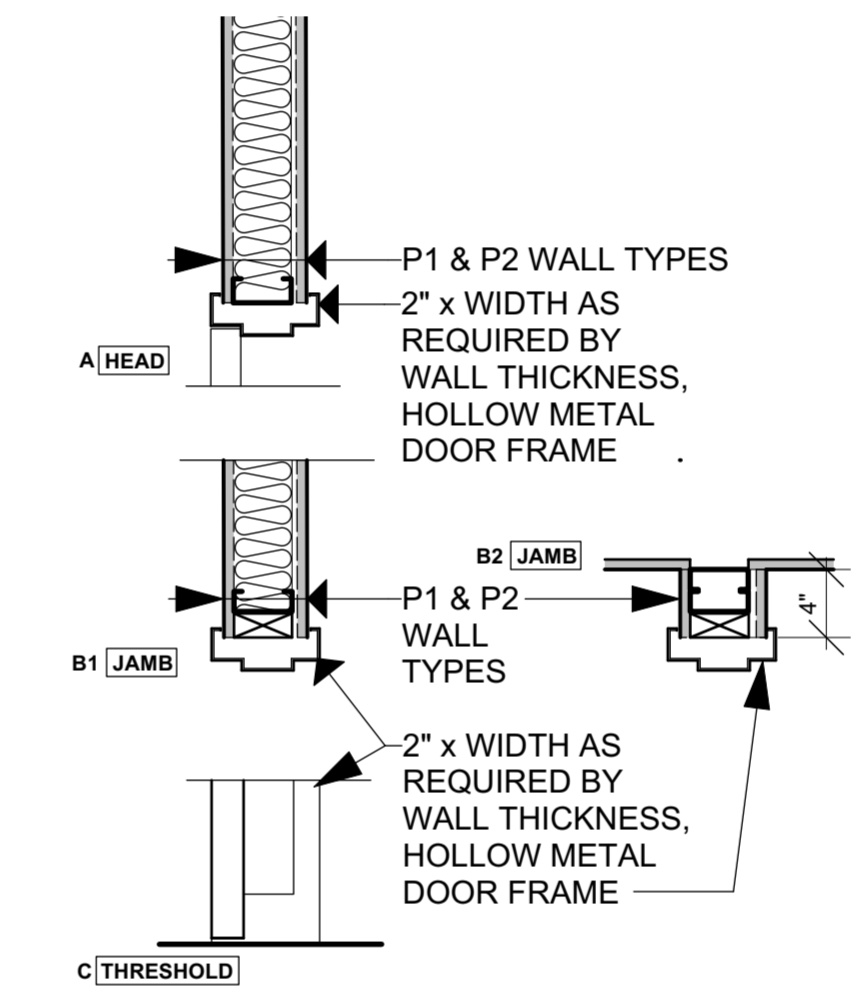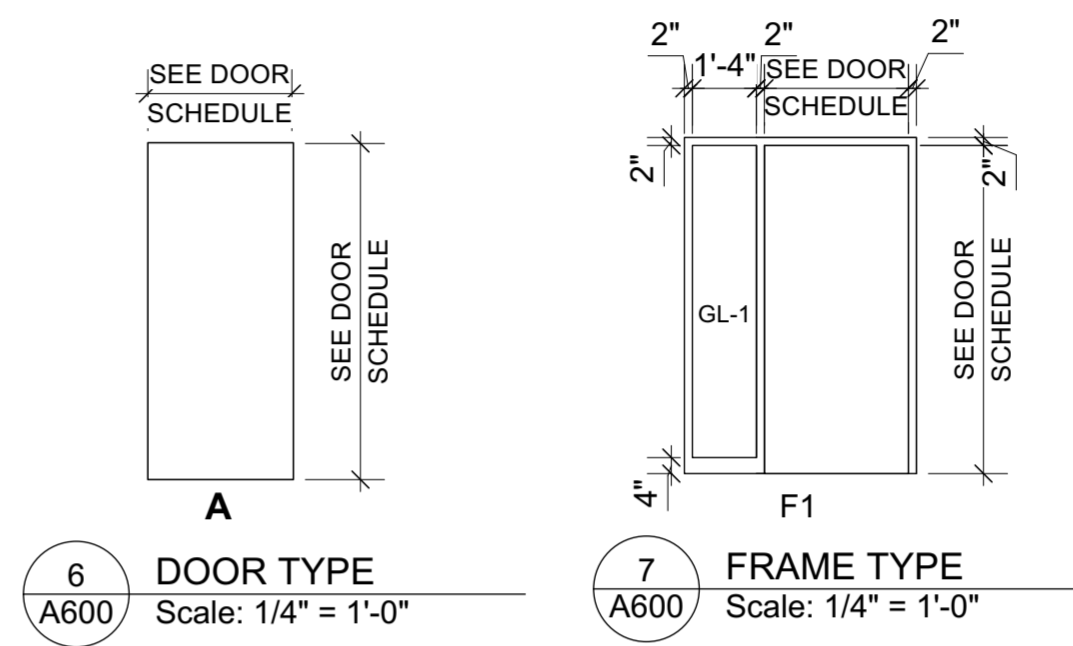

8 DOOR DETAIL
Scale: 1" = 1'-0"

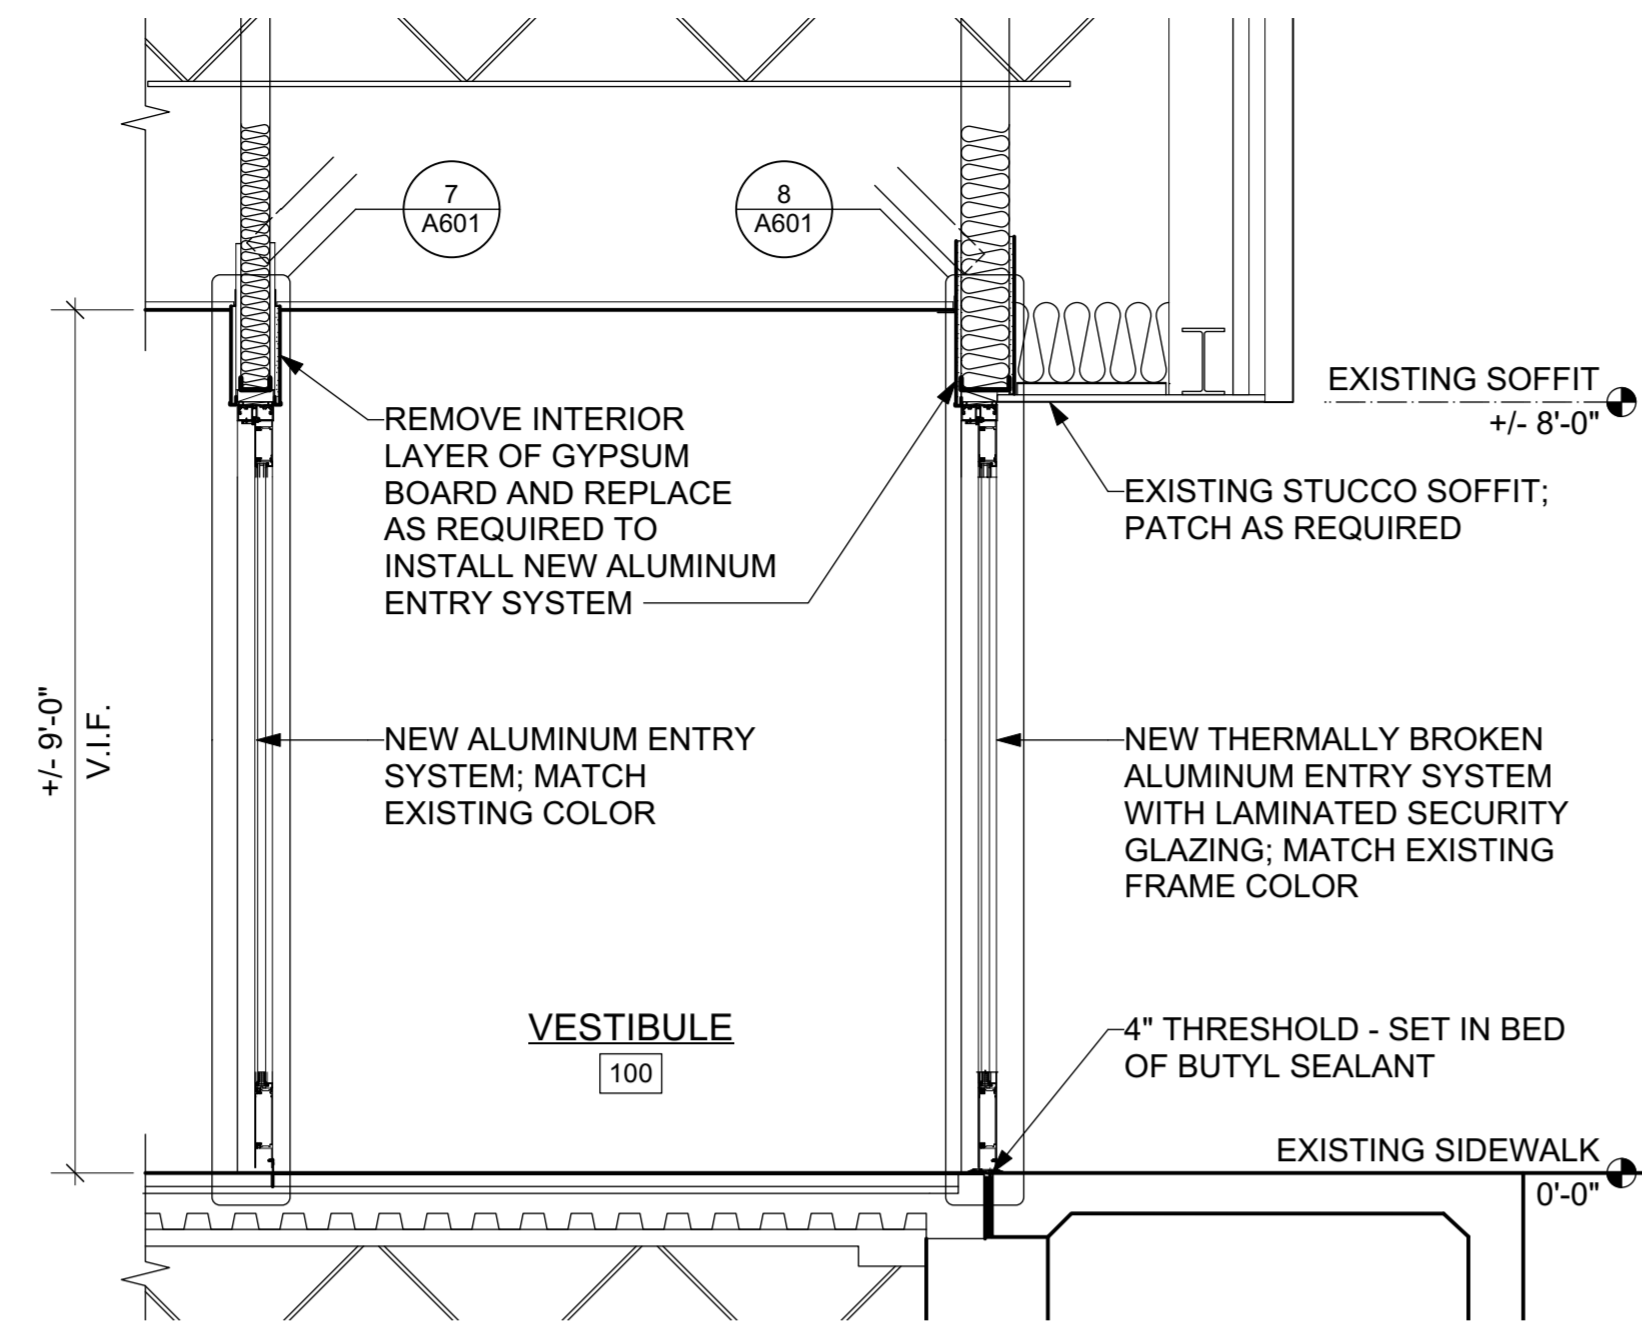


5 EXTERIOR ELEVATION LOOKING SOUTH
Scale: 1/2" = 1'-0"


DOOR SCHEDULE VESTIBULE

TAG	DOOR					FRAME			DETAIL	HARD.
	SIZE	MAT	TYPE	FINISH	GLAZING	MAT.	TYPE	FINISH		
D-100 A	3'0"x7'-10"	AL	SEE ELEV	FF	GL-2	AL	SEE ELEV	FF	6,7/A601	1
D-100 B	3'0"x7'-10"	AL	SEE ELEV	FF	GL-2	AL	SEE ELEV	FF	6,7/A601	1
D-100 C	3'0"x7'-10"	AL	SEE ELEV	FF	GL-2	AL	SEE ELEV	FF	6,7/A601	1
D-100 D	3'0"x7'-10"	AL	SEE ELEV	FF	GL-2	AL	SEE ELEV	FF	6,7/A601	2
D-100 E	3'0"x7'-10"	AL	SEE ELEV	FF	GL-1	AL	SEE ELEV	FF	6,7/A601	3
D-100 F	3'0"x7'-10"	AL	SEE ELEV	FF	GL-1	AL	SEE ELEV	FF	6,7/A601	3
D-100 G	3'0"x7'-10"	AL	SEE ELEV	FF	GL-1	AL	SEE ELEV	FF	6,7/A601	3
D-100 H	3'0"x7'-10"	AL	SEE ELEV	FF	GL-1	AL	SEE ELEV	FF	6,7/A601	3


- ABBREVIATIONS:**
 AL ALUMINUM
 FF FACTORY FINISH
 GL-1 INSULATED SECURITY GLAZING - SEE SPECIFICATION 08 80 00
 GL-2 TEMPERED GLAZING - SEE SPECIFICATION 08 80 00
 X EXISTING MATERIAL

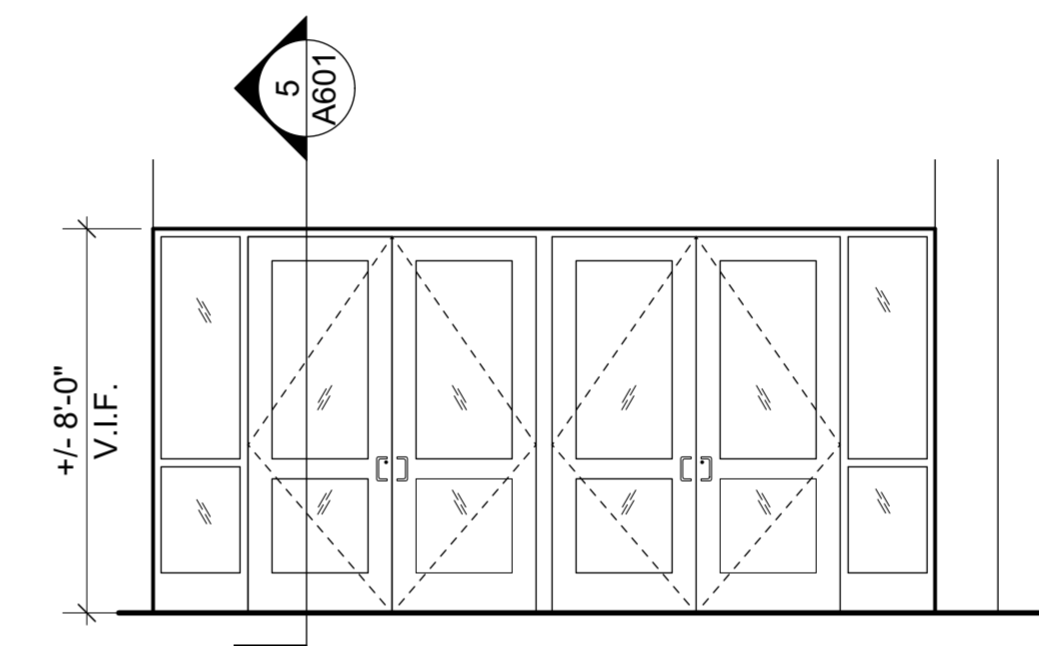


1 EXTERIOR DOOR ELEVATION LOOKING SOUTH
Scale: 1/4" = 1'-0"

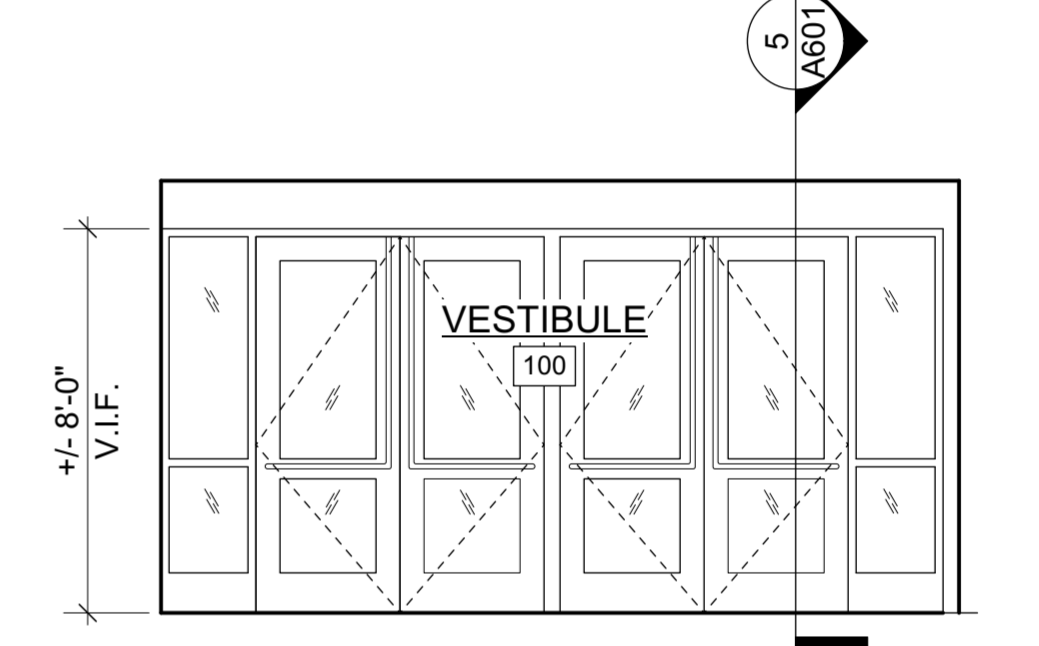


2 EXTERIOR DOOR ELEVATION LOOKING NORTH
Scale: 1/4" = 1'-0"

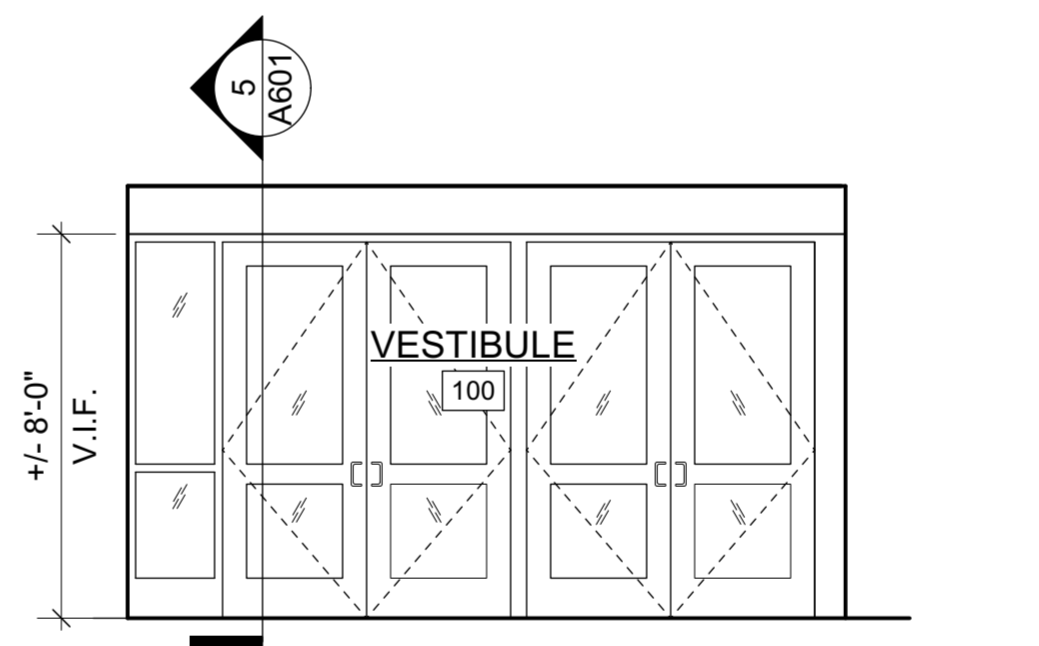


3 INTERIOR DOOR ELEVATION LOOKING SOUTH
Scale: 1/4" = 1'-0"

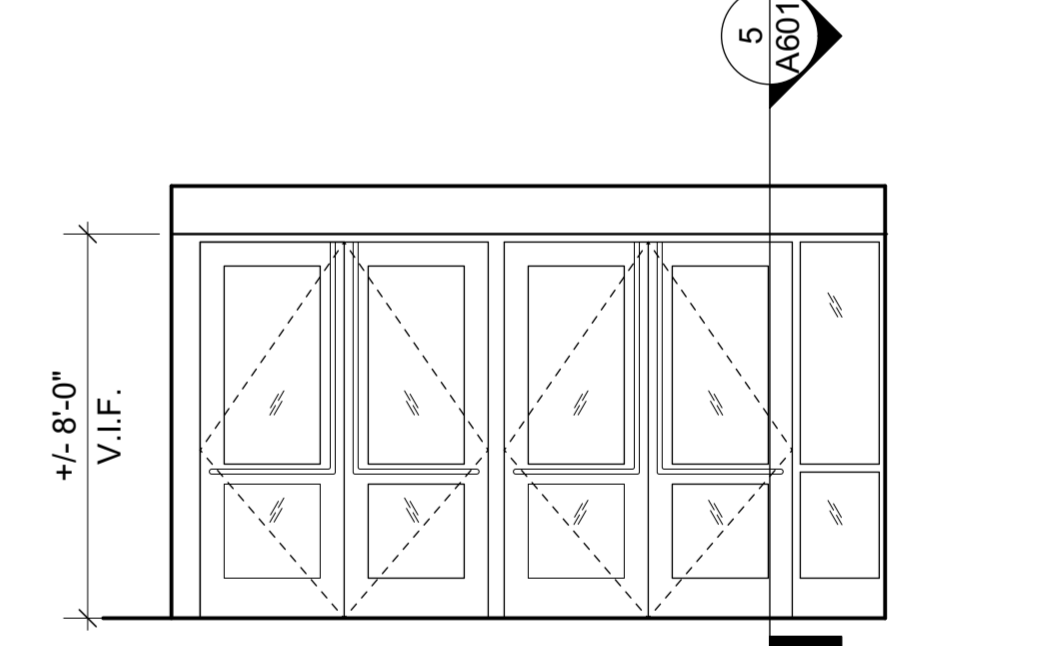

4 INTERIOR DOOR ELEVATION LOOKING NORTH
Scale: 1/4" = 1'-0"

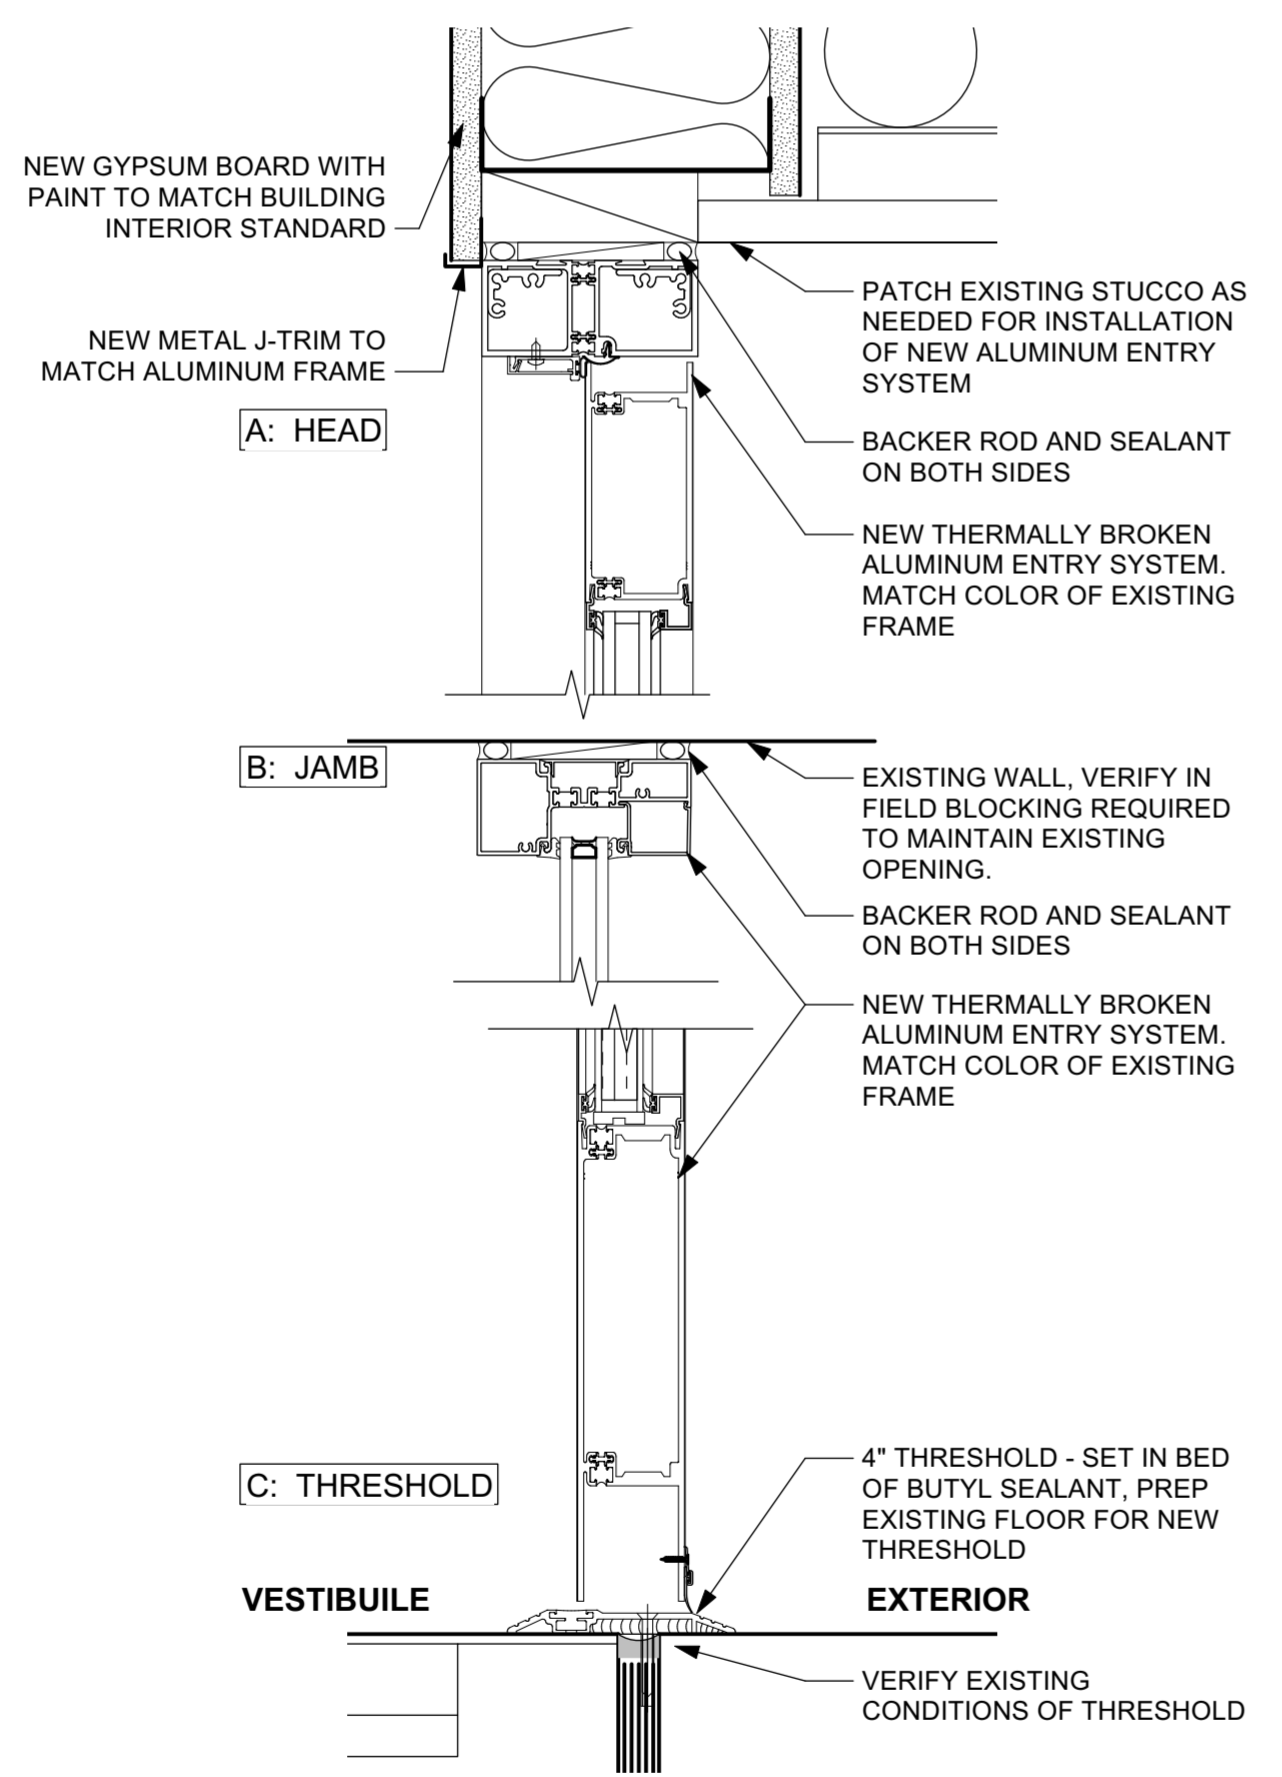

6 EXTERIOR DOOR DETAILS
Scale: 3" = 1'-0"

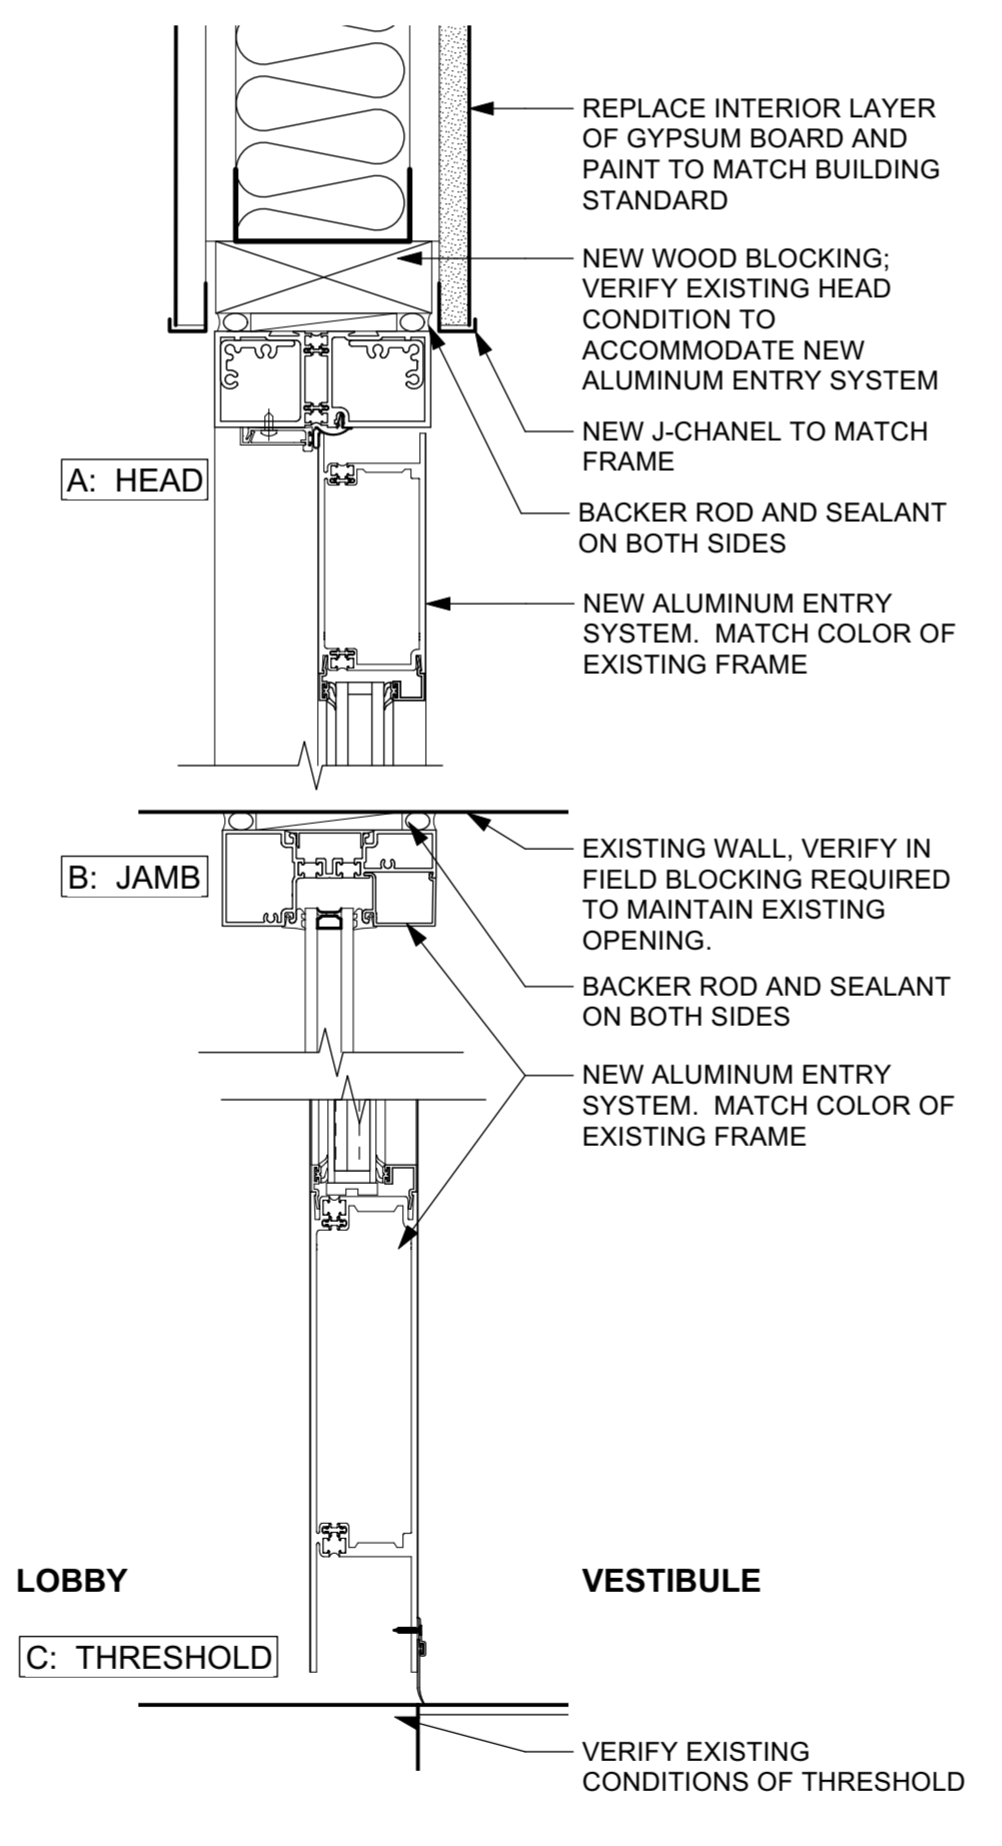

7 INTERIOR DOOR DETAILS
Scale: 3" = 1'-0"

Revisions:

No.	Date	Description
1	02/10/2023	Plan Review Documents

Consultant:

Project Owner:
City of Sun Prairie
300 East Main St.
Sun Prairie, WI 53590


Project Address:
300 East Main St.
Sun Prairie, WI 53590

1ST AND 2ND FLOOR COUNTER REMODEL
AND ENTRANCE REPLACEMENT
CITY OF SUN PRAIRIE
Sun Prairie, WI

Sheet Title:
ROOM FINISH SCHEDULE

Revisions:

No.	Date	Description
02/10/2023		Plan Review Documents

Graphic Scale:  Print 24X36

Project Number: 2138

Set Type: Bidding Document

Date Issued: 04/21/2023

Sheet Number: **A602**

ROOM FINISH SCHEDULE

TAG	ROOM DESCRIPTION	WALL FINISH				FLOOR			CEILING			NOTES
		NORTH	SOUTH	EAST	WEST	SUB.	FINISH	BASE	MAT.	FINISH	HEIGHT	
100	VESTIBULE	PT-4/GL	PT-4/GL	PT-4	-	X-CONC	WM	ETR	ACT	-	9'0"	2
115	OPEN OFFICE	PT-1	PT-2	PT-1	PT-1	X-CONC	CPT-1	RWB	ACT	-	9'0"	-
115A	RECEPTION	PT-1	PT-1	PT-2	PT-1	X-CONC	CPT-1	RWB	ACT	-	9'0"	1
115B	OFFICE	PT-1	PT-1	PT-1	PT-1	X-CONC	CPT-1	RWB	ACT	-	9'0"	3
116	OPEN OFFICE	PT-1	PT-1	PT-1	PT-1	X-CONC	CPT-1	RWB	ACT	-	9'0"	3
117	OFFICE	-	-	-	-	X-CONC	CPT-1	RWB	-	-	9'0"	-
124	OFFICE	-	-	-	-	X-CONC	CPT-1	RWB	-	-	9'0"	-
125	OPEN OFFICE	-	-	-	-	X-CONC	CPT-1	RWB	-	-	9'0"	-
212A	STAFF ENTRY	PT-3	PT-3	PT-3	PT-3	X-CONC	ETR	RWB/X-RWB	ACT	-	9'0"	-
212B	OPEN OFFICE	PT-3	PT-3	PT-3	PT-3	X-CONC	CPT-2	RWB	ACT	-	9'0"	-
212C	ENTRY	PT-3	PT-3	PT-3	PT-3	X-CONC	ETR	RWB/X-RWB	ACT	-	9'0"	-

NOTES:

- 1 PROVIDE CONCRETE TOPPING TO LEVEL FLOOR
- 2 REMOVE WALL PAPER/ AND ADHESIVES, PREP FOR PAINT
- 3 ALIGN NEW CARPET TILE AND SALVAGED SO THAT FULL TILES ABBUTT EACH OTHER

ABBREVIATIONS

- ACT ACOUSTICAL CEILING TILE
- CPT-1 CARPET TILE - TO MATCH EXISTING IN RECEPTION
- CPT-2 CARPET TILE - TO MATCH EXISTING IN OPEN OFFICE 234
- GL GLASS
- PT-1 FIRST FLOOR STANDARD WALL COLOR - CHINTZ (HALLMAN LINDSEY)
- PT-2 FIRST FLOOR ACCENT WALL COLOR - GREYSTOKE (HALLMAN LINDSEY)
- PT-3 SECOND FLOOR WALL COLOR - HINT OF VANILLA (HALLMAN LINDSEY)
- PT-4 HIGH PERFORMING COATING - CHINTZ (HALLMAN LINDSEY)
- RWB RUBBER WALL BASE TO MATCH EXISTING
- WM WALK OFF MATT TO REPLACE EXISTING
- ETR EXISTING TO REMAIN
- X- EXISTING MATERIAL

ROOM FINISH GENERAL NOTES

WALL FINISH:

PROVIDE VARIOUS REPAIRS TO GYPSUM WALL BOARD IN ORDER TO PRODUCE A LEVEL 4 or FINISH. REPAIRS INCLUDE BUT NOT BE LIMITED TO:

- 1 FILLING of SMALL GOUGES and HOLES
- 2 APPLICATION OF A LEVEL 5 FINISH WHERE LARGER AREA OF REPAIRS ARE NEEDED.
- 3 FULL DEPTH GYPSUM BOARD REPLACEMENT or ADDITION WHERE GYPSUM BOARD IS NOT SALVAGABLE.

PAINTING SHALL INCLUDE:


- 1 TEXTURING TO MATCH THAT OF EXISTING ON NEW AND EXISTING WALLS
- 2 NO LESS THAN (1) COAT ON EXISTING WALLS. PAINT EDGE TO EDGE - HORIZONTAL and VERTICALLY
- 3 NO LESS THAN (2) COATS ON NEW WALLS

FLOORING:

- 1 IT IS THE INTENT TO RESUSE EXISTING MATERIALS WHERE POSSIBLE
- 2 FLOOR PREPARATION FOR NEW OR REUSED CARPET MATERIALS MAY INCLUDE MECHANICAL REMOVAL OF EXISTING ADHESIVES and FLOOR LEVELING/PATCHING MATERIALS.
- 3 APPLICATION OF CEMENTITIOUS OVERLAYEMENT WHERE FLOOR THICKNESS DIFFER

CEILING TILE AND GRID:

- 1 IN AREA WHERE GRID IS TO REMAIN; SUPPORT GRID UNTIL REMAINDER OF GRID ADDED.
- 2 REMOVE CEILING TILE TO FULL PANELS FOR REPLACEMENT.

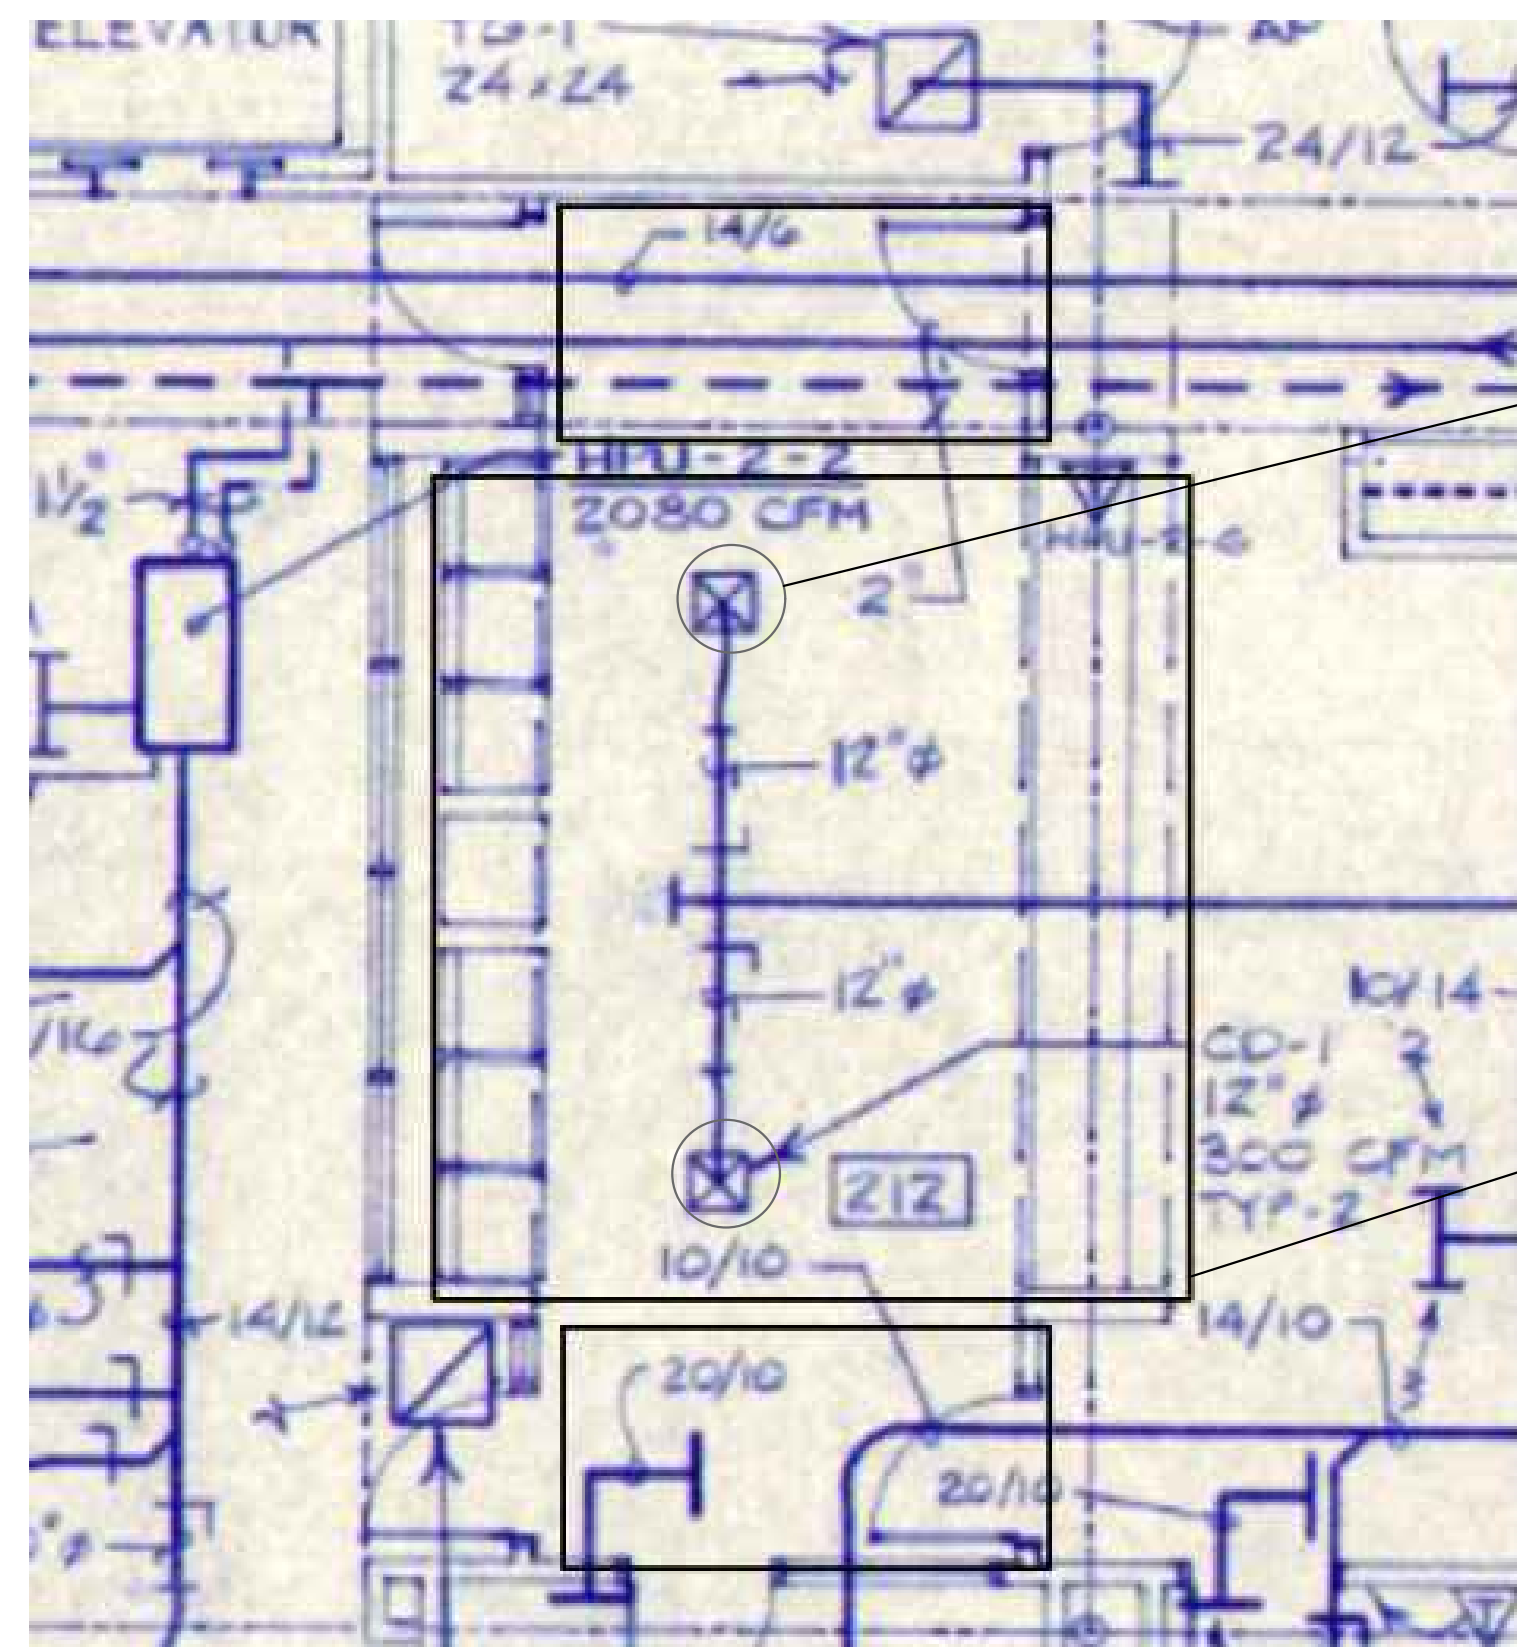

SECOND FLOOR HVAC DEMO - MEETING ROOM AND OFFICE ENTRY
Scale 1/4" = 1'0"

REMOVE EXISTING CEILING DIFFUSERS AS MARKED (TYP 2) - CONFIRM WITH WORK AREA ON A401


AREA OF WORK OUTLINE

REMOVE EXISTING CEILING DIFFUSERS IN CORRIDOR AREA - SEE SHEET A400. CONFIRM ON SITE, ALL DIFFUSERS SHALL BE REMOVED WITHIN AREA OF NEW CEILING, MAY NOT BE SHOWN ON THESE PLANS

EXISTING BUILDING MAKE UP AIR SYSTEM (WITHIN DASHED LINES) TO REMAIN UNCHANGED

REMOVE EXISTING CEILING DIFFUSERS AS MARKED (TYP 5) - CONFIRM WITH WORK AREA ON A400 - REMAINING DIFFUSERS AND DUCTWORK SHALL NOT CHANGE

AREA OF WORK OUTLINE

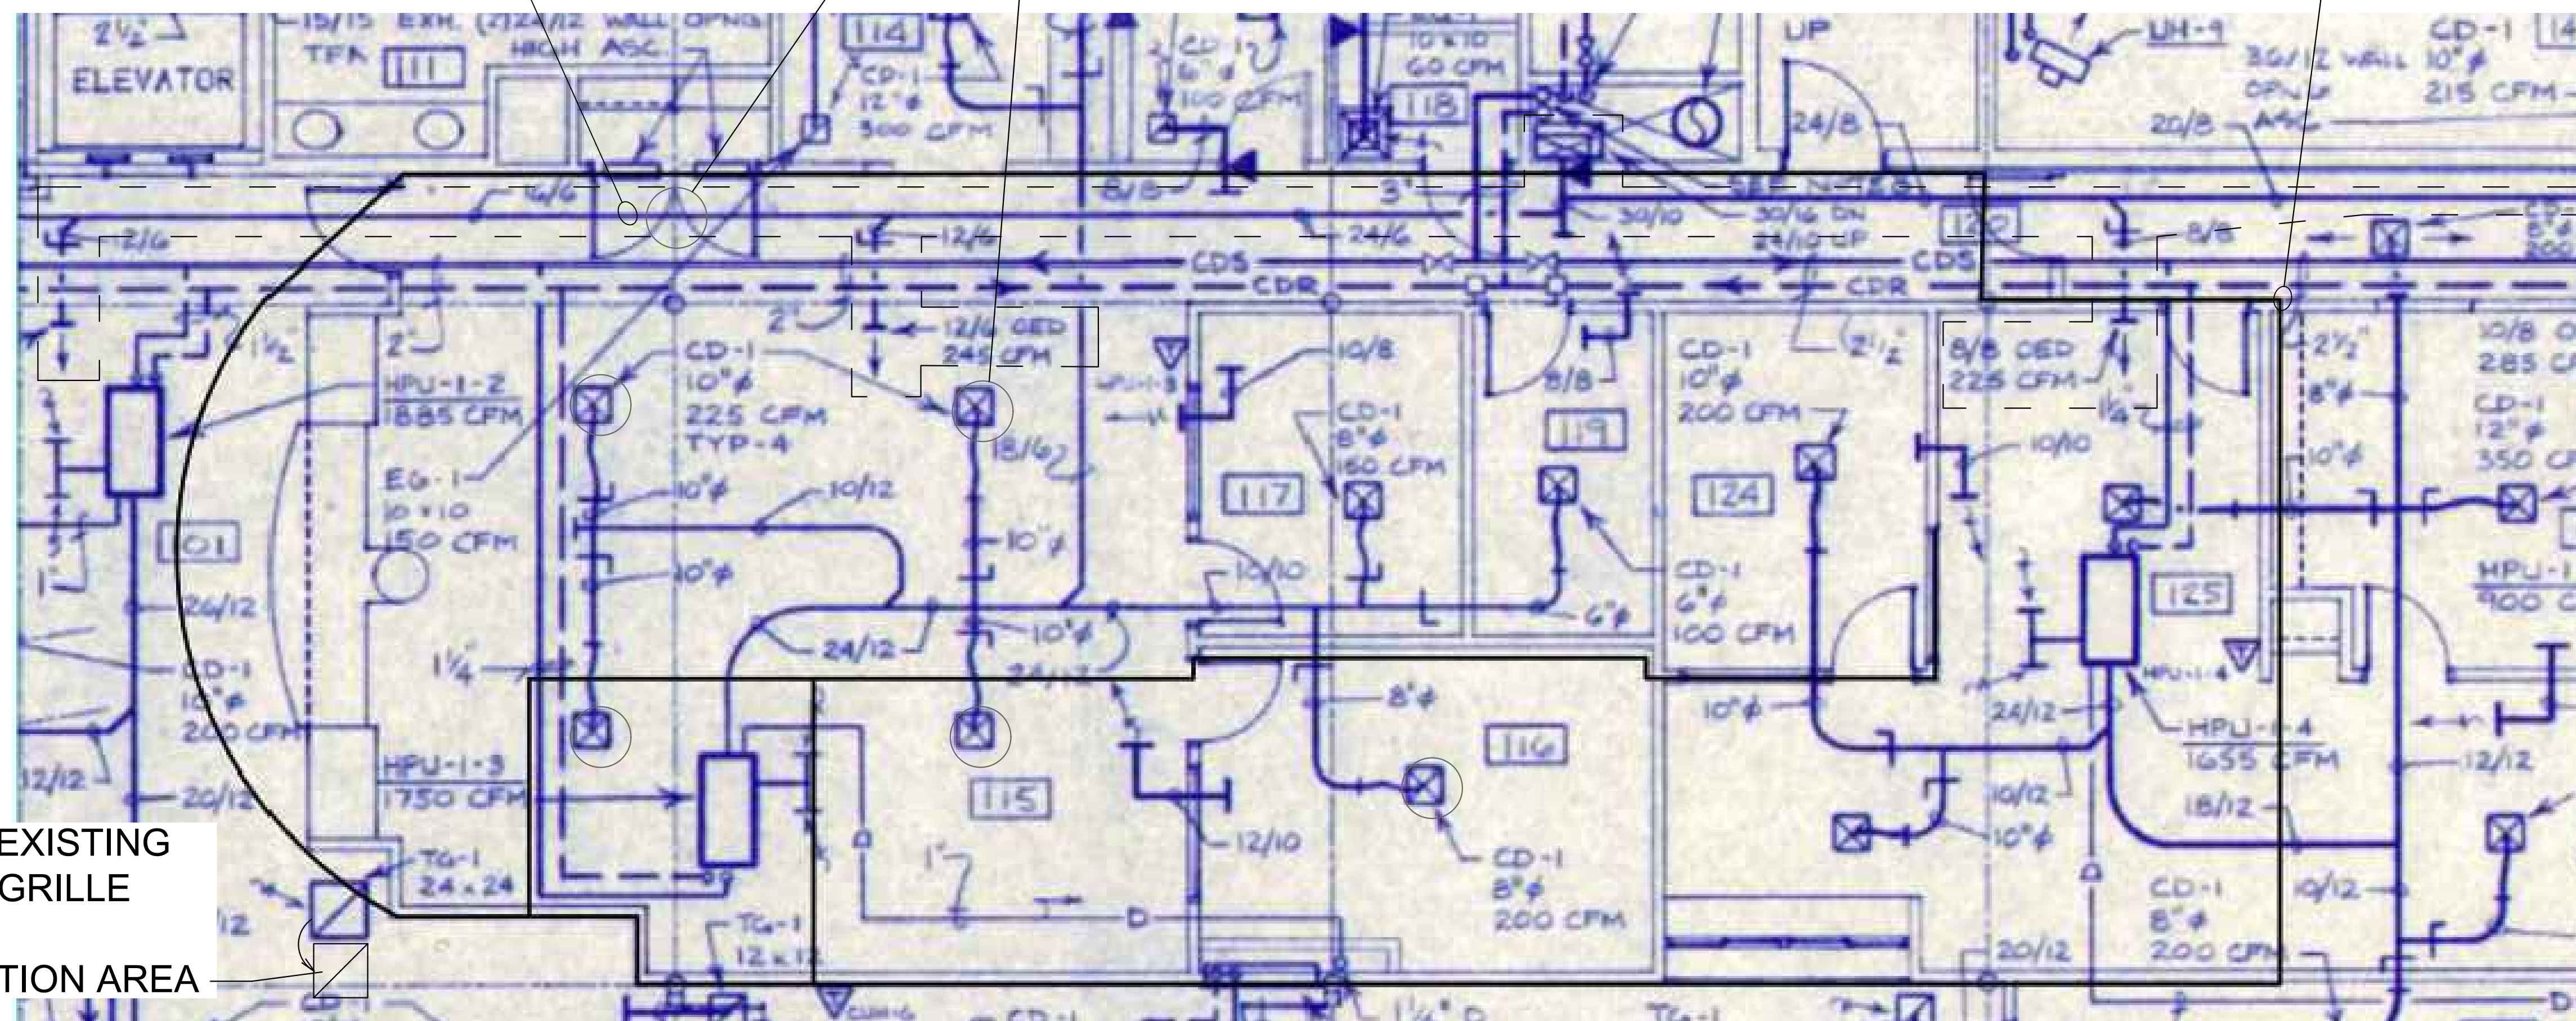


FIRST FLOOR HVAC DEMO - RECEPTION AND OPEN OFFICE
Scale 1/4" = 1'0"

RELOCATE EXISTING TRANSFER GRILLE TO AVOID CONSTRUCTION AREA


Revisions:

No.	Date:	Description:

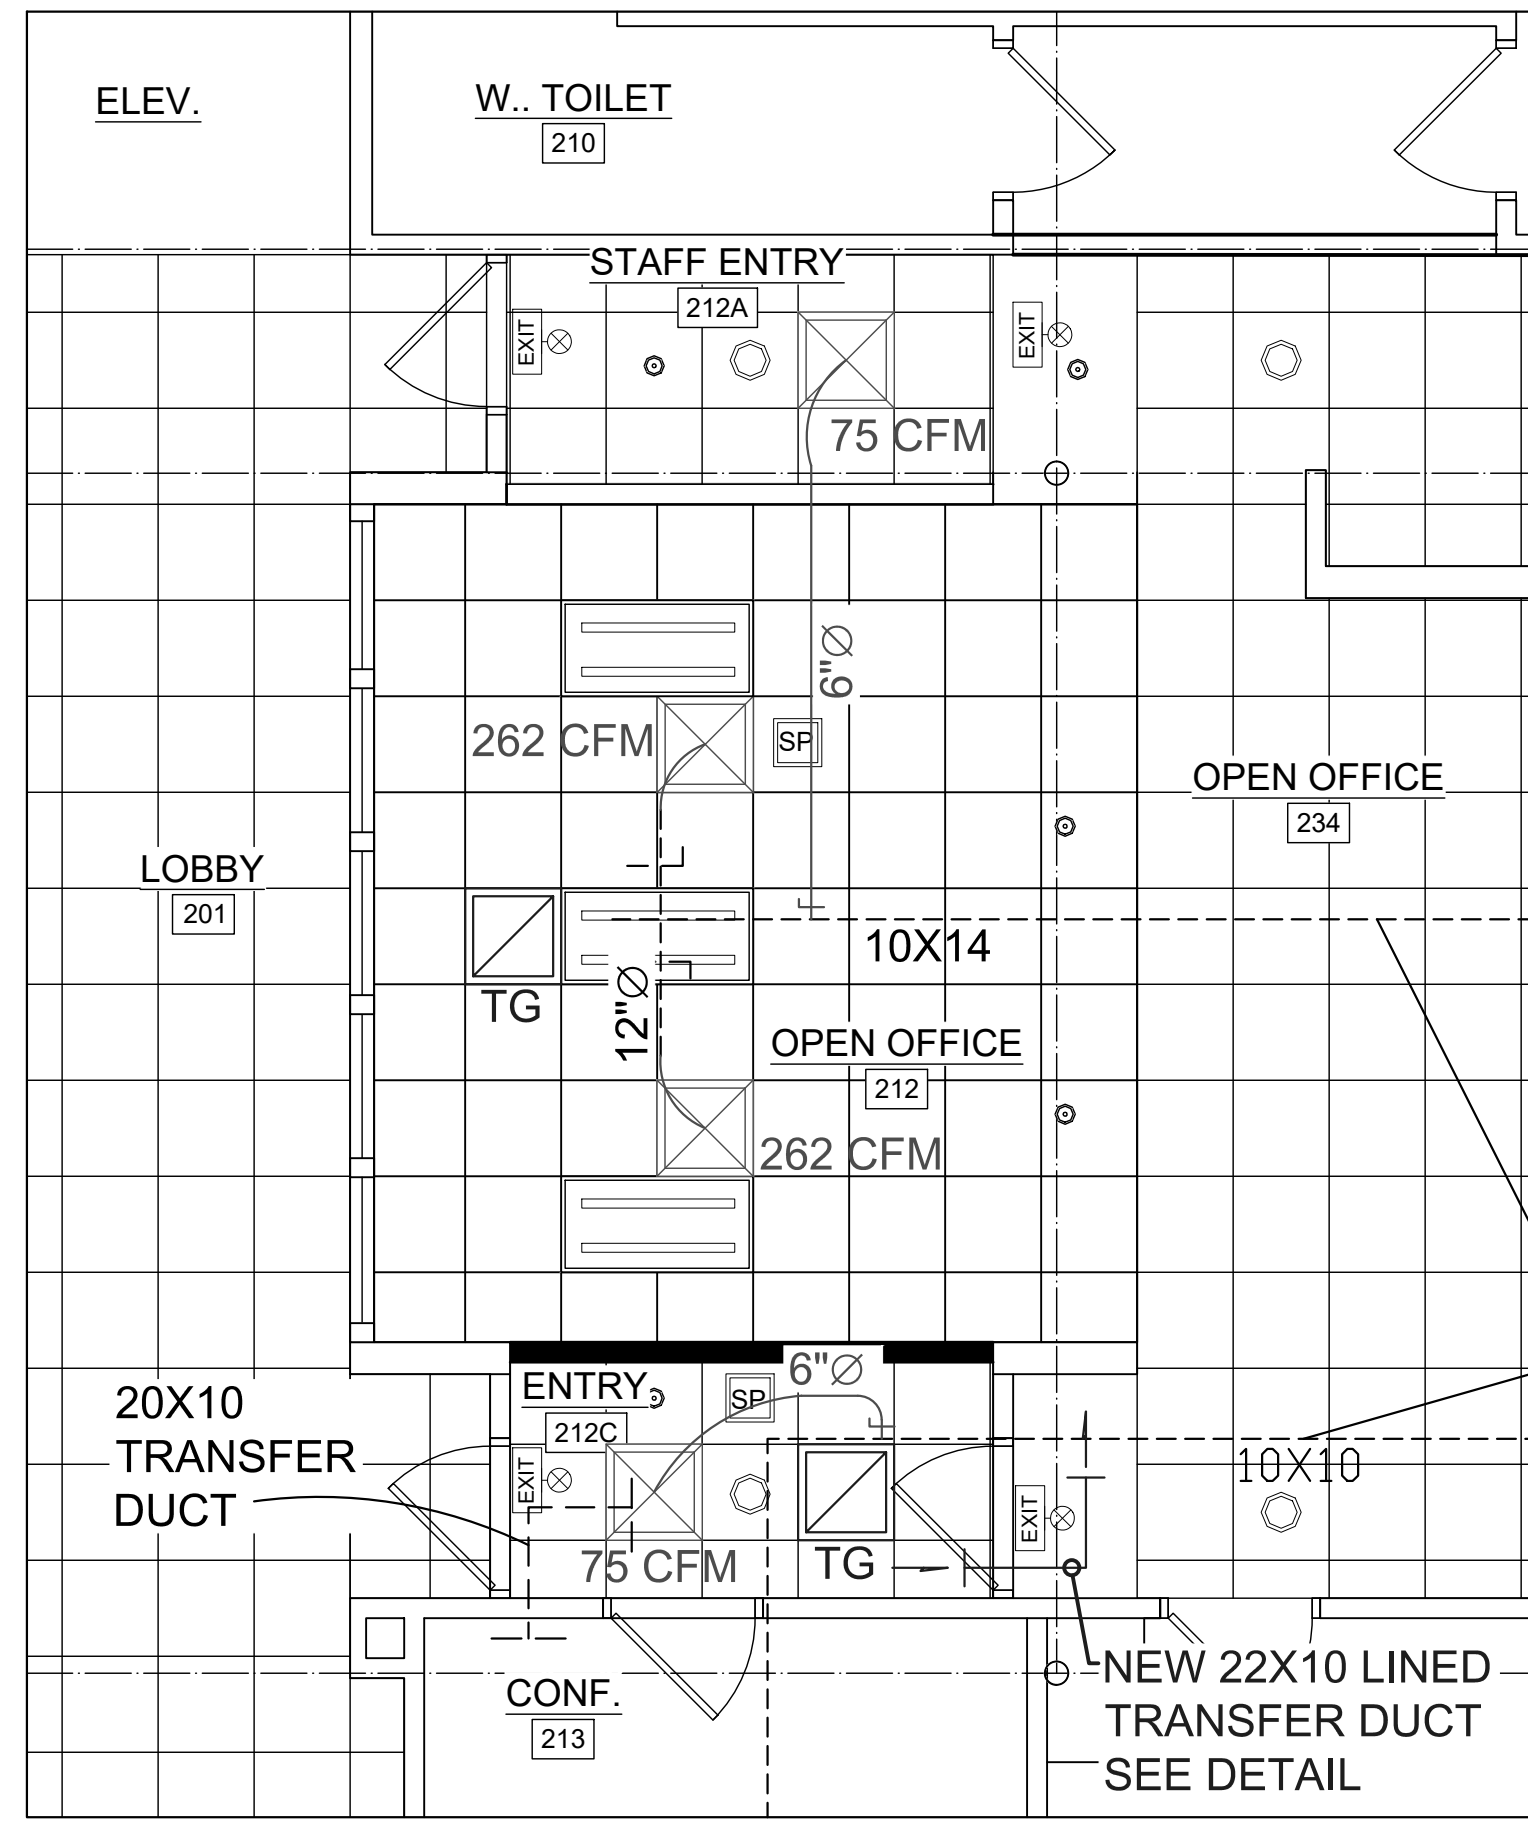

SECOND FLOOR HVAC PLAN - MEETING ROOM AND OFFICE ENTRY
Scale 1/4" = 1'0"

NEW DIFFUSERS. TRANSFER GRILLES AND DUCTS AS SHOWN, RECONNECT DUCTWORK AS REQUIRED-REBALANCE AS SHOWN - 1st & 2nd FLOOR AREAS OF WORK (TYP)

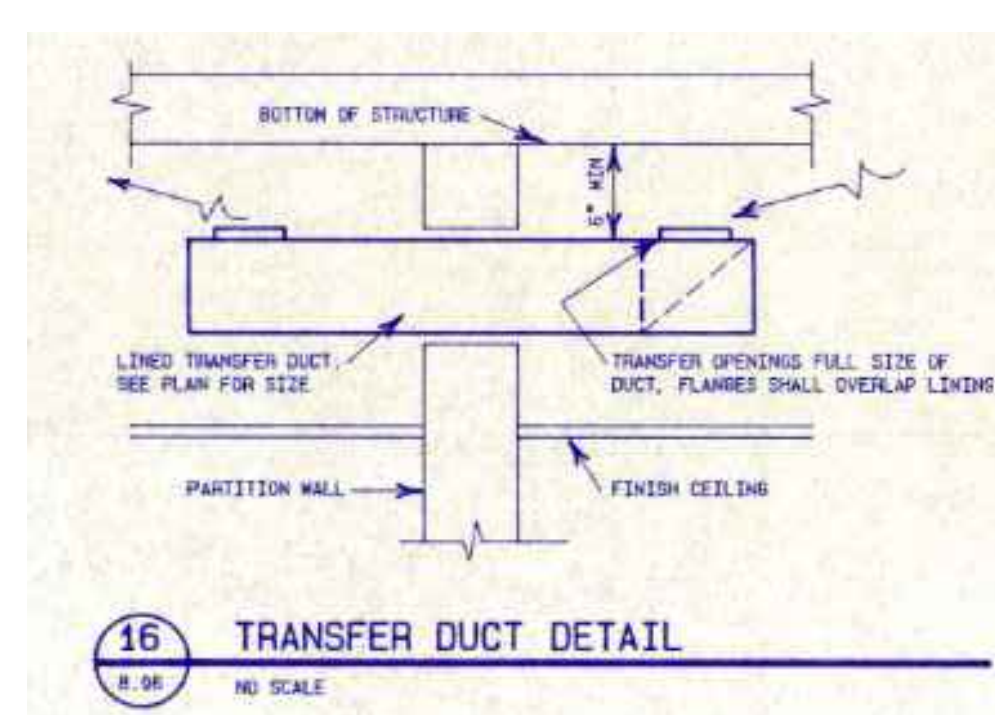


DETAIL FROM ORIGINAL PROJECT HVAC PLANS SHALL APPLY FOR THIS PROJECT

HVAC SPECIFICATION NOTES:

1. ALL WORK MUST MEET ALL THE REQUIREMENTS OF IBC, IECC, IMC, IFGC, STATE AND LOCAL CODES.
2. IECC C403.2.3/IMC 603.9 DUCTWORK SHALL BE SEALED AT ALL JOINTS, TRANSVERSE AND LONGITUDINAL SEAMS AND CONNECTIONS IN DUCTWORK USING LISTED PRODUCTS AS REFERENCED IN THE CODE (UL-181A RATINGS REQUIRED). THE REFERENCED DUCTWORK INCLUDES ALL SUPPLY, EXHAUST, AND RETURN DUCTS. PROVIDE AND INSTALL TURNING VANES OR LONG RADIUS ELBOWS AT ALL TURNS, WHETHER SHOWN ON THE PLANS OR NOT.
3. ALL SUPPLY DUCTS AND RETURN DUCTS SHALL BE INSULATED WITH R-12 WHEN LOCATED OUTSIDE THE BUILDING ENVELOPE (PER IECC 403.2.3) AND INSULATED TO A MINIMUM R=6 WITHIN THE UNCONDITIONED SPACES OF THE BUILDING ENVELOPE OR GREATER THAN A 16 DEGREE TEMPERATURE DIFFERENCE FROM THE AMBIENT AIR TEMPERATURE. ALL FRESH AIR INTAKE DUCTS TO BE INSULATED TO MIN R-12.
4. ALL SUPPLY AND EXHAUST DUCT TAKE-OFFS SHALL BE PROVIDED WITH MANUAL VOLUME DAMPERS FOR SYSTEM BALANCING. THE HVAC CONTRACTOR SHALL BE RESPONSIBLE FOR TESTING AND BALANCING ALL AIR SYSTEMS TO +/-10% OF AIR QUANTITIES SHOWN ON THE PLANS AND PROVIDE A COPY TO THE ENGINEER AND LEAVE A COPY AT THE JOBSITE WITH THE APPROVED HVAC PLANS FOR DEPT OF SAFETY & PROFESSIONAL SERVICES USE UPON REQUEST. PER SPS 384.0313. BALANCE REPORTS SHALL BE REQUIRED BEFORE COMPLIANCE STATEMENTS SHALL BE PROVIDED AT THE COMPLETION OF THE PROJECT.
5. IMC 602.2 AIR PLENUMS SHALL NOT BE CONSTRUCTED OF COMBUSTIBLE MATERIALS IF THE TYPE OF CONSTRUCTION CLASSIFICATION FOR THE BUILDING WILL NOT ALLOW SUCH CONSTRUCTION. (ALSO, BE AWARE OF THE LIMITATIONS ON MATERIALS LOCATED WITHIN THE PLENUM). THE IMC DOES NOT ALLOW UNCOVERED PVC PIPING TO BE INSTALLED IN PLENUMS DUE TO ITS FAILURE TO MEET THE LIMITATIONS FOR FLAME SPREAD AND SMOKE DEVELOPMENT. MATERIALS WHICH WRAP OR ENCLOSE ANY EXPOSED PVC, MAY BE USED IF THEY ARE TESTED AND LISTED FOR THAT USE AND MEET THE FLAME SPREAD AND SMOKE DEVELOPMENT REQUIREMENTS. OTHER PIPING MATERIALS INCLUDING CPVC AND MANY OTHERS COULD BE USED IF THEY MEET THE FLAME SPREAD AND SMOKE DEVELOPMENT CRITERIA.
6. ALL DUCT SIZES SHOWN ARE CLEAR, INSIDE DIMENSIONS.
7. INSULATED FLEXIBLE DUCTS SHALL BE LIMITED TO 8 FEET IN LENGTH AND COMPLY WITH THE UL-181B REQUIREMENTS & REQUIREMENTS IMC 603.6 & 304.
8. THERMOSTAT CONTROLS SHALL BE LOCATED A MAXIMUM OF 48" ABOVE THE FINISHED FLOOR PER IBC 1101.2.
9. PROVIDE FLEXIBLE CONNECTORS BETWEEN ALL MOTORIZED EQUIPMENT AND ITS ASSOCIATED DUCTWORK SYSTEM.
10. PROVIDE 10" MINIMUM CLEARANCE BETWEEN OUTSIDE AIR INTAKES AND FLUES, VENTS, RELIEF AND EXHAUST DISCHARGE OPENINGS. AUTOMATIC DAMPERS (NOT BAROMETRIC FOR FRESH AIR INTAKES) ARE REQUIRED TO PREVENT THE INTAKE OF OUTSIDE AIR INTO A BUILDING WHEN VENTILATING OR EXHAUST SYSTEM IS NOT IN OPERATION, EXCEPT AS ALLOWED BY CODE, PER IMC 401.4.1/SPS 384.0401(4)(A) PROVIDE OUTSIDE AIR INTAKE OPENINGS A MINIMUM OF 12 INCHES VERTICALLY FROM THE ADJOINING GRADE LEVEL, ABOVE ADJOINING ROOF SURFACES, OR ABOVE THE BOTTOM OF AN AREAWAY, AND AT LEAST 10' HORIZONTALLY FROM OUTLETS THAT EMIT PRODUCTS OF COMBUSTION AND EXHAUST VENTS, OR LOCATE THE INTAKE OPENINGS A MINIMUM OF 3 FT BELOW THE CONTAMINANT SOURCE.
11. PROVIDE ALL HVAC EQUIPMENT AND THERMOSTAT OPERATIONS AND MAINTENANCE MANUALS TO THE OWNER AS REQUIRED PER SPS 384.0313. INCLUDE ANY RELEVANT WIRING DIAGRAMS, CONTROL SCHEMATICS AND ALL WARRANTY INFORMATION.
12. HVAC PLANS ARE CONSIDERED DIAGRAMMATIC. THE CONTRACTOR SHALL FIELD VERIFY SIZES AND LOCATIONS OF ALL DUCTWORK, GRILLES, PIPING, EQUIPMENT, AND BUILDING OPENINGS PRIOR TO FABRICATION OF MATERIALS. OBTAIN APPROVAL FROM THE DESIGNER BEFORE ANY CHANGES TO THE SYSTEM DESIGN OR EQUIPMENT IS MADE. CHANGES TO THE HVAC DESIGN OR SUBSTITUTIONS OF EQUIPMENT WITHOUT WRITTEN APPROVAL OF THE HVAC DESIGNER SHALL RELIEVE THE DESIGNER OF ALL THE RESPONSIBILITY OF ADEQUATE PERFORMANCE OF THE HVAC SYSTEM.
13. IT SHALL BE THE CONTRACTOR'S RESPONSIBILITY TO COORDINATE WITH ALL TRADES AND FIELD CONDITIONS, JOBSITE SAFETY STANDARDS, EQUIPMENT AND MATERIAL DELIVERIES, PROJECT HOUSEKEEPING AND CLEAN-UP AND ALL OTHER JOBSITE SUPERVISORY RESPONSIBILITIES.
14. HVAC CONTRACTOR SHALL BE RESPONSIBLE FOR ANY/ALL LOW VOLTAGE WIRING. THE ELECTRICAL CONTRACTOR SHALL BE RESPONSIBLE FOR ANY/ALL ELECTRICAL WIRING 110V AND HIGHER.
15. ALL STRUCTURAL LOADS AND REQUIREMENTS SHALL BE DETERMINED BY THE ARCHITECT OR STRUCTURAL ENGINEER FOR THE LOADS OF THE HVAC EQUIPMENT AS SHOWN ON THESE PLANS. NO STRUCTURAL REINFORCEMENT OR RESPONSIBILITY SHALL BE PROVIDED BY THIS DESIGNER OR THE HVAC CONTRACTOR. ALL REINFORCEMENT REQUIRED SHALL BE PROVIDED BY THE GENERAL CONTRACTOR.
16. ALL HYDRONIC WORK MUST CONFORM TO IMC 1201.1, 1206.2 FOR DRAIN REQUIREMENTS & 1209.2 FOR TESTING REQUIREMENTS.


TITUS GRILLE AND DIFFUSER SCHEDULE					
TAG	(OR EQUAL)		NECK	BORDER TYPE	LOCATION
	MODEL	SIZE			
SA	OMNI	24X24	SEE PLAN	3	LAY-IN CEILING
TG	50F - CODE A	24X24	-	3	LAY-IN CEILING

EXISTING DUCTWORK TO REMAIN (TYP)

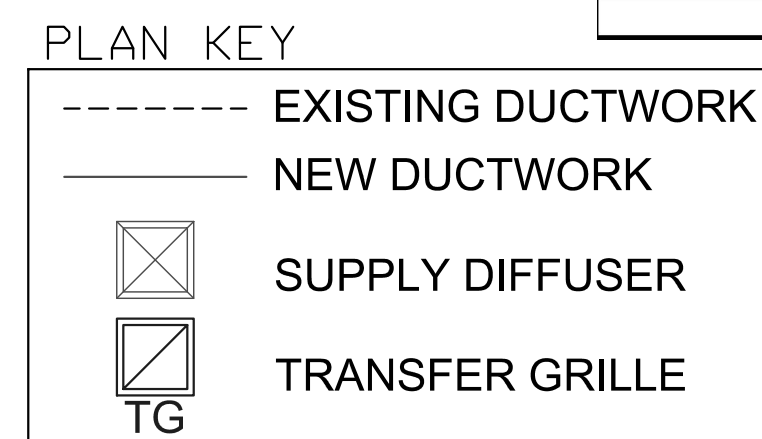

Note - Return air ceiling plenums are utilized on this project. During the course of construction, the Contractor shall ascertain that all rooms to which air is supplied, have return air paths back to and through the ceiling plenum. Any spaces observed which do not have such openings shall be reported to the A/E immediately for resolution. Piping and ductwork shall be installed in such a manner so as not to block the return air path, return air openings to shafts and intake ductwork. Any conflicts with the structural systems or openings shall be reported immediately. All dampers on return registers and light fixture return slots shall be checked prior to operating the systems and determined that they are opened. Certain mechanical rooms may also be return air plenums. All materials in such rooms shall be plenum rated non-combustible materials.

NOTE FROM ORIGINAL PROJECT HVAC PLANS - STILL IN EFFECT - NEW LIGHT FIXTURES DO NOT INCLUDE RETURN SLOTS, TRANSFER GRILLES INSTALLED IN NEW CEILING LAYOUT

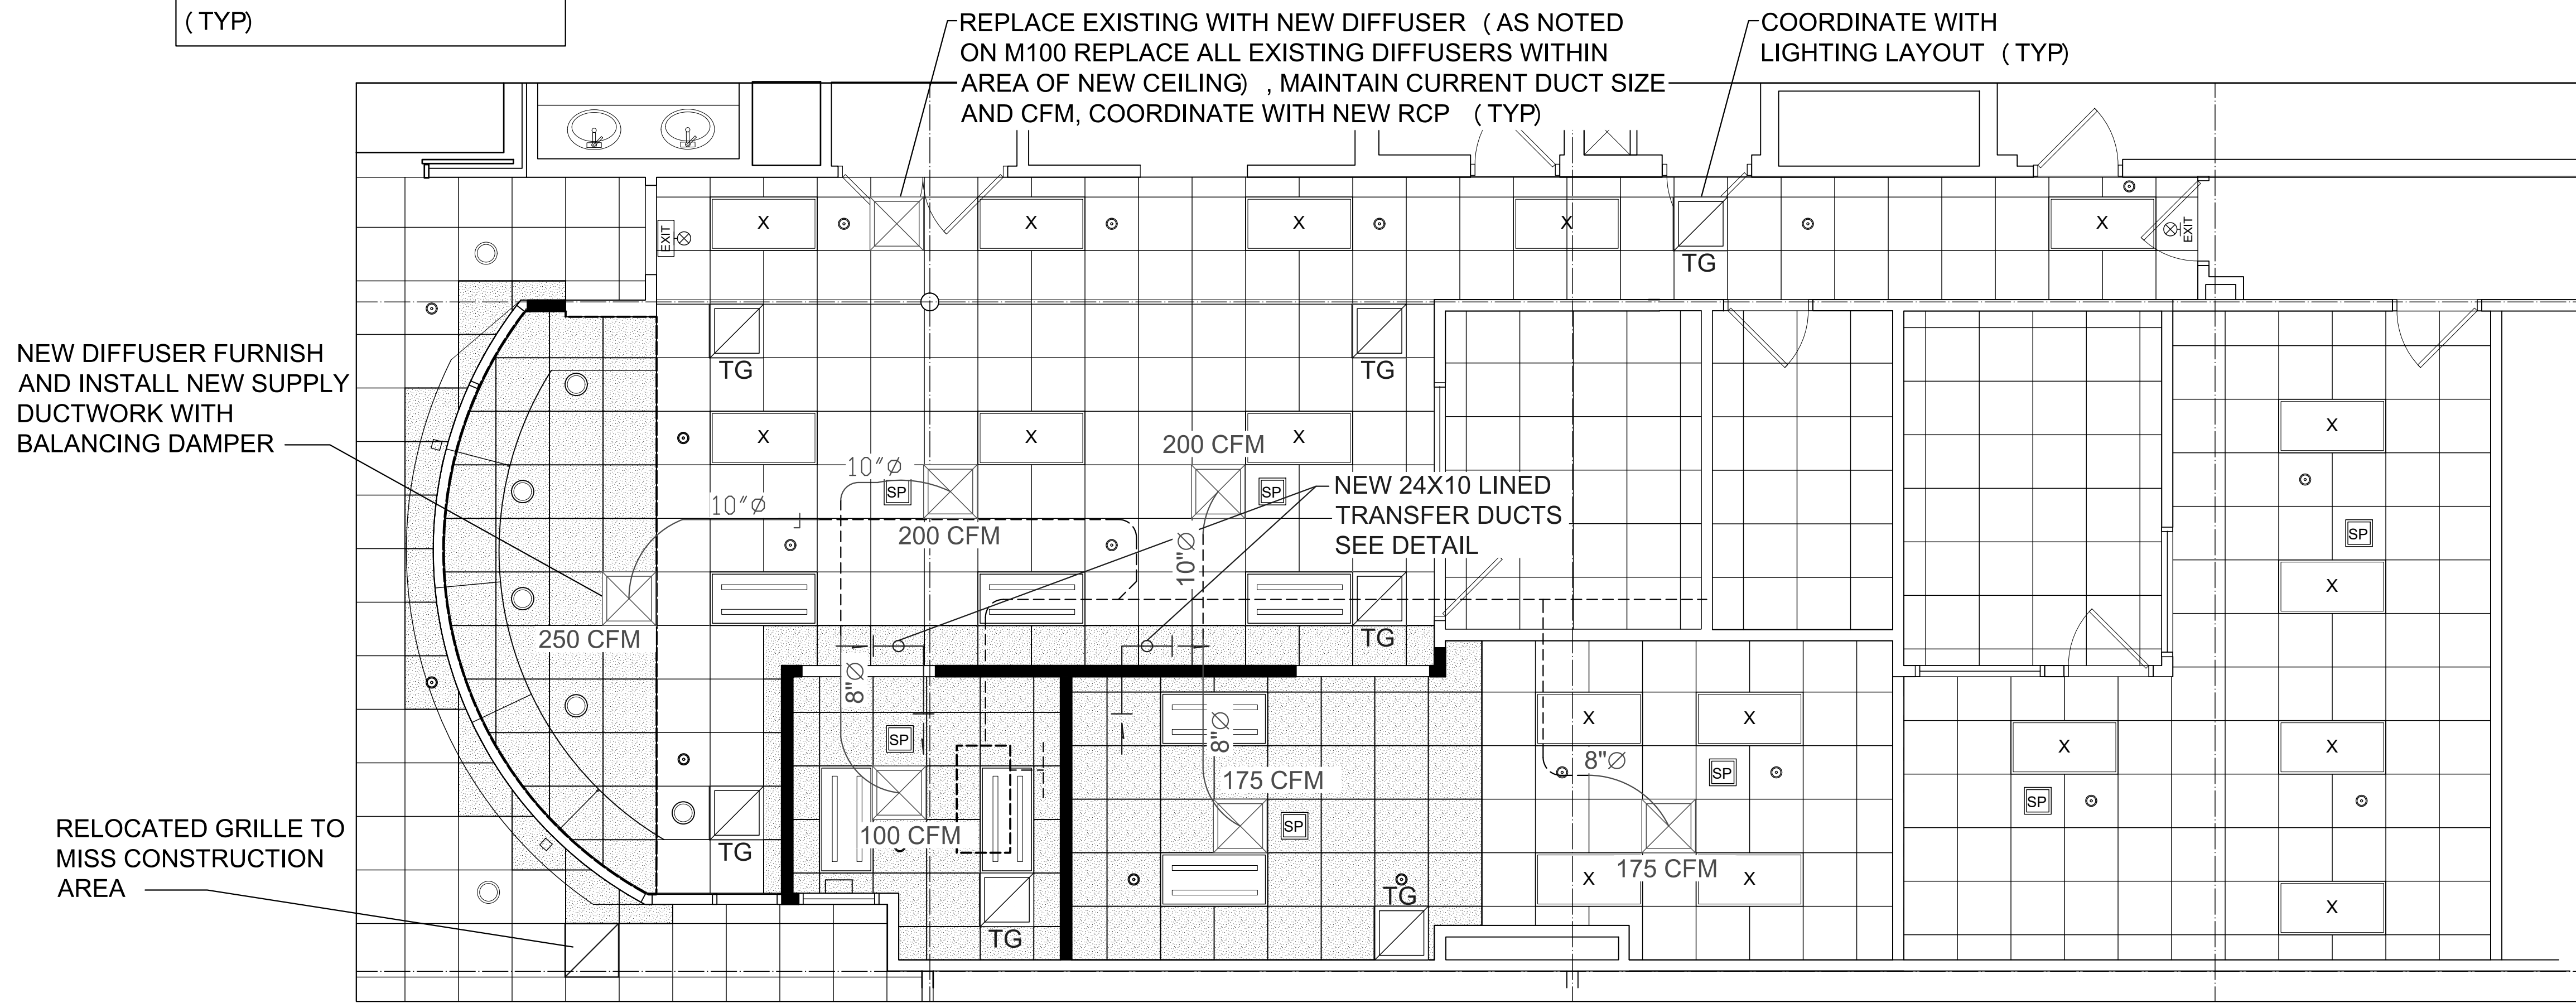

FIRST FLOOR HVAC PLAN - RECEPTION AND OPEN OFFICE
Scale 1/4" = 1'0"

Consultant:
SCD PLANS, LLC.
8030 - 120th Ave.
Bristol, WI 53104
262-815-3341
scdplans@yahoo.com

Project Owner:
City of Sun Prairie
300 East Main St.
Sun Prairie, WI 53590

CITY HALL - 1ST AND 2ND FLOOR COUNTER REMODEL AND ENTRANCE REPLACEMENT
CITY OF SUN PRAIRIE
Sun Prairie, WI

Sheet Title:
TITLE SHEET & PROJECT LOCATOR MAP



Revisions:
No. Date Description:

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Scale: 1/4" = 1'0"





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Date Issued: 04/21/2023
Sheet Number: **M101**

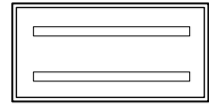


KONTEXT architects
building relationships
242 East Main St - Sun Prairie, WI

LUMINAIRE SCHEDULE









	DESCRIPTION	INPUT WATTS	COLOR TEMP	LUMENS	VOLTS	MOUNTING	MANUFACTURER	MODEL
	2x4 LED RECESSED TROFFER	35.66	4000 K	4500	UNIVERSAL	RECESSED	KEYSTONE	KT-BPLED50PS-24-8CSA-VDIM/G2
	8" RECESSED LED DOWN LIGHT	21.2	4000 K	2000	UNIVERSAL	RECESSED	KEYSTONE	KT-RDLED29PS-8A-8CSE-VDIM

POWER LEGEND



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-  NEW DUPLEX OUTLET (GFI WHERE NOTED, E= EXISTING)
-  NEW QUADPLEX OUTLET (GFI WHERE NOTED, E= EXISTING)
-  EXISTING ELECTRICAL AND DATA FEED WALL ACCESS

-  JUNCTION BOX W/WHIP. CONNECT TO MODULAR FURNISHING
-  LINE VOLTAGE TO POWER SUPPLY or OPERATOR
-  LINE/LOW and DATA TO CREDIT CARD READER - DEVICE PROVIDED BY OWNER - CONFIRM ELECTRICAL REQUIREMENTS.

LOW VOLTAGE LEGEND

-  DATA [DATA WORK: PROVIDE DEVICE BOX AND RIGID CONDUIT TO ABOVE CEILING, INCLUDE (2) CAT6A CABLES FROM LOCATION TO HEADEND (SWITCH GEAR) LOCATED ON SECOND FLOOR ROOM 230 (VERIFY & COORDINATE WITH OWNER). TERMINATE BOTH ENDS AND TEST. VERIFY EXACT LOCATION OF DATA POINTS WITH OWNER IN FIELD. VERIFY LOCATION OF HEADEND (SWITCH GEAR) WITH OWNER IN FIELD.
-  LOW VOLTAGE TO ELECTRIC DOOR STRIKE
-  LOW VOLTAGE TO DOOR OPERATOR CONTROL
-  PANIC SWITCHES, LOW VOLTAGE TO SECURITY PANEL, INCLUDE DEVICE
-  EXISTING SPEAKER - REMOVE AND REINSTALL IF NECESSARY
-  LINE/LOW and DATA TO CREDIT CARD READER - DEVICE PROVIDED BY OWNER - CONFIRM ELECTRICAL REQUIREMENTS.
-  DOOR RELEASE- LOW VOLTAGE TO DOOR ELECTRIC STRIKE, INCLUDE DEVICE
-  REQUEST FOR EXIT - PROVIDE DEVICE and WIRING TO EXIT DEVICE. INTERFACE WITH FIRE ALARM SYSTEM

LIGHTING LEGEND: EXISTING, N=NEW)

-  LIGHT FIXTURE - (X-EXISTING)
-  CEILING MOUNTED OCCUPANCY SENSOR (N - NEW; E-EXISTING)

FIRE PROTECTION LEGEND

-  SPRINKLER HEAD

General Electrical Notes:

EXISTING PANEL: UTILIZE, ACCESS, AND EXPAND EXISTING PANEL IF NECESSARY

POWER DEVICES: PROVIDE POWER DEVICES WHERE INDICATED, INCLUDING BUT NOT LIMITED TO WALL DUPLEXES AND SWITCHES

PANIC SWITCHES TO BE WIRED BACK TO SECURITY, VERIFY IN FIELD

LIGHTING: MINIMUM LUMINAIRE WARRANTY OF 5 YEARS (NOT PRO-RATED) TO INCLUDE LED DRIVER AND ALL LED COMPONENTS, COLOR TEMPERATURE OF 3000K-4100K

EMERGENCY AND EXIT LIGHTS: THE LIGHTING INDICATED ON THE DRAWINGS ARE DIAGRAMMATIC.

SWITCHING TO BE VERIFIED IN FIELD AND WITH OWNER

ELECTRICAL AND CONTROL WIRING TO BE IN RIGID CONDUIT ABOVE THE CEILING AND IN WALLS FOR FUTURE ACCESS

FIRE PROTECTION AND ELECTRICAL SCOPING DOCUMENTS

GENERAL

SCOPE: PROVIDE ALL DESIGN, MATERIAL AND LABOR REQUIRED FOR A COMPLETE INSTALLATION OF ALL SYSTEMS. THE GENERAL CONTRACTOR SHALL BE RESPONSIBLE TO COORDINATE ALL SYSTEMS TO INSURE COMPLETE FUNCTIONALITY OF ALL SYSTEMS.

CODES: ALL WORK AND MATERIAL SHALL CONFORM IN EVERY RESPECT TO THE CURRENT RULES AND REQUIREMENTS OF THE STATE OF WISCONSIN AND THE CITY OF SUN PRAIRIE. PROVIDE CITY APPROVED PLANS, ACQUIRE BUILDING PERMIT AND COMPLETE WORK AS REQUIRED BY THE STATE OF WISCONSIN.

CUTTING, PATCHING AND SLEEVES: GENERAL CONTRACTOR SHALL BE RESPONSIBLE FOR THIS CUTTING AND PATCHING. PROVIDE SLEEVES AS REQUIRED. COORDINATE ALL OPENINGS WITH OTHER TRADES. MAKE ALL NEW PENETRATIONS THROUGH THE BUILDING ENVELOPE WATER AND AIR TIGHT.

FIRE PROTECTION: ADAPT EXISTING FIRE PROTECTION SYSTEM IN THE AREAS AS NOTED ON DRAWINGS.

Consultant:

Project Owner:
City of Sun Prairie
300 East Main St.
Sun Prairie, WI 53590


Project Address:
300 East Main St.
Sun Prairie, WI 53590

1ST AND 2ND FLOOR COUNTER REMODEL
AND ENTRANCE REPLACEMENT
CITY OF SUN PRAIRIE
Sun Prairie, WI

Sheet Title:
ELECTRICAL / FIRE PROTECTION NOTES and LEGEND

Revisions:

No.	Date:	Description:
	02/10/2023	Plan Review Documents

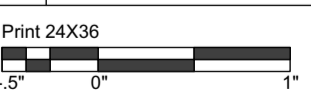Graphic Scale:  Print 24X36
0' 5' 10'

Project Number: 2138

Set Type: Bidding Document

Date Issued: 04/21/2023

Sheet Number: **E/F000**

Consultant:

Project Owner:
City of Sun Prairie
300 East Main St.
Sun Prairie, WI 53590

Project Address:
300 East Main St.
Sun Prairie, WI 53590

**1ST AND 2ND FLOOR COUNTER REMODEL
AND ENTRANCE REPLACEMENT
CITY OF SUN PRAIRIE
Sun Prairie, WI**

Sheet Title:
**FIRST FLOOR - POWER AND DATA
& LIGHTING AND FIRE PROTECTION PLANS**

Revisions:

No.	Date	Description
02/10/2023	02/10/2023	Plan Review Documents

Graphic Scale: Print 24X36


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Set Type: Bidding Document


Date Issued: 04/21/2023

Sheet Number: **E/F100**

File: Plot Date

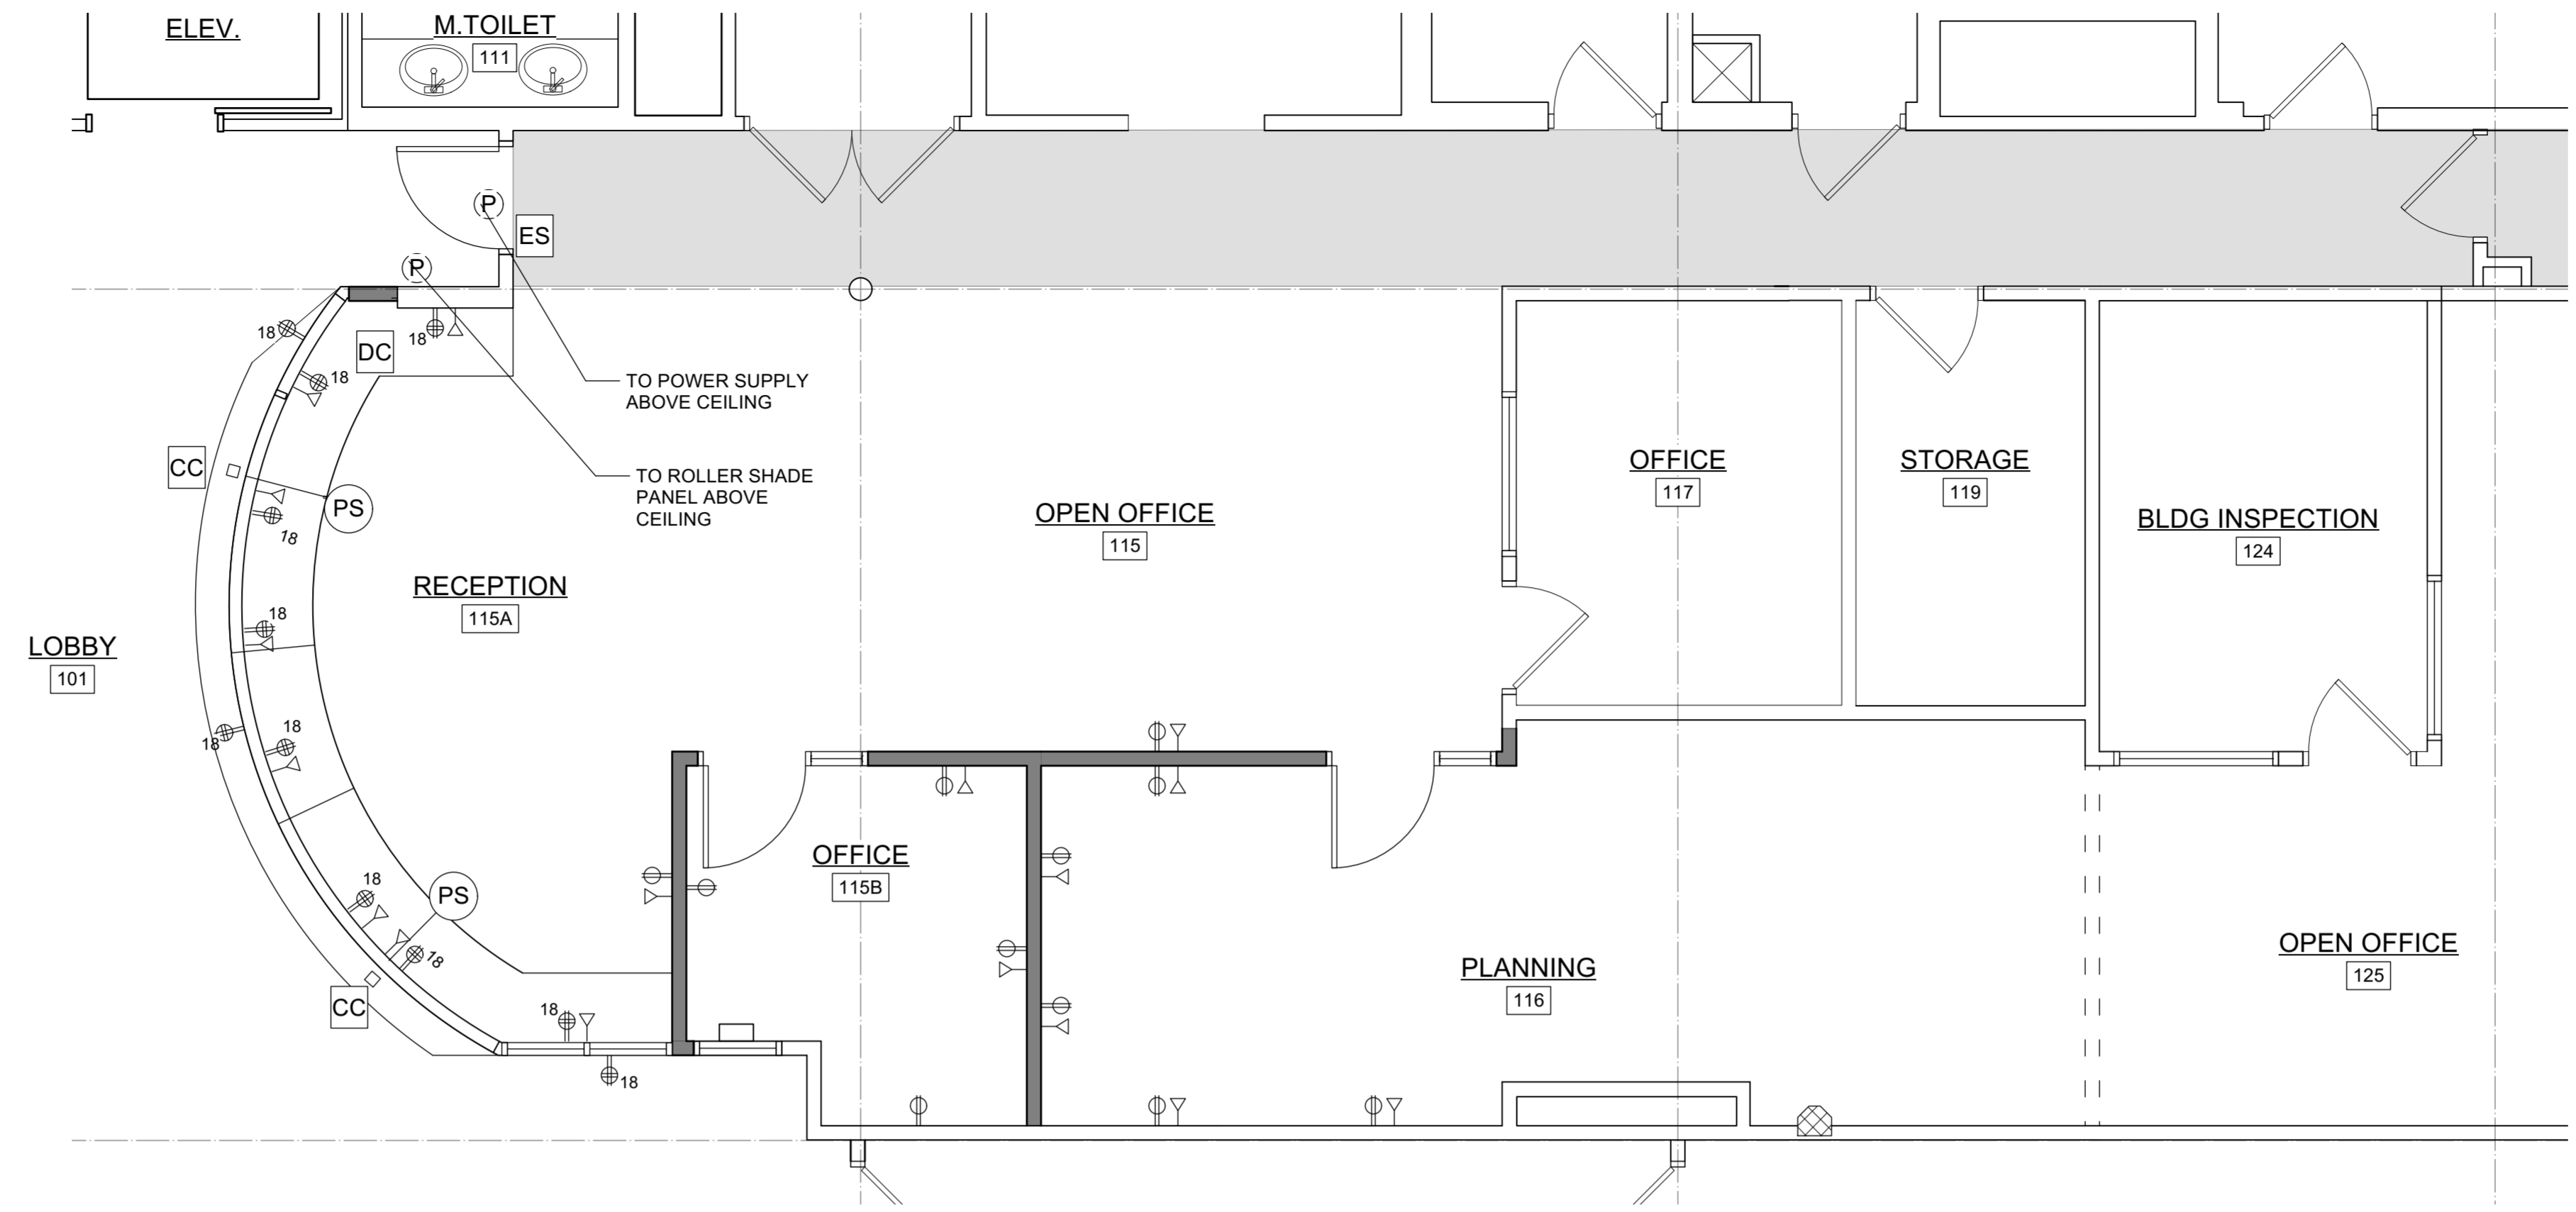

1 FIRST FLOOR POWER AND DATA PLAN
E/F100 Scale: 1/4" = 1'-0"

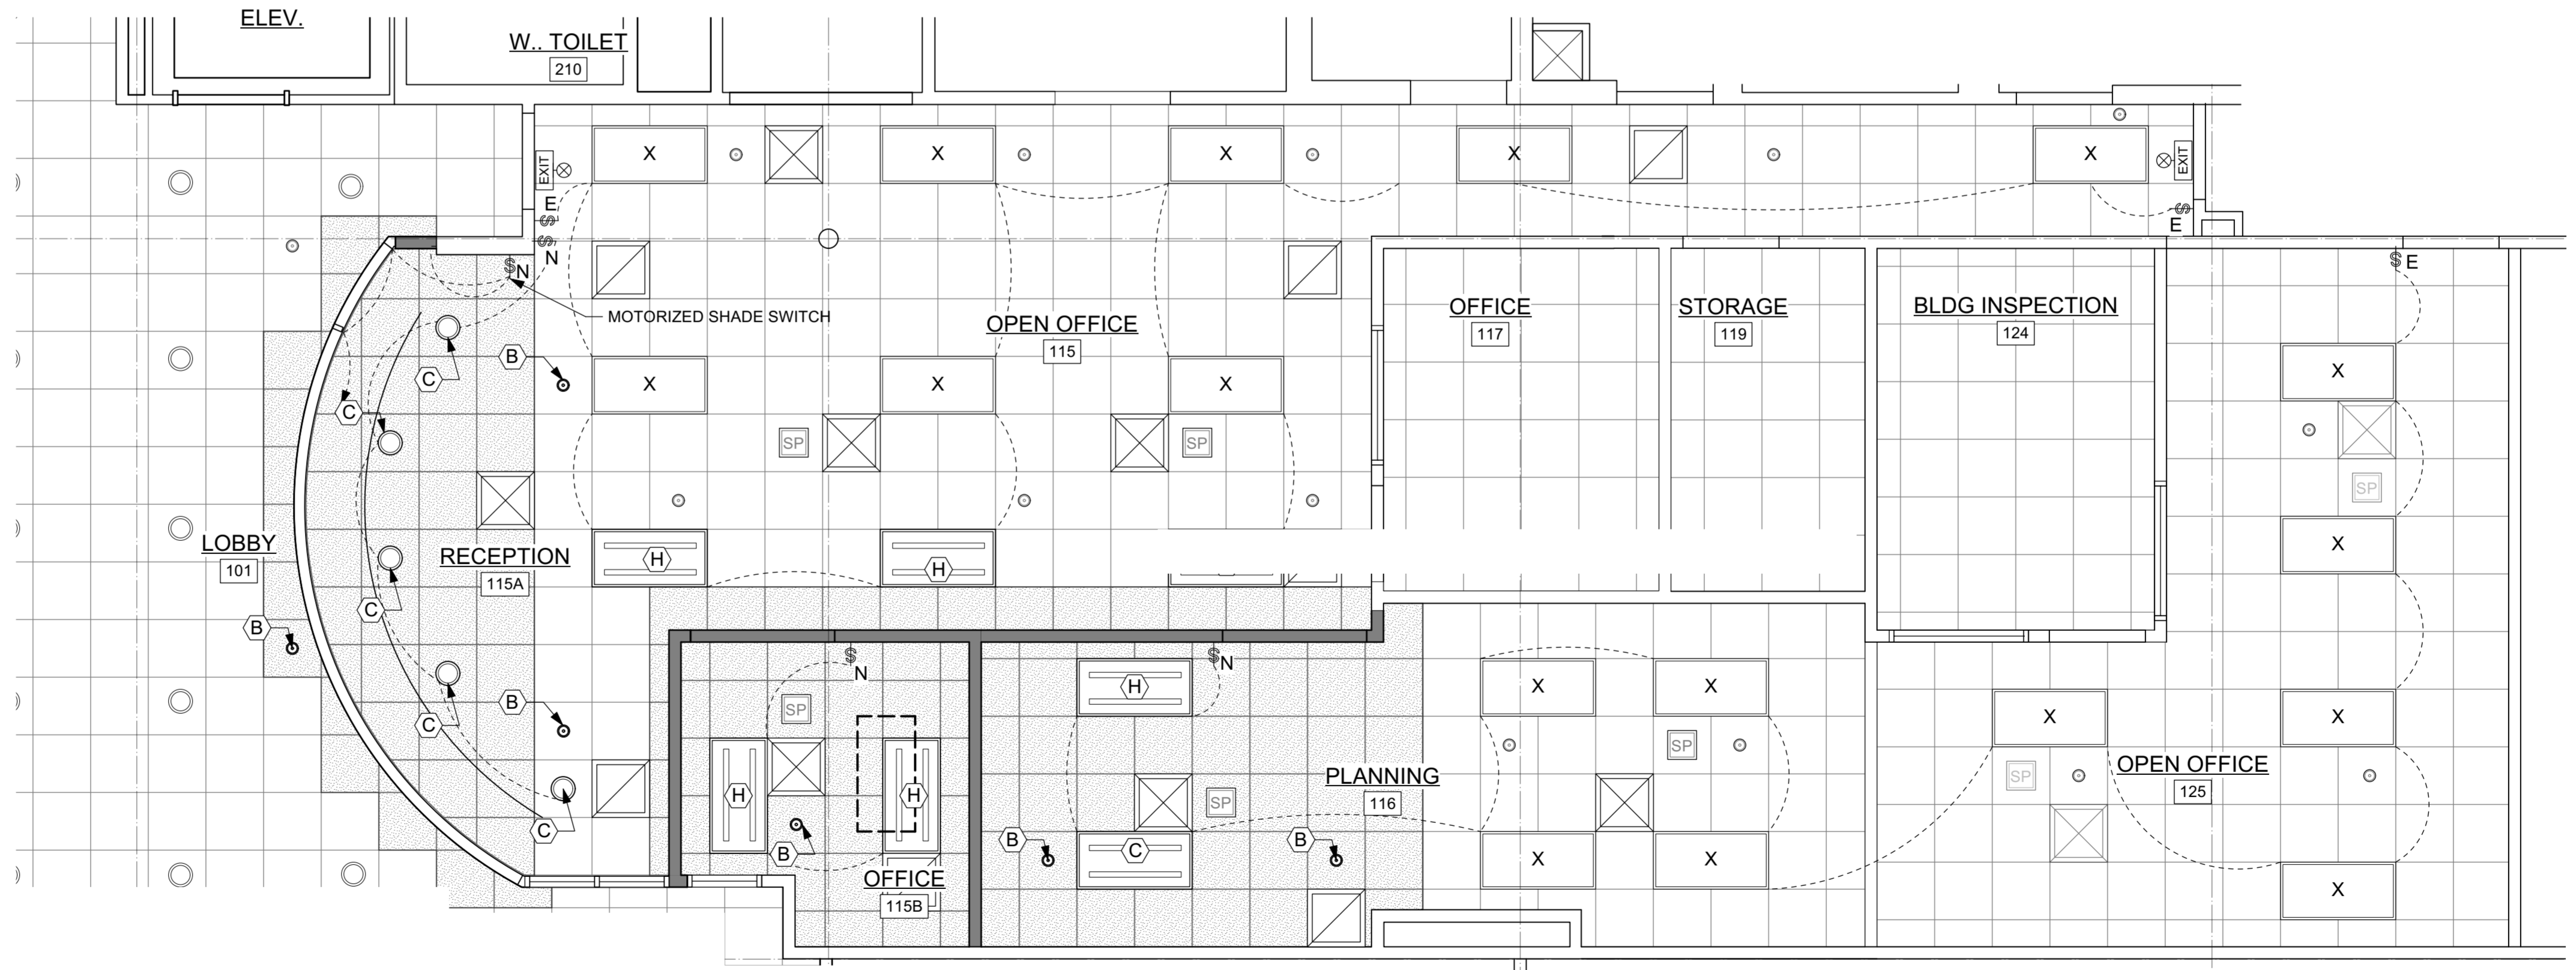


2 FIRST FLOOR LIGHTING AND FIRE PROTECTION PLAN
E/F100 Scale: 1/4" = 1'-0"




CEILING CONSTRUCTION NOTES:

- (B)** RELOCATED OR NEW SPRINKLER HEAD; LOCATION BASED ON FIRE PROTECTION REQUIREMENTS IN NEW SPACE LAYOUT
- (C)** NEW LIGHT FIXTURE AND LED LAMPS
- (H)** EXISTING LIGHT FIXTURE RELOCATED

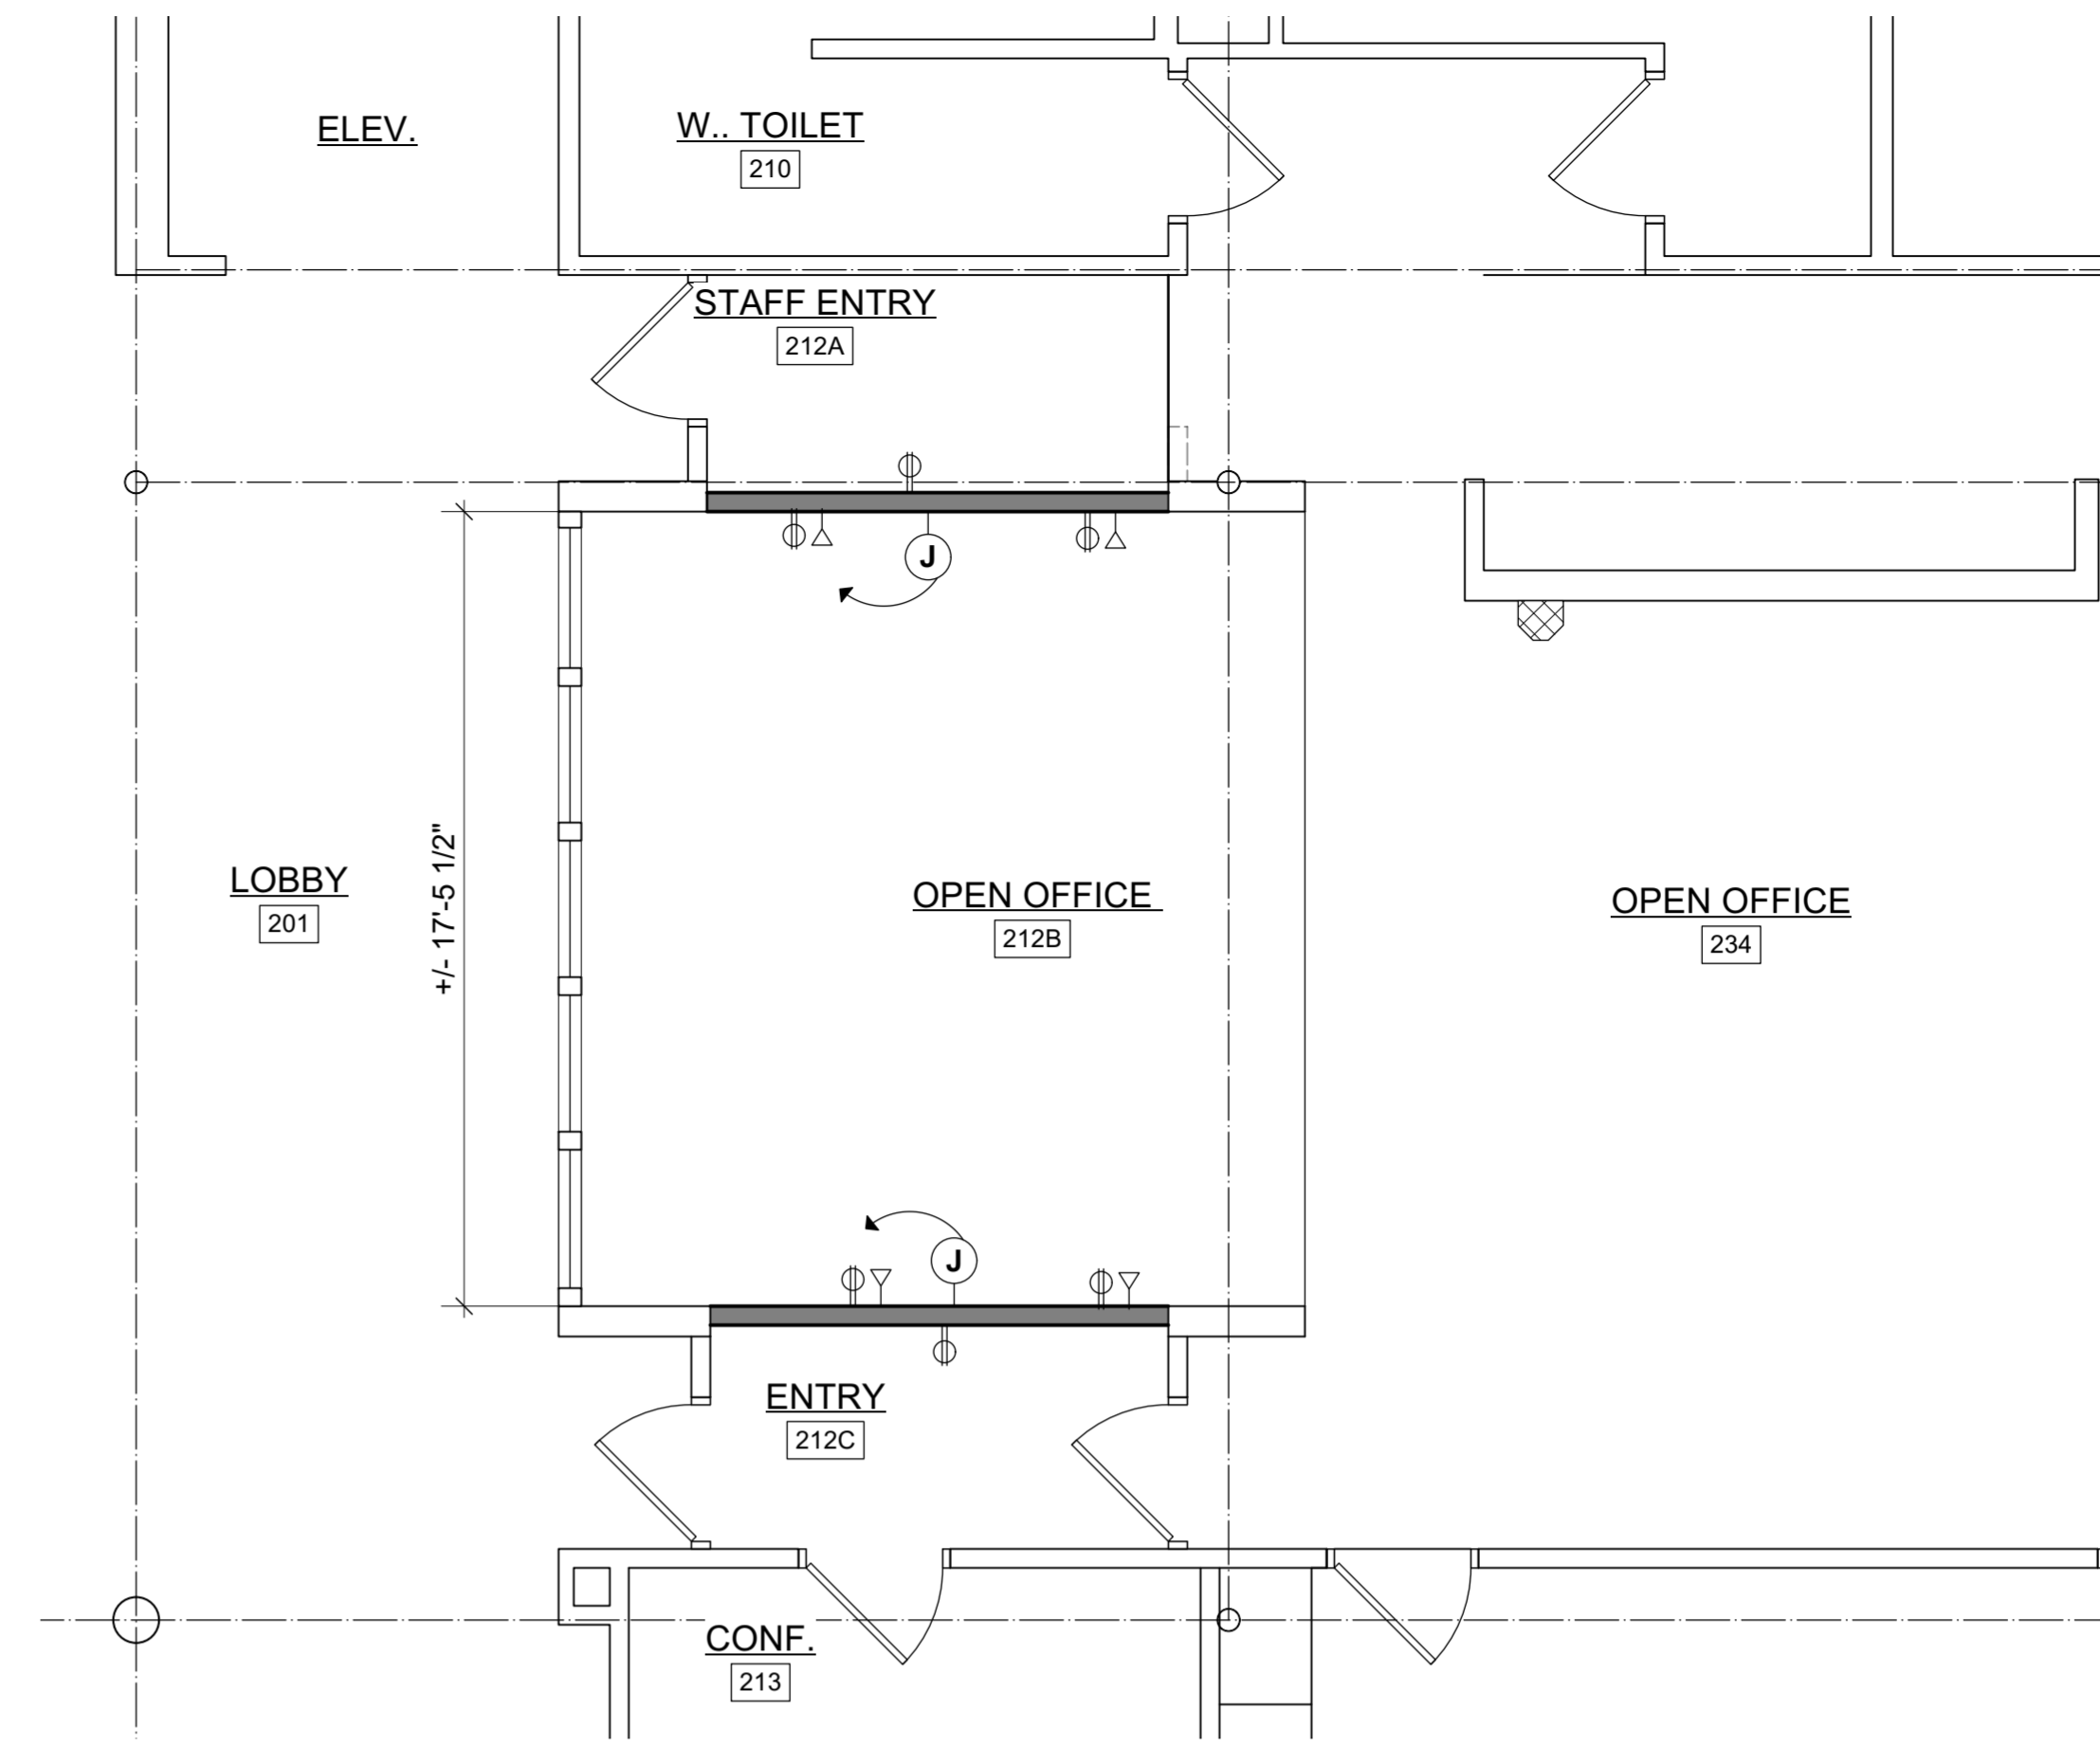

1 SECOND FLOOR NEW OPEN OFFICE POWER AND DATA PLAN
 E/F101 Scale: 1/4" = 1'-0"

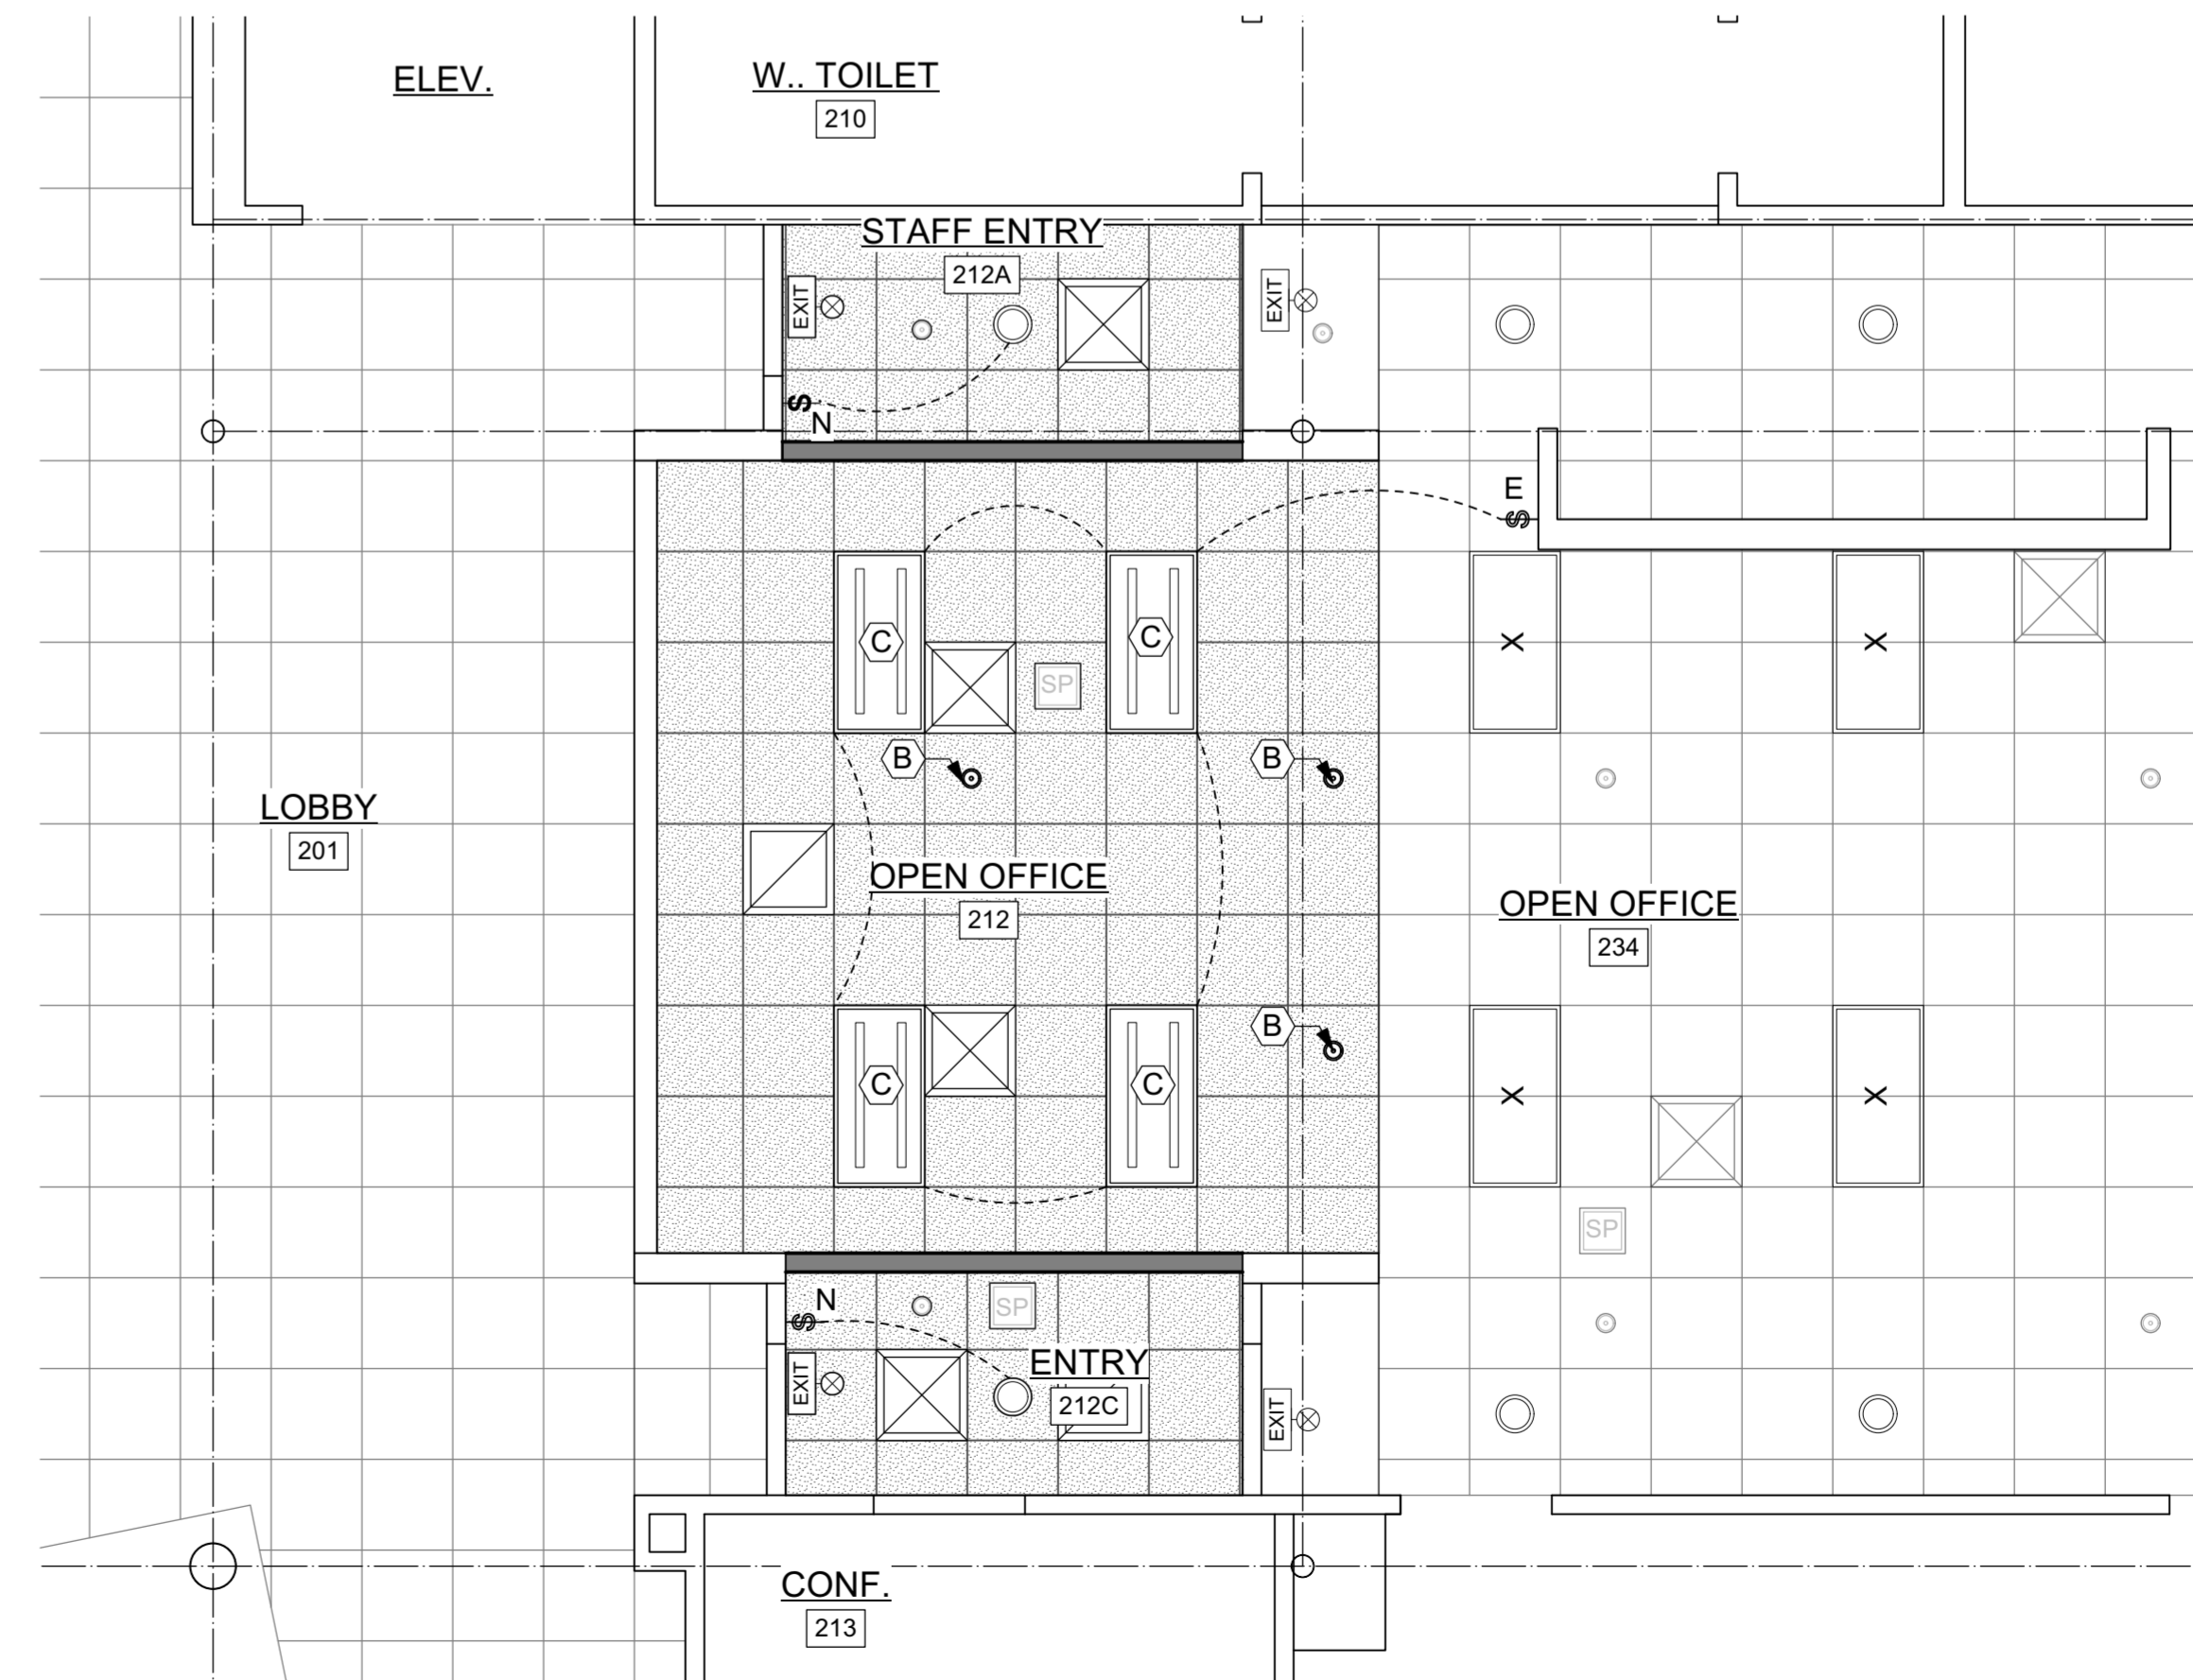


2 SECOND FLOOR LIGHTING AND FIRE PROTECTION PLAN
 E/F101 Scale: 1/4" = 1'-0"

CEILING CONSTRUCTION NOTES:


- (A) NOT USED
- (B) RELOCATED OR NEW SPRINKLER HEAD; LOCATION BASED ON FIRE PROTECTION REQUIREMENTS IN NEW SPACE LAYOUT
- (C) NEW LIGHT FIXTURE AND LED LAMPS

Revisions:

No.	Date	Description
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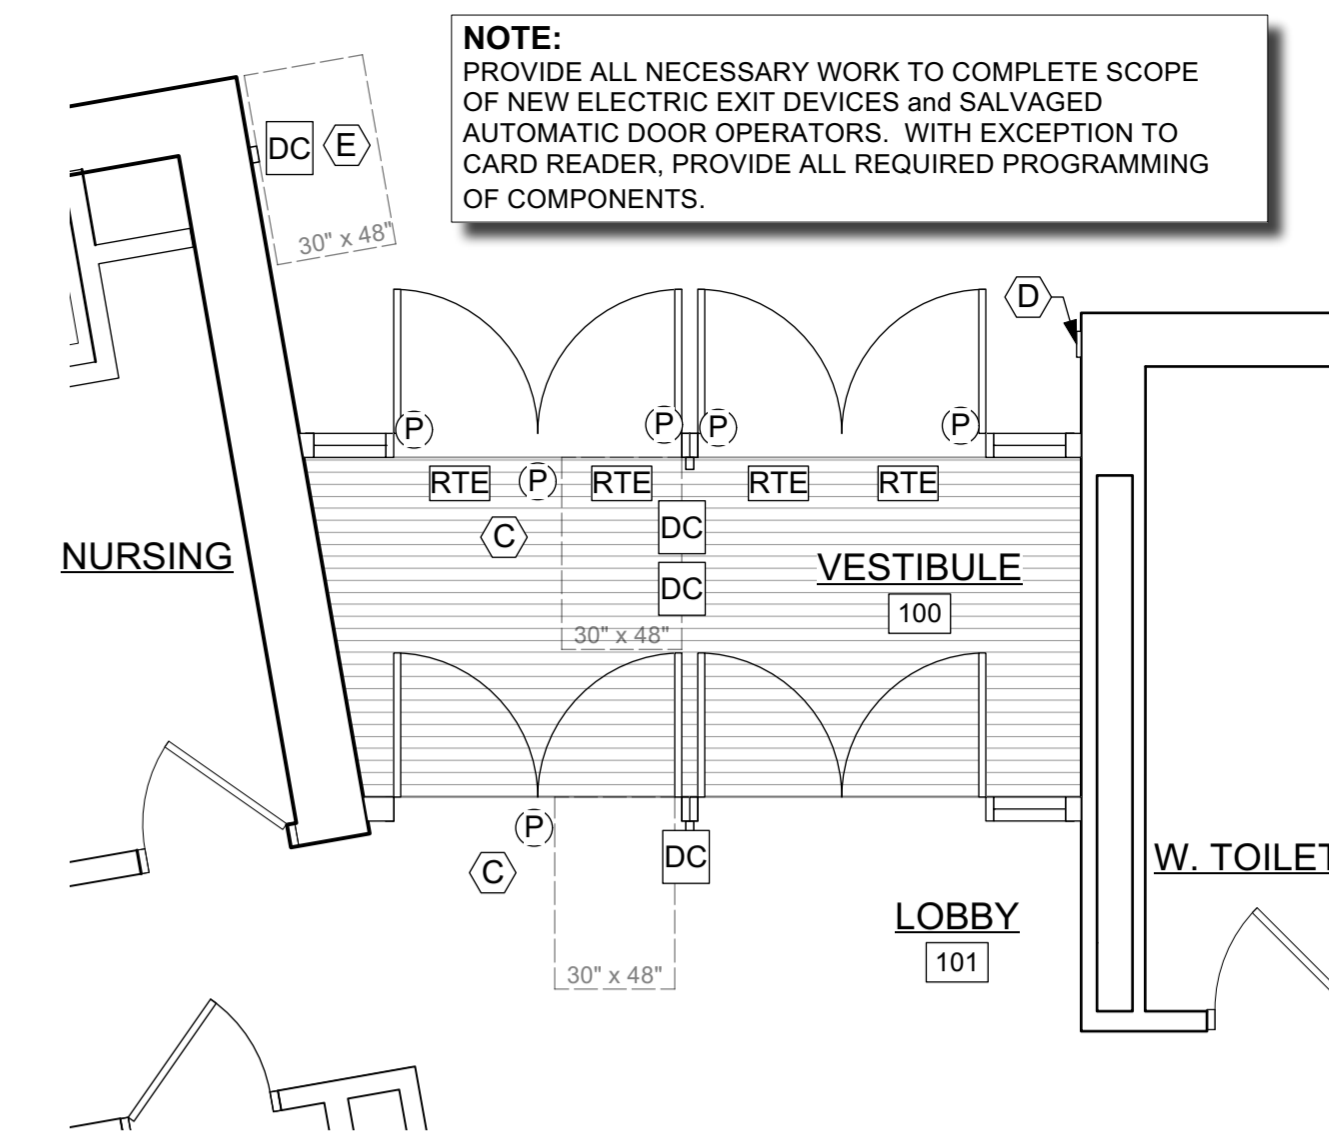
Project Number	2138
Set Type	Bidding Document
Date Issued	04/21/2023

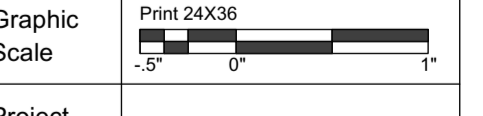

1 FIRST FLOOR VESTIBULE DOORS - DEMOLITION
E/F102 Scale: 1/4" = 1'-0" NORTH

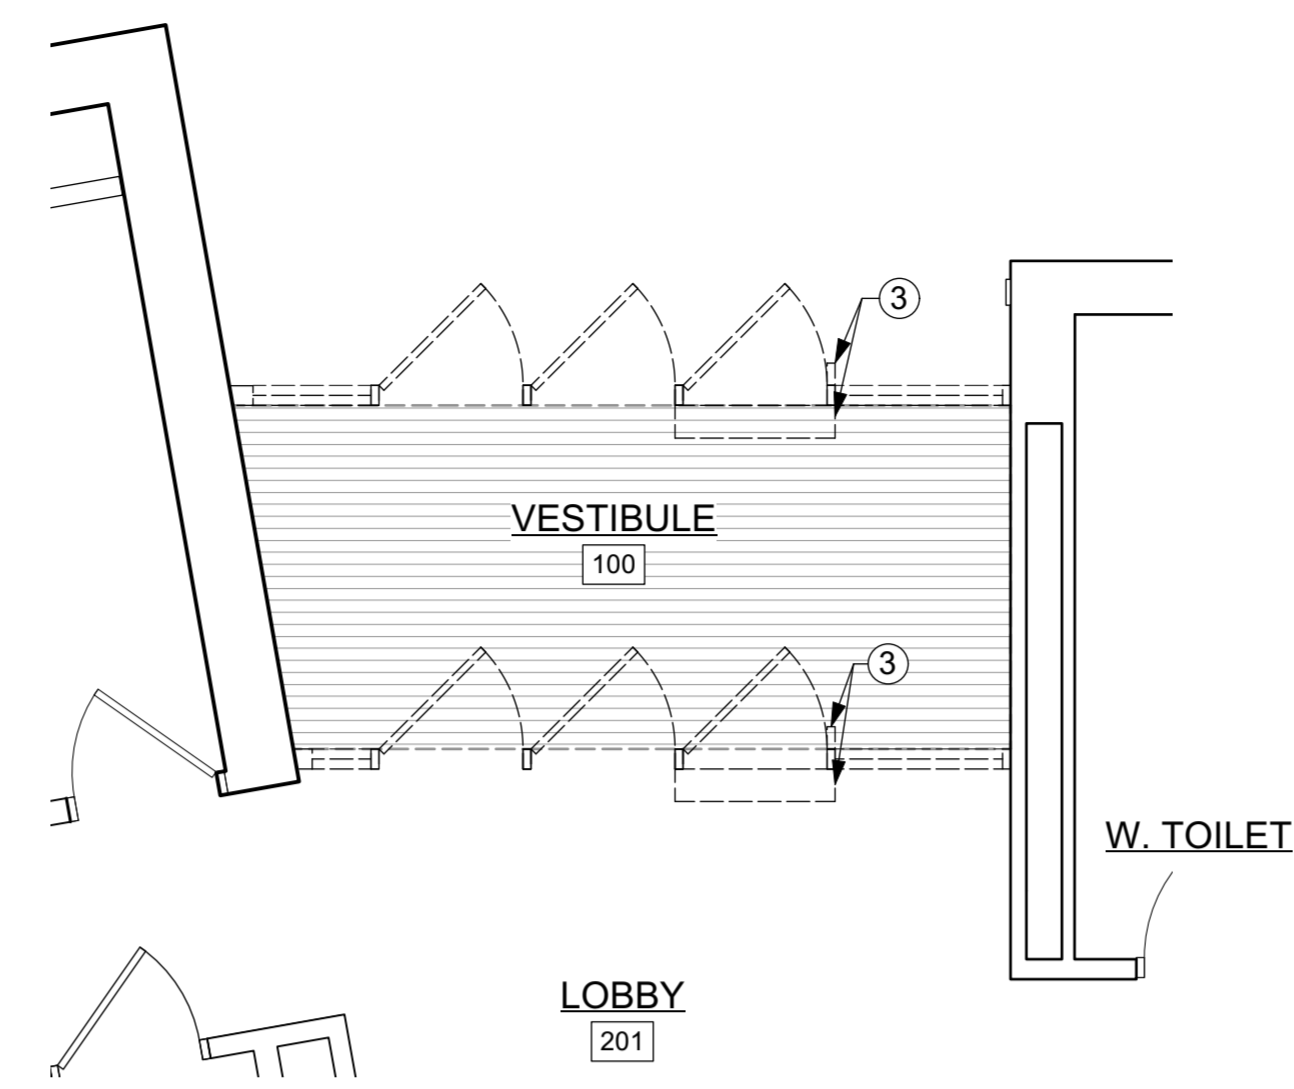VESTIBULE DEMOLITION NOTES:

- ③ REMOVE & SALVAGE AUTOMATIC DOOR OPERATOR and CONTROLS




2 FIRST FLOOR PROPOSED VESTIBULE
E/F102 Scale: 1/4" = 1'-0" NORTH

VESTIBULE CONSTRUCTION NOTES:

- Ⓒ REINSTALL AUTOMATIC SALVAGED DOOR OPERATOR WITH NEW CONTROLS AND WIRING
- Ⓓ EXISTING KEY CARD ENTRY TO BE PROGRAMMED WITH NEW DOOR SYSTEM AND REWIRED BY CONTRACTOR
- Ⓔ NEW AUTOMATIC DOOR OPERATOR, CONTROLS AND WIRING


NOTE:
PROVIDE ALL NECESSARY WORK TO COMPLETE SCOPE OF NEW ELECTRIC EXIT DEVICES and SALVAGED AUTOMATIC DOOR OPERATORS. WITH EXCEPTION TO CARD READER, PROVIDE ALL REQUIRED PROGRAMMING OF COMPONENTS.

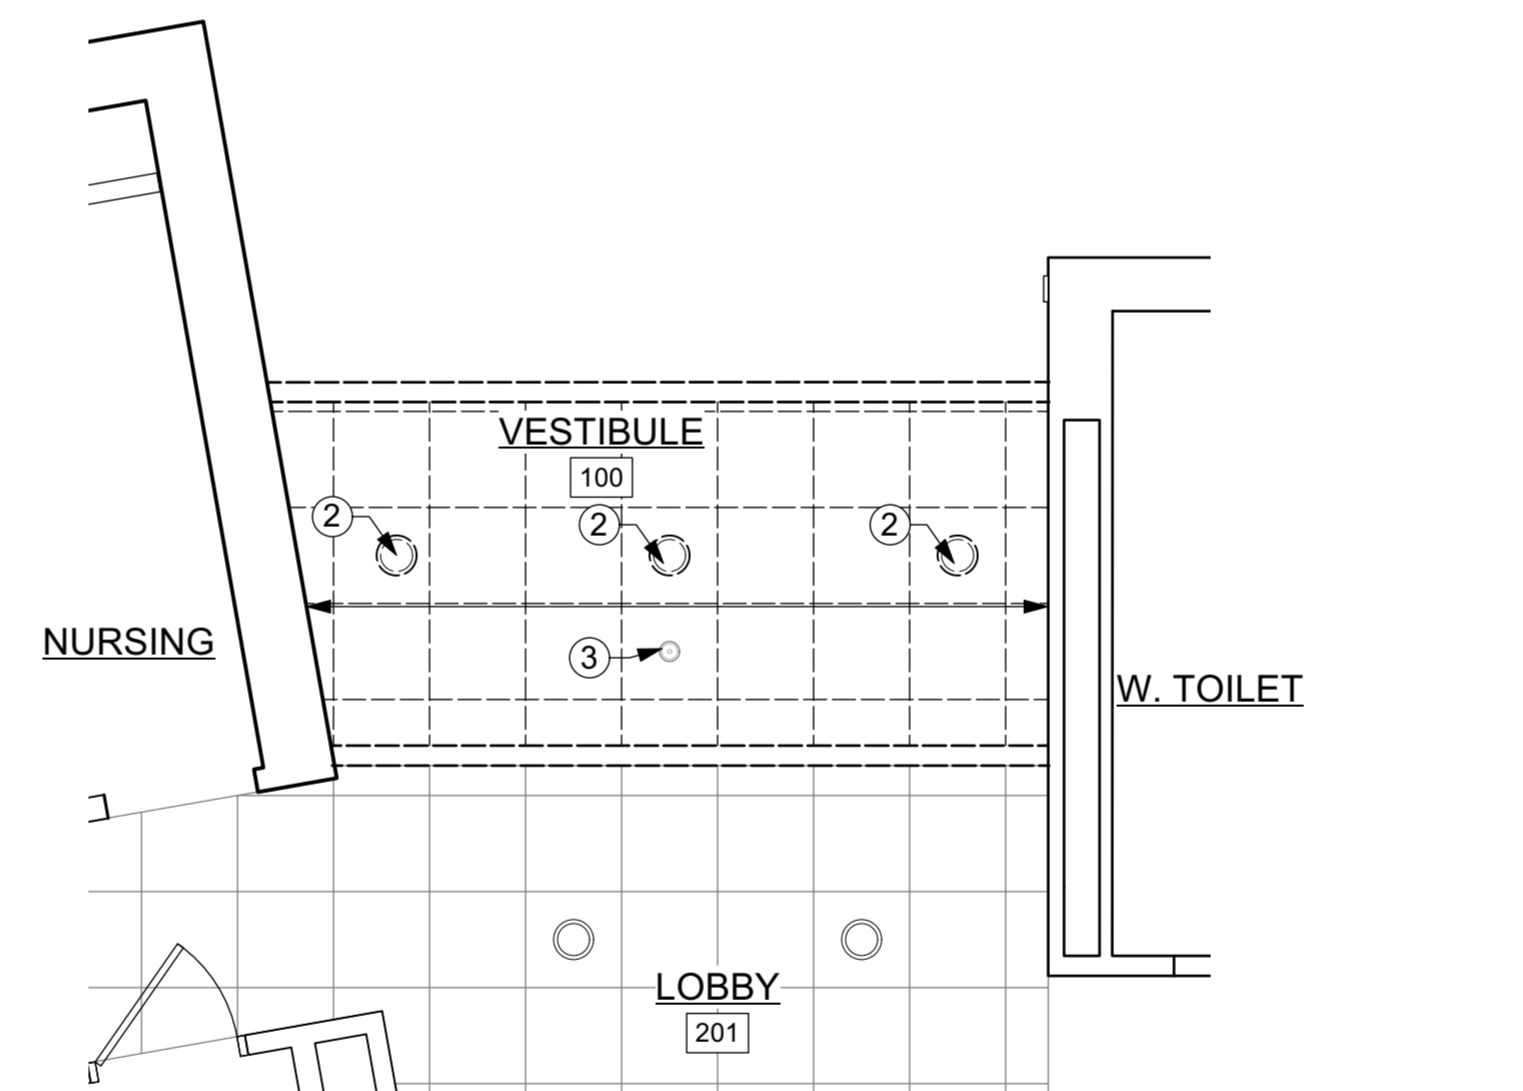

3 FIRST FLOOR VESTIBULE REFELCTED CEILING PLAN - PROPOSED
E/F102 Scale: 1/4" = 1'-0" NORTH

REFLECTED CEILING PLAN REMOVAL NOTES

- ② REMOVE LIGHT FIXTURE
- ③ REMOVE SPRINKLER HEAD AND RELOCATE BASED ON FIRE PROTECTION REQUIREMENTS AND NEW ROOM LAYOUT

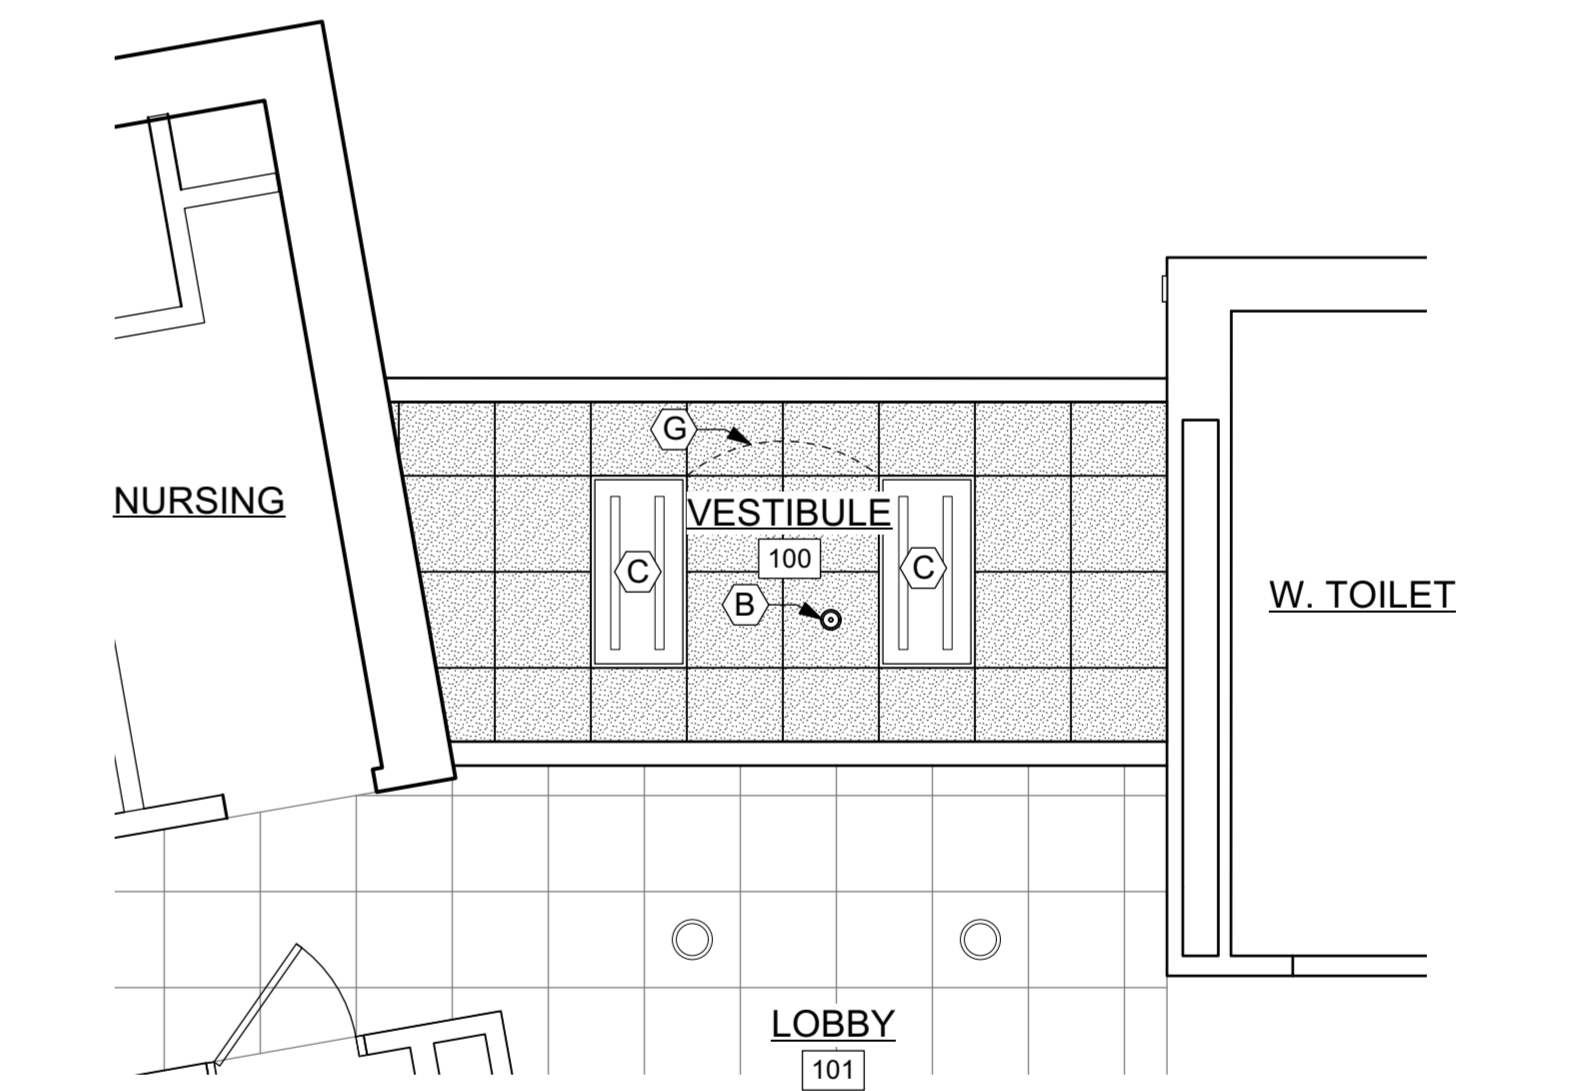

4 FIRST FLOOR VESTIBULE REFLECTED CEILING PLAN - PROPOSED
E/F102 Scale: 1/4" = 1'-0" NORTH

CEILING CONSTRUCTION NOTES:

- Ⓑ RELOCATED OR NEW SPRINKLER HEAD; LOCATION BASED ON FIRE PROTECTION REQUIREMENTS IN NEW SPACE LAYOUT
- Ⓒ NEW LIGHT FIXTURE AND LED LAMPS
- Ⓓ SWITCHING HARD WIRED TO BUILDING SYSTEM, VERIFY IN FIELD

Consultant:


Project Owner:
City of Sun Prairie
300 East Main St.
Sun Prairie, WI 53590

Project Address:
P300 East Main St.
Sun Prairie, WI 53590

1ST AND 2ND FLOOR COUNTER REMODEL AND ENTRANCE REPLACEMENT CITY OF SUN PRAIRIE Sun Prairie, WI
Sheet Title:
FIRST FLOOR ENTRY - POWER & LIGHTING AND FIRE PROTECTION

Revisions:

No.	Date	Description
02/10/2023	02/10/2023	Plan Review Documents

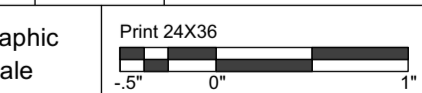

Project Number: 2138

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Date Issued: 04/21/2023

Sheet Number: **E/F102**