



GENERAL NOTES

- 1. All concrete to test 4000 psi in 28 days.
- 2. Verify all dimensions, access, utilities and working conditions in the field. Conform to all applicable codes, ordinances and safety standards.
- Obtain and pay for all required permits and fees.
 Notify Architect immediately if work cannot proceed as shown on Drawings or as described in the
- 6. No concrete to be poured without Architect's prior review.
 7. All Contractor's to co-operate with all trades, Owner's and Architect's representatives.
- 8. Leave site clean, neat and free of debris at all times. Each Prime and Sub-contractor is responsible for having read each page of the Specifications, Drawings, Addenda and Change Orders.
- 10. Guard against interfering with Owner's operations.11. These Drawings contain no provisions or procedures for on-site safety. Each Contractor and their
- employees are responsible to follow all laws and ordinances and provide their own engineering to provide a 12. The locations of existing underground utilities, shown on these Drawings, are shown in an approximate way only and have not been independently verified by the Owner or its representatives. The Contractor shall determine the exact location of all existing utilities before commencing work, and agrees to be fully responsible

for any and all damages which might be occassioned by the Contractor's failure to exactly locate and preserve

any and all underground utilities.

13. Services perform for this project have been conducted in a manner consistent with the level of care and skill ordinarily exercised by members of the profession currently practicing in this area under similar budget and time constraints. No warranty, expressed or implied, is made.

CONSULTANTS

4215 Grove Avenue

ARCHITECT **Kueny Architects**

10505 Corporate Drive, Suite 100 (262) 857-8101 Pleasant Prairie, Wisconsin 53158

Architect of Record - Jon P. Wallenkamp

Root Engineering Services, P.C. Office: 847.249.8398

Gurnee, Illinois 60031

Engineer of Record - Richard Root

SHEET INDEX

ARCHITECTURAL

01 Title Sheet

ARCHITECTURAL Work Area Plan and Graphic Standards

P200 Upper Level Enlarged Plumbing Views

ME100 Mechanical and Electrical Plans ME200 Mechanical and Electrical Schedules

#2310 Public Safety Building - North Employee Washroom Remodel

Kenosha County




1000 55th Street Kenosha, WI 53140


PROJECT INFO


Kenosha County #2310 Public Safety Building - North Employee Washroom Remodel March 16, 2023

BID SET DRAWINGS

10505 Corporate Drive, Pleasant Prairie, WI 53158 phone: 262.857.8101 web: www.kuenyarch.com

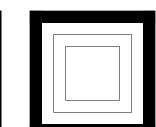

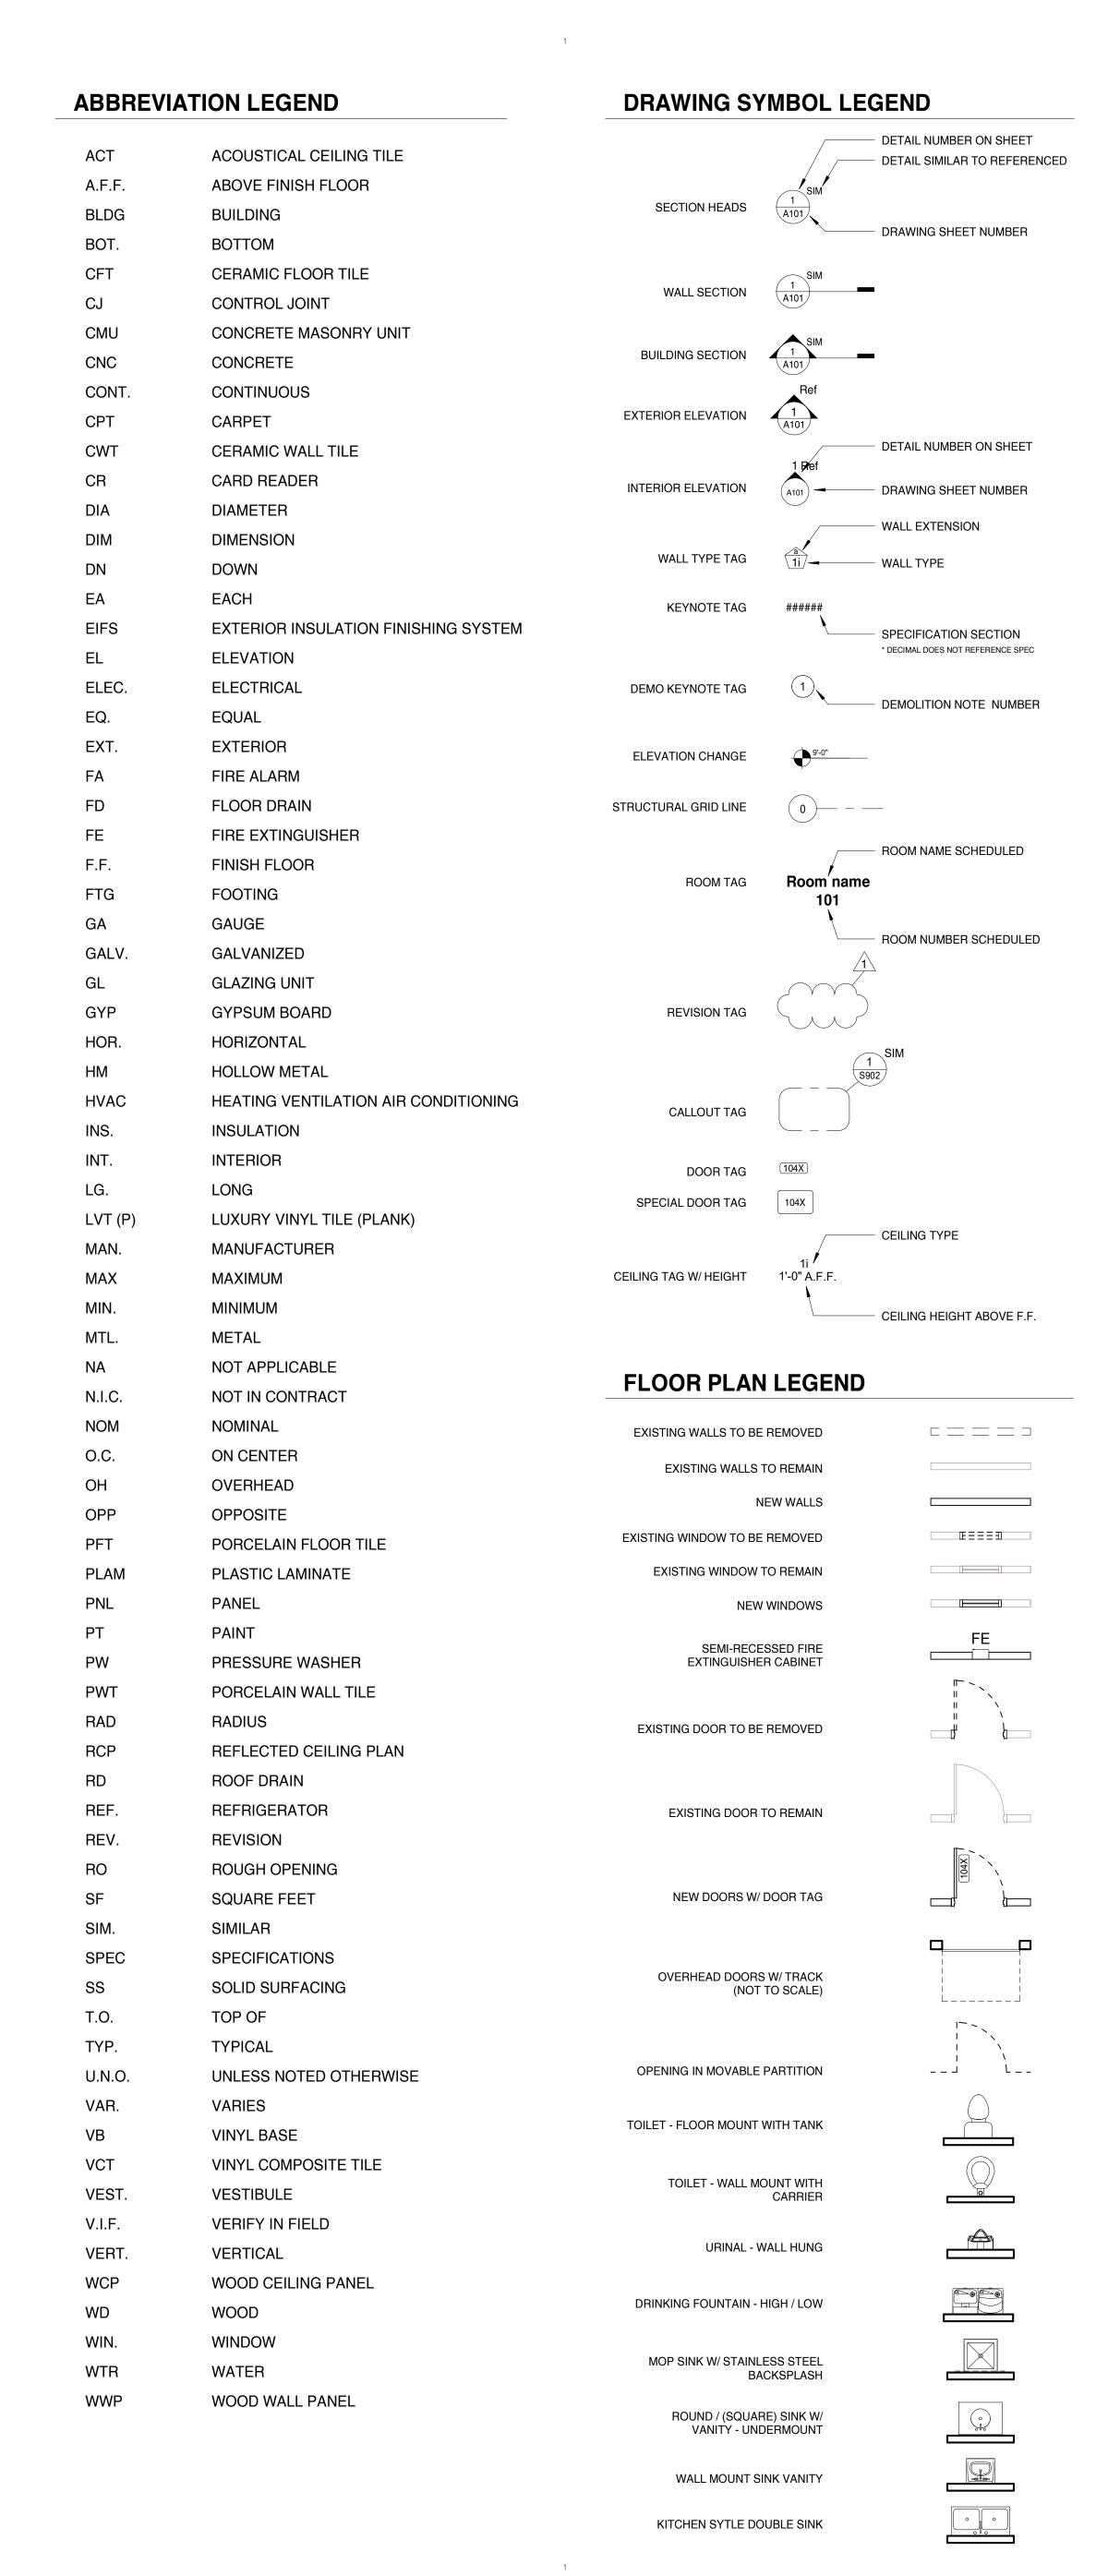

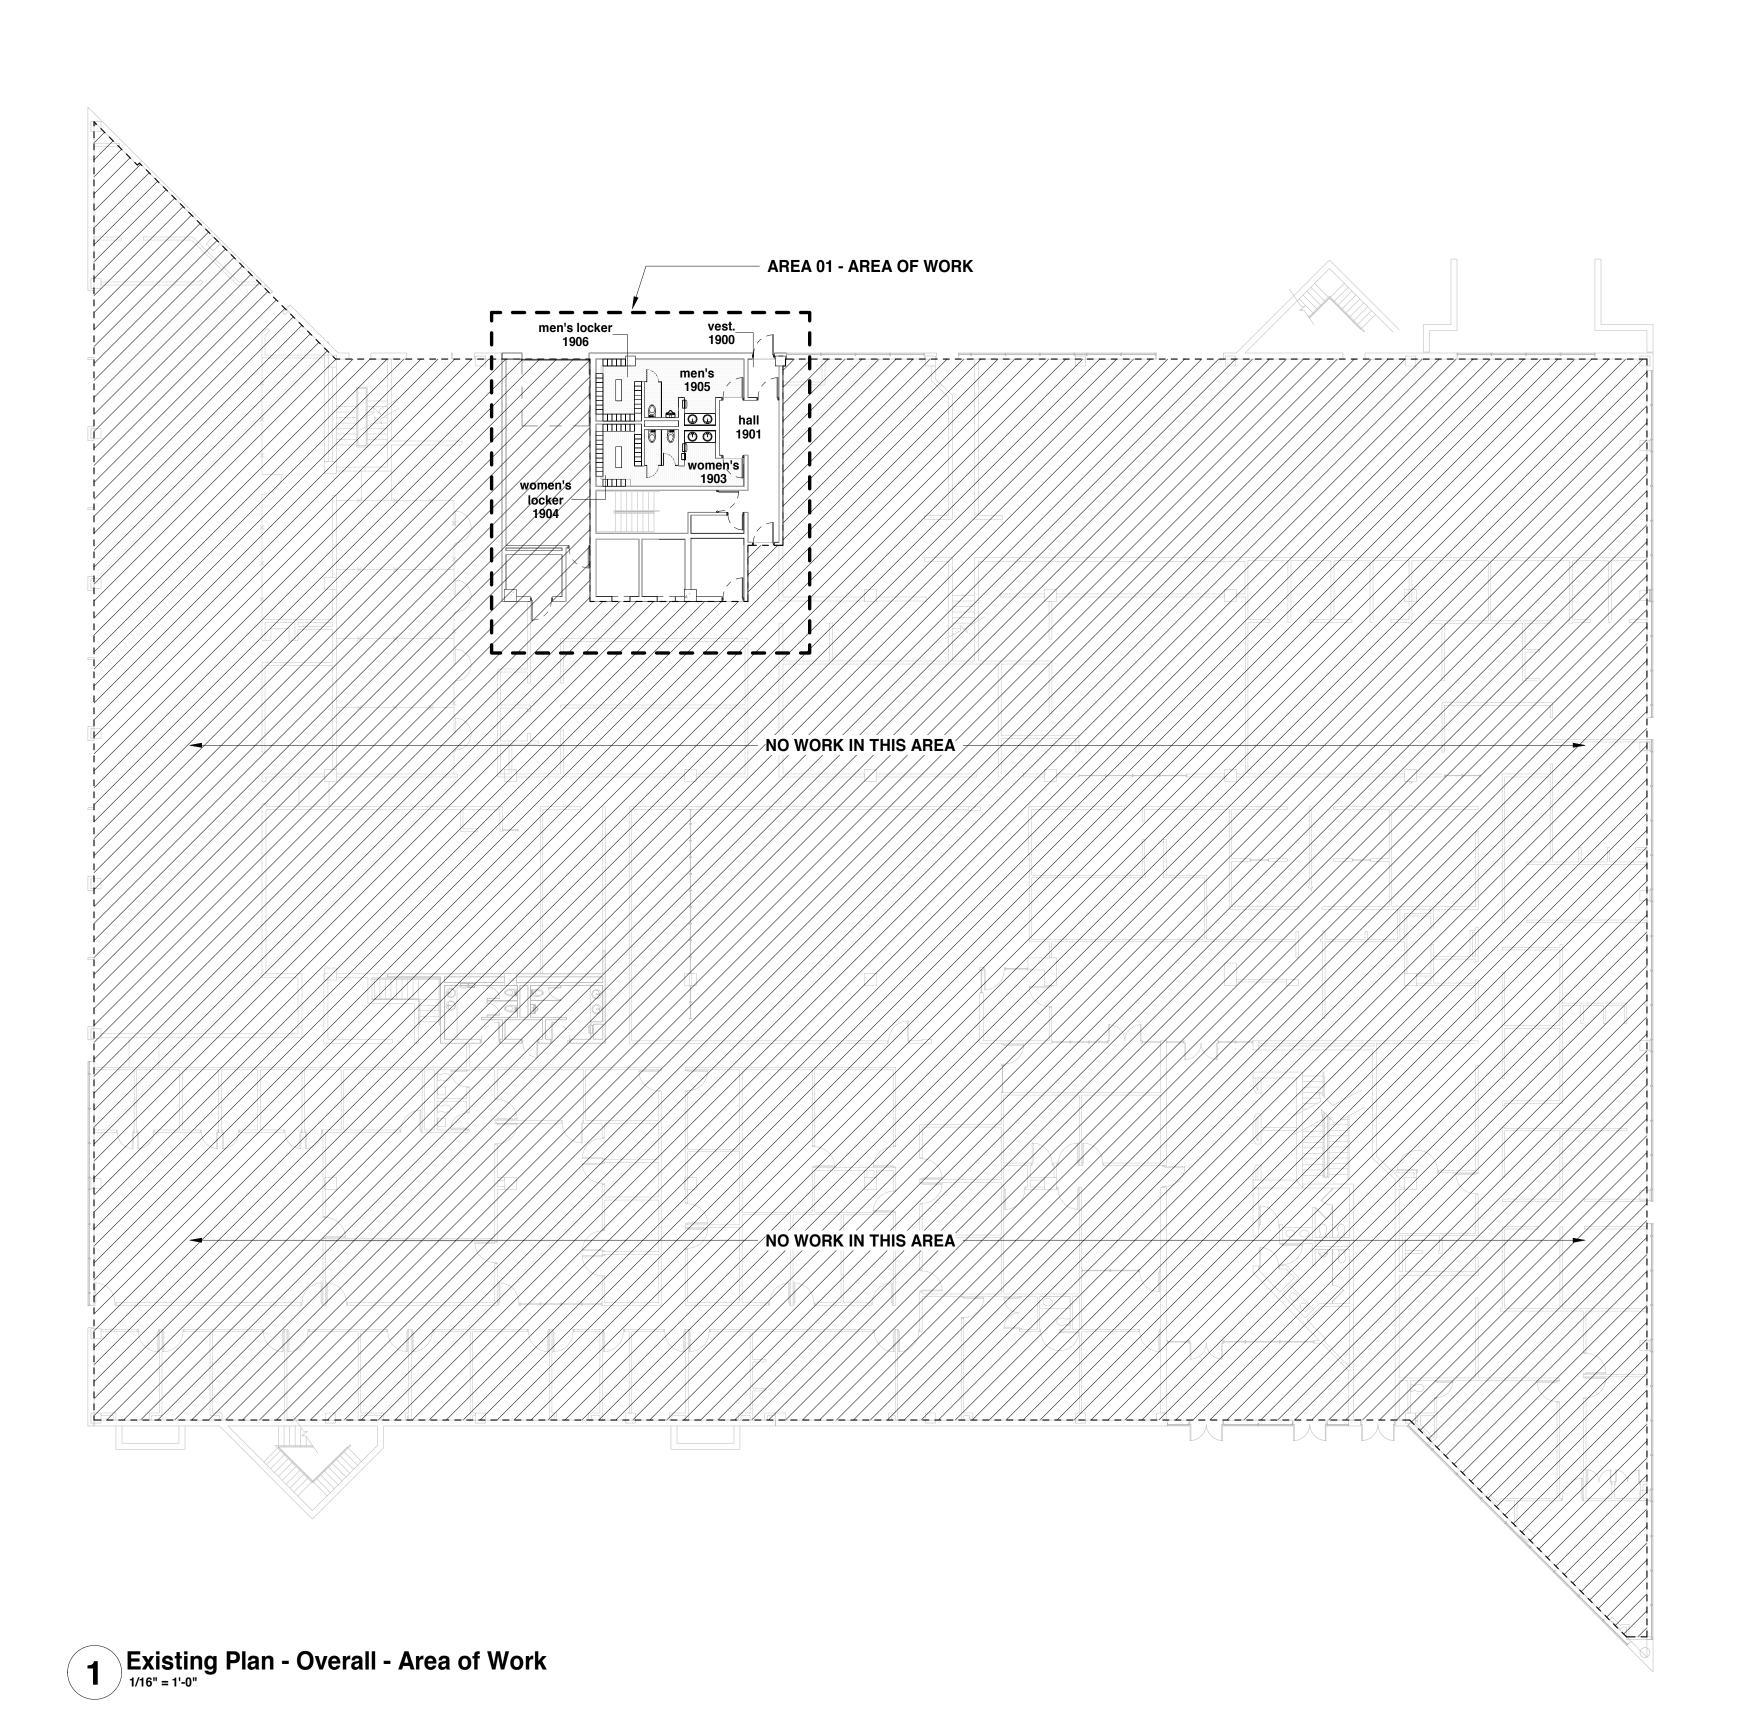

PROJECT

PROJECT:

#2310 Public Safety Building -North Employee Washroom Remodel

1000 55th Street Kenosha, WI 53140

OWNER:
Kenosha County

PROJECT ISSUE DATE:
March 16, 2023



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Architect of Record - Jon P. Wallenkamp

<u>MEP</u>


Root Engineering Services, P.C. Phone: (847) 249-8398
Address: 4215 Grove Avenue
Gurnee, Illinois 60031

Engineer of Record - Richard Root

REVISIONS

REV. / DESCRIPTION

KEY PLAN

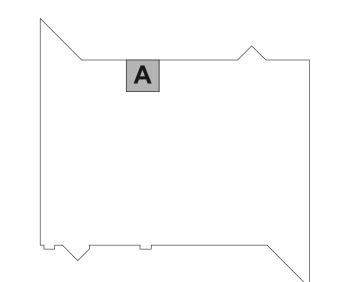



SHEET

SHEET TITLE:

Work Area Plan and Graphic Standards

A01


Bid Set Drawings



Signage Details

Standard font, Helvetica

Condensed or equal

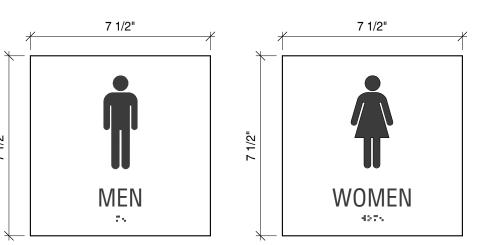

Women's Restroom Sign Men's Restroom Sign 1/8" thick photopolymer7.5(W)" x 7.5(H)" 1/8" thick photopolymer7.5(W)" x 7.5(H)" 1/32" raised letters and symbols 1/32" raised letters and symbols with Grade II Braille with Grade II Braille Foam adhesive tape installation Foam adhesive tape installation


Standard font, Helvetica

Condensed or equal


LEVER HANDLE HANDLE RESTROOM DOORS **EXIT DOORS**

ADA Signage Mounting

ADA MOUNTING STANDARDS

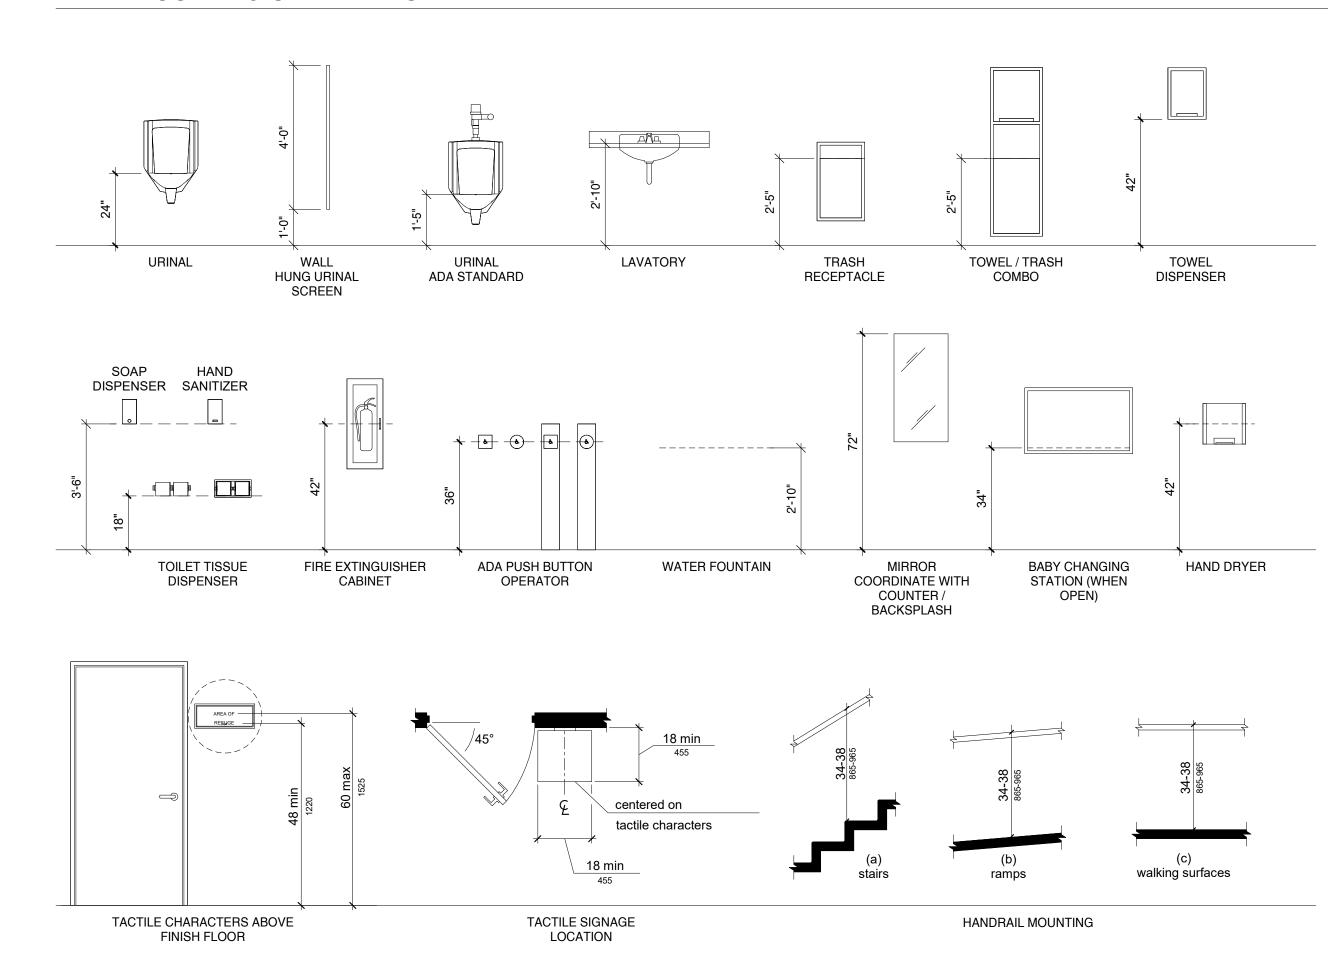

ADA CLEARANCE STANDARDS

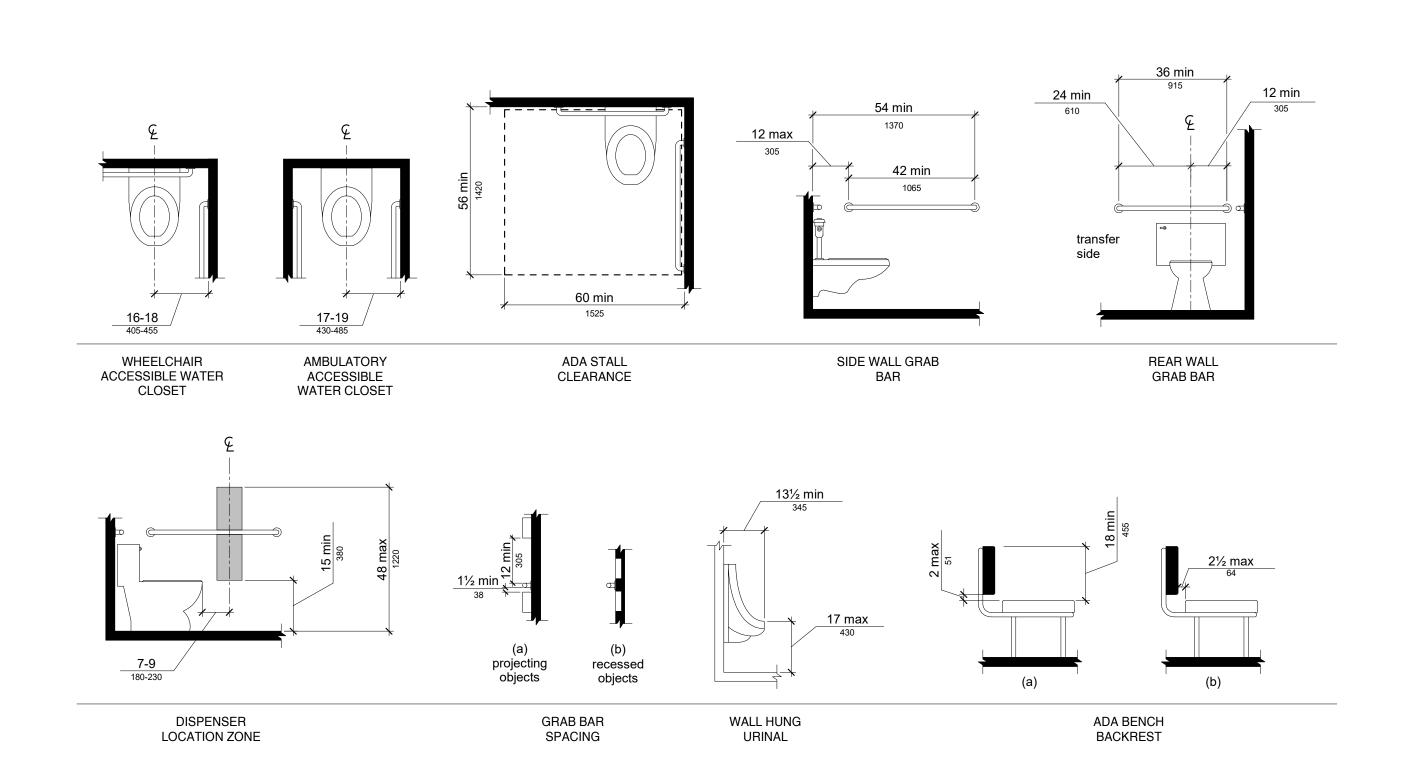

ROOM SCHEDULE - AREA 01 REMARKS HEIGHT 1903 CWT-1 ACT-2 MATCH EXISTING CFT-1 MATCH EXISTING 1905 ACT-2 MATCH EXISTING

MATCH EXISTING

9'-0" A.F.F.

F	OOM			WA	LLS					
NUM	NAME	FLOOR	NORTH	SOUTH	EAST	WEST	CEILING	METAL	WOOD	REMARKS
1903	womens	N/A	LATEX - SG	LATEX - SG	LATEX - SG	LATEX - SG	N/A	ENAMEL	VARNISH	
1904	womens locker	N/A	LATEX - SG	LATEX - SG	LATEX - SG	LATEX - SG	N/A	ENAMEL	VARNISH	
1905	mens	N/A	LATEX - SG	LATEX - SG	LATEX - SG	LATEX - SG	N/A	ENAMEL	VARNISH	
1906	mens locker	N/A	LATEX - SG	LATEX - SG	LATEX - SG	LATEX - SG	N/A	ENAMEL	VARNISH	
1908	cooridor	N/A	LATEX - SG	LATEX - SG	LATEX - SG	LATEX - SG	N/A	ENAMEL	VARNISH	

ACT-2

ACT-1

DOOR SC	DOOR SCHEDULE - AREA 01																
	FROM ROOM TO ROOM				DOOR								FRAME				
MARK	NUM	NAME	NUM	NAME	LABEL	TYPE	MATERIAL	SWING	WIDTH	HEIGHT	THICKNESS	LOUVER	GLASS	TYPE	MATERIAL	GLASS	REMARKS
E1903	1908	cooridor	1903	womens	-	F	HM	LH	3' - 4"	7' - 0"	1 3/4"	-	-			-	-
E1905	1908	cooridor	1905	mens	-	F	HM	RH	3' - 4"	7' - 0"	1 3/4"	-	-			-	-
E1909	1908	cooridor	1909	vestibule	-	FG	ALUM	LHR	3' - 4"	7' - 0"	1 3/4"	-	Χ			-	-

HARDWARE SCHEDULE - AREA 01												
MARK	LOCKSET	PUSH-PULL	HOLD OPEN	CLOSER	HINGE	DOOR STOP	THRESHOLD	WEATHERSTRIP	KICKPLATE	SOUNDSTOP	NAMEPLATE	NOTES
E1903	ENTRANCE	Х	Х	Х	X	Х	-	-	Х	Х	WOMEN'S	SEE STANDARD SIGNAGE DETAILS
E1905	ENTRANCE	Х	Х	Х	Х	Х	-	-	Х	Х	MEN'S	SEE STANDARD SIGNAGE DETAILS
E1909	PANIC	X		Х	X	Х	Х	X	Х	X	-	-



CFT-1

EXISTING

CWT-1

EXISTING

EXISTING

FRP / PT-1

EXISTING


FRP / PT-1

EXISTING


FRP / PT-1

1906


mens locker

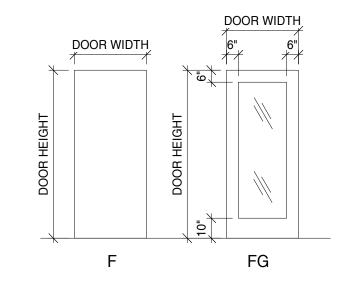


LOCKSET TYPES

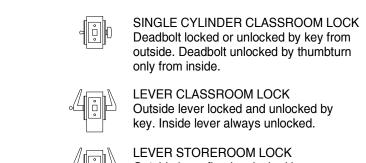

similar tool.

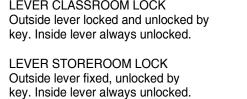

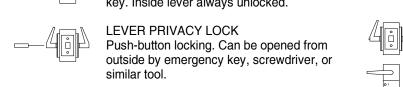


LEVER OFFICE LOCK Push-button locking. Pushing button locks outside lever until unlocked by key outside or by turning inside lever.

//₅□□¬¬\\ LEVER ENTRANCE LOCK Turn/Push-button locking. Pushing and turning button locks outside lever requiring use of key until button in manually unlocked. Push-button locking. Push button locks outside lever until locked by outside key or by turning inside lever.

COMBINATION LOCK Outside lever fixed. Entrance by use of multi-digit combination. Inside lever always unlocked.

ACCESSIBLE ROUTE STANDARDS

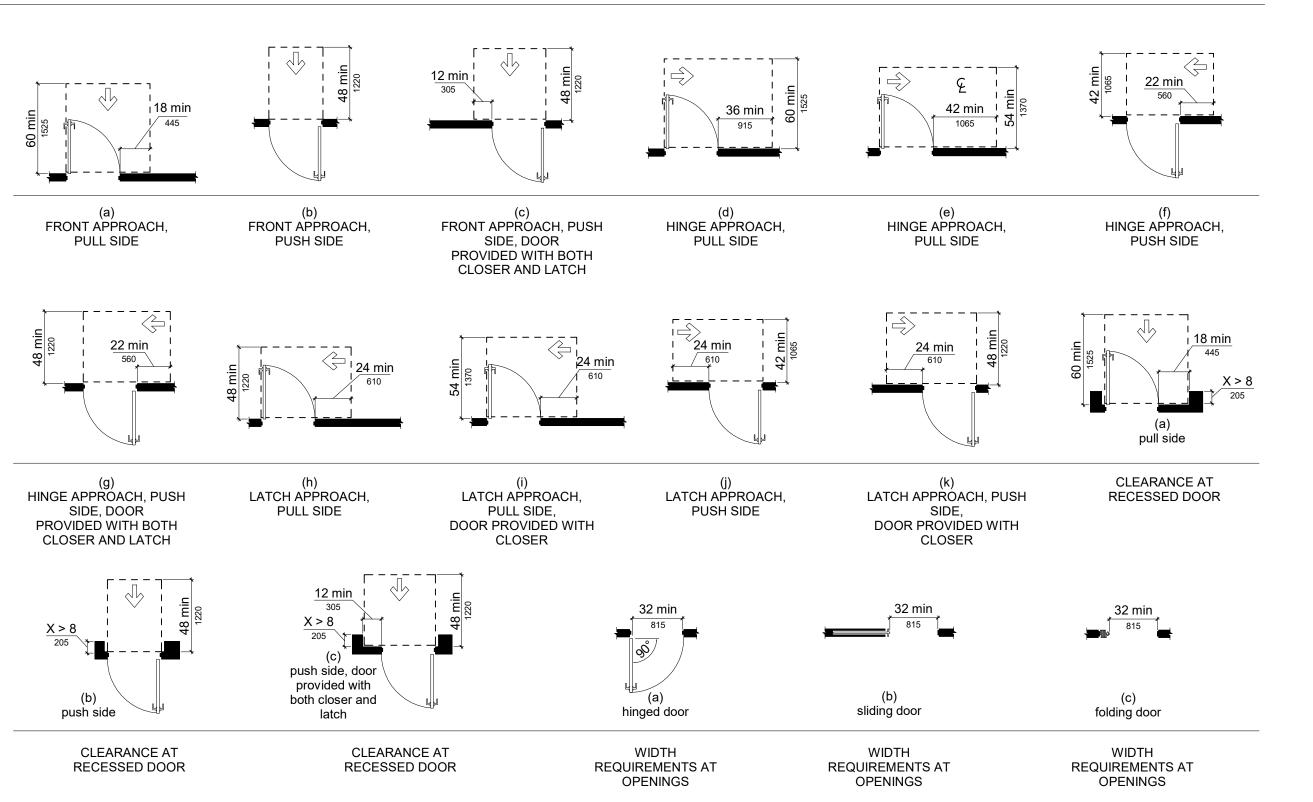

PROJECT

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1000 55th Street Kenosha, WI 53140

OWNER: Kenosha County

> PROJECT ISSUE DATE: March 16, 2023



10505 Corporate Drive, Pleasant Prairie, WI 53158 phone: 262.857.8101 web: www.kuenyarch.com

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Architect of Record - Jon P. Wallenkamp

<u>MEP</u>

Root Engineering Services, P.C.


Phone: (847) 249-8398

Address: 4215 Grove Avenue Gurnee, Illinois 60031

Engineer of Record - Richard Root

REVISIONS

REV. / DESCRIPTION

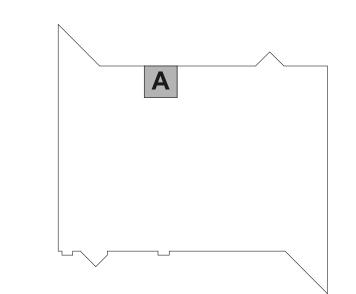

SCALE: As indicated

SHEET TITLE:

Project Standards and Schedules

Bid Set Drawings

- 2 DEMO EXISTING FRP PANEL; PATCH AND PREP WALL FOR NE PANEL
- AND PAINT; DEMO TO INLOUDE ALL PANELS IN CORRIDOR
- 3 DEMO EXISTING ACOUSTICAL CEILING TILE SYSTEM; DEMO TO INCLUDE ALL TILE AND EXISTING GRID
- DEMO EXISTING FLOOR TILE DOWN TO SLAB, CLEAN AND PREP FOR NEW FLOOR FINISH; SEE FLOOR FINISH PLAN
- 5 STRIP AND SAND EXISTING BENCH TOP; PREP FOR NEW FINISH
- 6 DEMO EXISTING PARTITIONS; DEMO INLCUDES FULL PARTITION SYSTEM
- 7 DEMO EXISTING PLUMBING FIXTURE; REFER TO MEP PLANS FOR NEW FIXTURE ANY UN-USED EXISTING ROUGH IN HOLE TO BE COVERED WITH NEW STAINLESS STEEL COVER PLATE
- 8 DEMO EXISTING WALL TILE; PREP WALL FOR NEW FINISHES PER SCHEDULES AND ELEVATIONS
- 9 DEMO EXISTING WALL TILE BASE AT EXISTING LOCKERS
- (10) DEMO EXISTING SANITARY NAPKIN DISPENSER
- (11) REMOVE EXISTING TOILET ACCESSORIES AND GIVE TO COUNTY FRO RE-USE OR DISPOSAL
- 12) DEMO EXISTING MIRROR
- 13) DEMO EXISTING VANITY; DEMO INLCLUDES COMPLETE VANITY
- PREP FLOOR FOR PROPOSED FLOOR FINISH; G.C. TO GRIND DOWN SECTION OF CONCRETE SLAB AT DOOR IN NEEDED FOR NEW WALK-OFF MAT
- (15) DEMO EXISTING LIGHT FIXTURE
- DEMO EXISTING SUPPLY AND RETURN GRILLE; REPLACE WITH NEW LAY IN STYLE FIXTURE
- 17) DEMO EXISTING GYPSUM BOARD AND METAL STUD CEILING; VERIFY ABOVE CEILING CONDITIONS PRIOR TO DEMILITION
- 18 ALL EXISTING FIRE SPRINKLER HEADS TO REMAIN IN CURRENT LOCATION; REPOSITION TO NEW CEILING GRID CENTER IN TILE
- (19) REMOVE EXISTING WALL PAPER; ENTIRE CORRIDOR; PREP AND PATCH WALL FOR NEW PAINT

DEMO GENERAL NOTES

INSTALLATION OF THEIR WORK.

- 1. DEMOLITION NOTES AND PLANS ARE PROVIDED AS A REFERENCE. CONTRACTOR TO VERIFY EXISTING CONDITIONS AND EXAMINE DRAWINGS AND DETAILS TO DETERMINE EXTENT AND LIMITS OF DEMOLITION REQUIRED TO ACCOMMODATE NEW CONSTRUCTION.
- 2. PROVIDE AND COORDINATE ALL DEMOLITION AND NEW CONSTRUCTION WITH PROPOSED PLAN DIMENSIONS AND INSTALLATION OF NEW MATERIALS AND FINISHES. DEMOLITION TO BE IN ACCORDANCE WITH NEW FINAL PRODUCT.
- 3. PROVIDE SMOOTH AND CLEAN SURFACE TO ALL AREAS RECEIVING NEW FINISHES. COORDINATE WORK WITH PLANS AND THE ROOM FINISH SCHEDULE TO COMPLY WITH NEW PROPOSED MATERIAL.
- 4. ALL RELATED WOOD BLOCKING, HARDWARE CONNECTION DEVICES, ADHESIVES, AND/OR MASTIC SHALL BE REMOVED FROM SURFACES AT ITEMS NOTED FOR DEMO. PROVIDE SURFACES ACCEPTABLE FOR PATCHING AND/OR NEW CONSTRUCTION.
- 5. IDENTIFICATION AND/OR ABATEMENT OF HAZARDOUS MATERIALS IS NOT PART OF THIS SCOPE OF WORK. IF ASBESTOS OR OTHER HAZARDOUS MATERIALS ARE ENCOUNTERED, THE CONTRACTOR SHALL NOTIFY THE OWNER IMMEDIATELY.
- 6. REMOVE LOOSE PAINT AND MISCELLANEOUS HANGING OBJECTS FROM WALLS AND CEILINGS AT ALL AREAS TO RECEIVE NEW FINISHES.
- 7. OPENING IN THE EXISTING STRUCTURE SMALLER THAN 12" IN ANY DIRECTION ARE NOT IDENTIFIED ON THESE DRAWINGS. SUB-CONTRACTORS SHALL BE RESPONSIBLE FOR PROVIDING OPENINGS SMALLER THAN 12" AS REQUIRED FOR
- 8. OPENINGS IN THE EXISTING STRUCTURE SHALL NOT BE MADE WITHOUT PRIOR APPROVAL OF THE STRUCTURAL ENGINEER.
- 9. PATCH AND REPAIR ALL EXISTING FLOOR SLABS AND WALL SURFACES DAMAGED FROM DEMOLITION OR PRIOR USE.
- 10. CONTRACTOR TO FIELD VERIFY ALL EXISTING DIMENSIONS AND CONDITIONS. IN THE EVENT OF A DISCREPANCY BETWEEN THE DRAWINGS AND THE EXISTING
- 11. DO NOT REMOVE ANY ITEMS WHICH JEOPARDIZE THE STRUCTURAL INTEGRITY OF THE BUILDING. IF HIDDEN ELEMENTS OR DETERIORATED ELEMENTS ARE ENCOUNTERED, NOTIFY THE ARCHITECT IMMEDIATELY.

CONDITIONS, NOTIFY THE ARCHITECT BEFORE PROCEEDING.

- 12. EXISTING BUILDING IS TO REMAIN WEATHER-TIGHT DURING ALL DEMOLITION ACTIVITIES.
- 13. PROTECT ALL ADJACENT AREAS AND ITEMS "TO REMAIN" DURING DEMOLITION/CONSTRUCTION. REPAIR/REPLACE ALL ITEMS DAMAGED DURING CONSTRUCTION.
- 14. EXISTING BUILDING CONDITIONS SHOWN ON THESE DRAWINGS ARE DERIVED FROM DRAWINGS OF THE ORIGINAL BUILDING AND FROM LIMITED FIELD OBSERVATION.
- 15. INDICATED EXISTING BUILDING CONDITIONS ARE ASSUMED TO BE REPRESENTATIVE OF THE ACTUAL CONSTRUCTION OF THE BUILDING. FIELD CONDITIONS MAY VARY.
- 16. THE CONTRACTOR SHALL PROVIDE AND MAINTAIN ADDITIONAL MEANS OF EGRESS AS NEEDED AS A RESULT OF CONSTRUCTION SEQUENCING AND/OR REGULATORY REQUIREMENTS.
- 17. KEYNOTES THAT CONTAIN NO LEADER LINE ARE TO BE CONSIDERED TO ADDRESS THE ENTIRE ROOM THE NOTE IS PLACED.
- 18. PATCH ALL AREAS OF ELECTRICAL AND MECHANICAL DEMOLITION THAT WILL NOT BE REUSED.

KEYED NOTE LEGEND

- 1 RE-FINISH BENCH TOP; RE-PAINT METAL BENCH LEGS
- NEW TOILET PARTITION; REFER TO SPECIFICATIONS
- (09 29 00) INFILL EXISTING WALL CAVITY AT REMOVED SANITARY NAPKIN DISPENSER; INFILL WITH METAL STUD AND TILE BACKER;
- PREP FOR NEW WALL TILE FINISH

 A NEW TOILET PAPER DISPENSER; OWNER PROVIDED, G.C. TO INSTALL
- (06 10 00) NEW FRP PANEL AT CORRIDOR; FULL CORRIDOR PERIMETER

(1) (10 28 13) NEW MIRROR; REFER TO SPECIFICATIONS AND ELEVATIONS

- 6 SOAPR DISPENSER; OWNER PROVIDED, G.C. TO INSTALL
- (8) EXISTING RECESSED WASTE RECEPTACLE TO REMAIN; G.C. TO
- 10 FIELD VERIFY EXISTING CEILING HEIGHT; MATCH HEIGHT

CONSTRUCTION

- CEILING MOUNT PARITION; RE-USE EXISTING CEILING MOUNT STEEL
- EXISTING ILLUMINATED EXIT SIGN TO REMAINL; E.C. TO REPLACE IN NEW CEILING

GENERAL PROJECT NOTES

- 1. DO NOT SCALE REPLICATED PRINTS OR REPRODUCTIONS.
- 2. DRAWING SHEET A01 DOES NOT REPRESENT ALL SYMBOLS AND DIAGRAMS IN THE PROJECT. THIS SHEET REPRESENTS TYPICALLY ENCOUNTERED ITEMS. NOT ALL ITEMS SHOWN MAY OCCUR WITHIN THE SCOPE OF THIS PROJECT AND OTHER ITEMS MAY EXIST IN THE PROJECT NOT ON THIS SHEET. REFER TO COMPLETE SPECIFICATIONS AND DRAWING DOCUMENTATION SET FOR
- 3. FIELD VERIFY ALL EXISTING DIMENSIONS SHOWN.

COMPLETE SCOPE OF WORK.

 G.C. TO VERIFY ALL EXISTING WALL CONDITION AFTER TILE DEMOLITION; VERIFY ARCHITECT OF ANY UNFORESEEN CONDITIONS.

MATERIAL FINISH LEGEND

1. CFT-1: CERAMIC FLOOR TILE - 12" X 12" - REFER TO

SPECIFICATIONS FOR MORE INFORMATION

2. CWT-1: CERAMIC WALL TILE - 12" X 24"; STACK BOND

SPECIFICATIONS FOR MORE INFORMATION

INSTALLATION - REFER TO SPECIFICATIONS FOR MORE INFORMATION

3. CTWB-1: CERAMIC WALL BASE - 4" WALL BASE - TILE CUT SIDE DOWN - REFER TO SPECIFICATIONS FOR MORE INFORMATION

4. GWB-1: GYPSUM BOARD; PAINT PER SCHEDULES - REFER TO

5. GWB-1: GYPSUM BOARD; PAINT PER SCHEDULES - REFER TO SPECIFICATIONS FOR MORE INFORMATION

ARCHIECIS

PROJECT

#2310 Public Safety Building - North Employee Washroom

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one. 202.007.0101 web. www.kuenya

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ARCHITECT

PROJECT:

Remodel

OWNER:

Kenosha County

March 16, 2023

1000 55th Street

Kenosha, WI 53140

PROJECT ISSUE DATE:

Kueny Architects
Phone: (262) 857-8101
Address: 10505 Corporate Drive, Suite 100
Pleasant Prairie, Wisconsin 53158

Architect of Record - Jon P. Wallenkamp

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Root Engineering Services, P.C.

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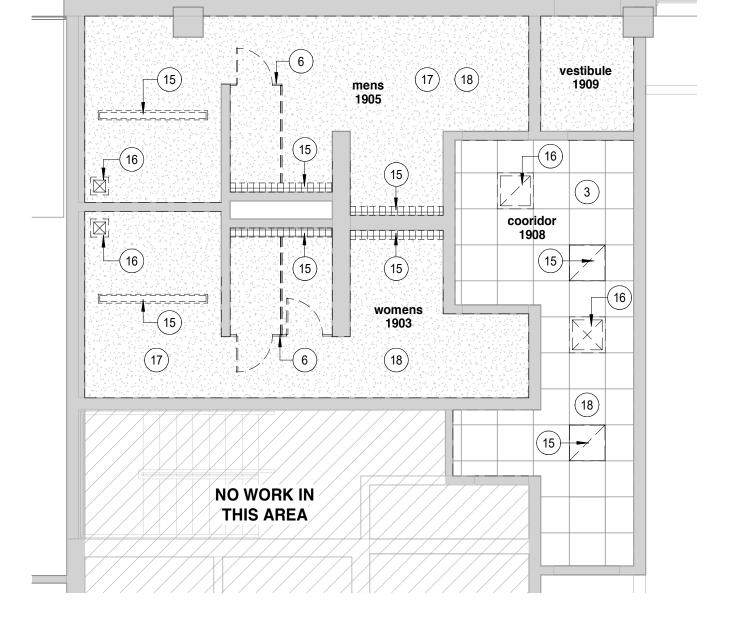
Engineer of Record - Richard Root

REVISIONS


KEY PLAN

REV. / DESCRIPTION


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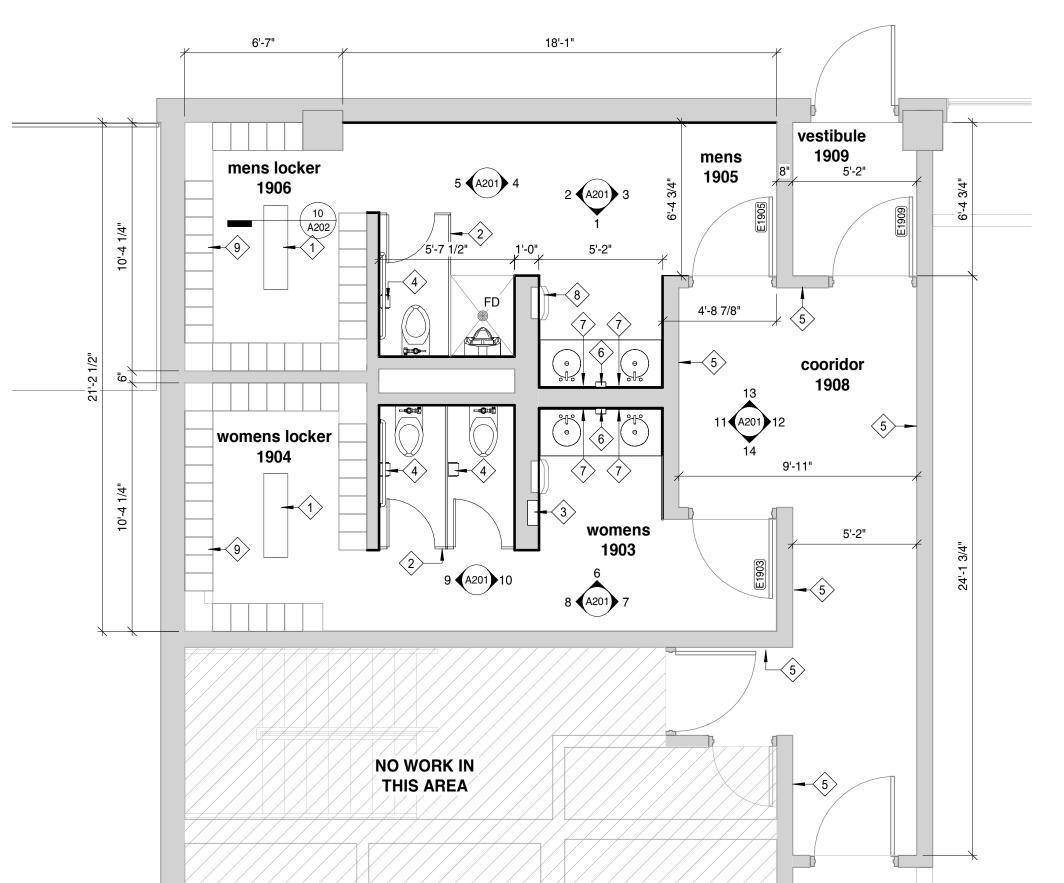



5 Ceiling Plan - Proposed

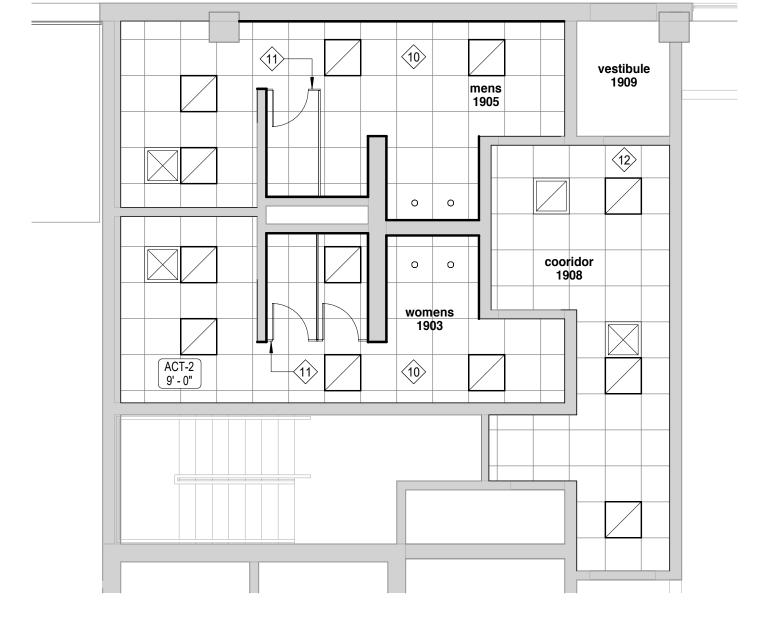

1 Existing and Demo Plan



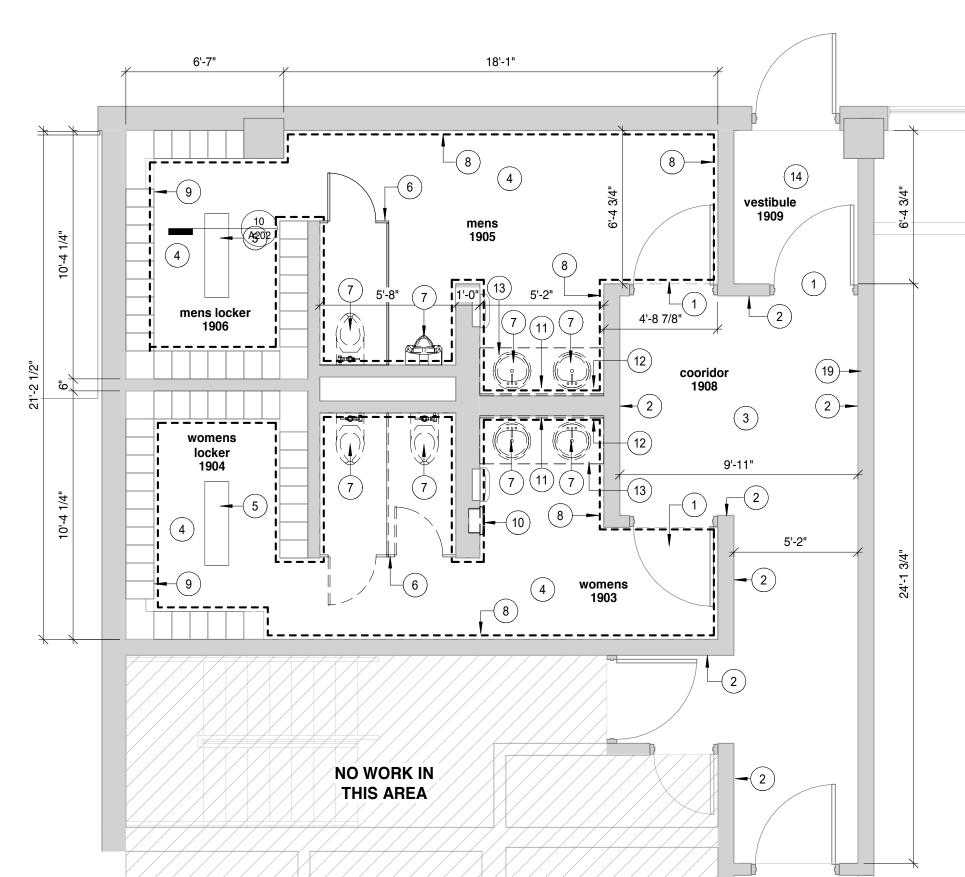

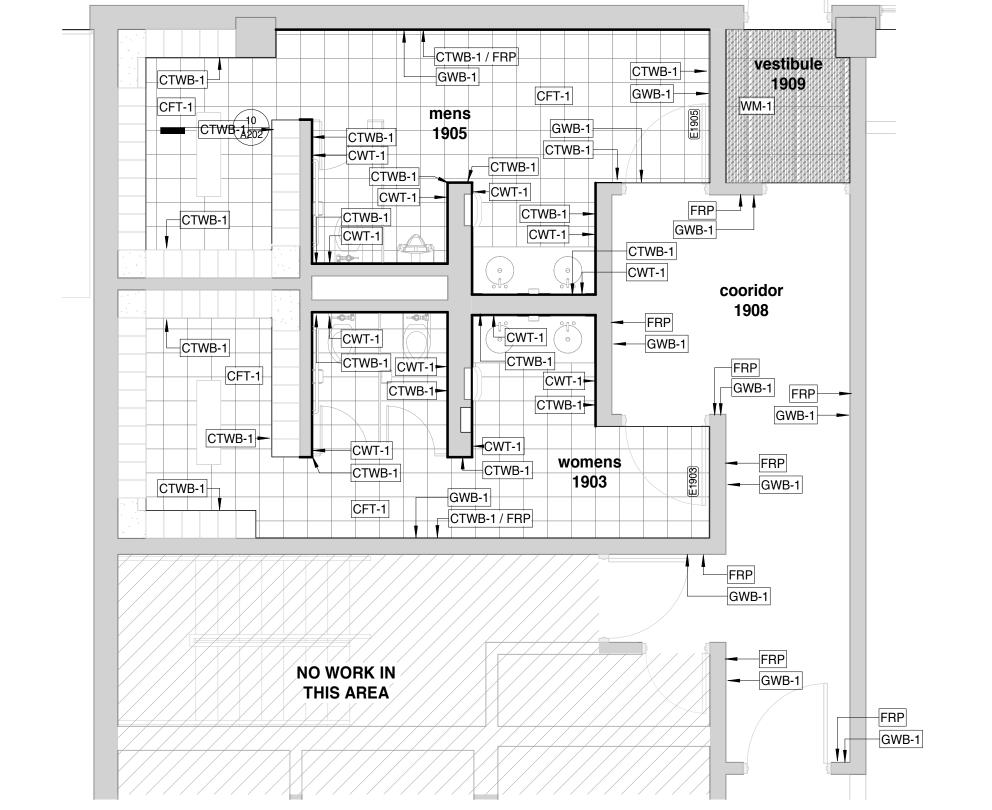




A200

Bid Set Drawings

SHEE

Floor Plans

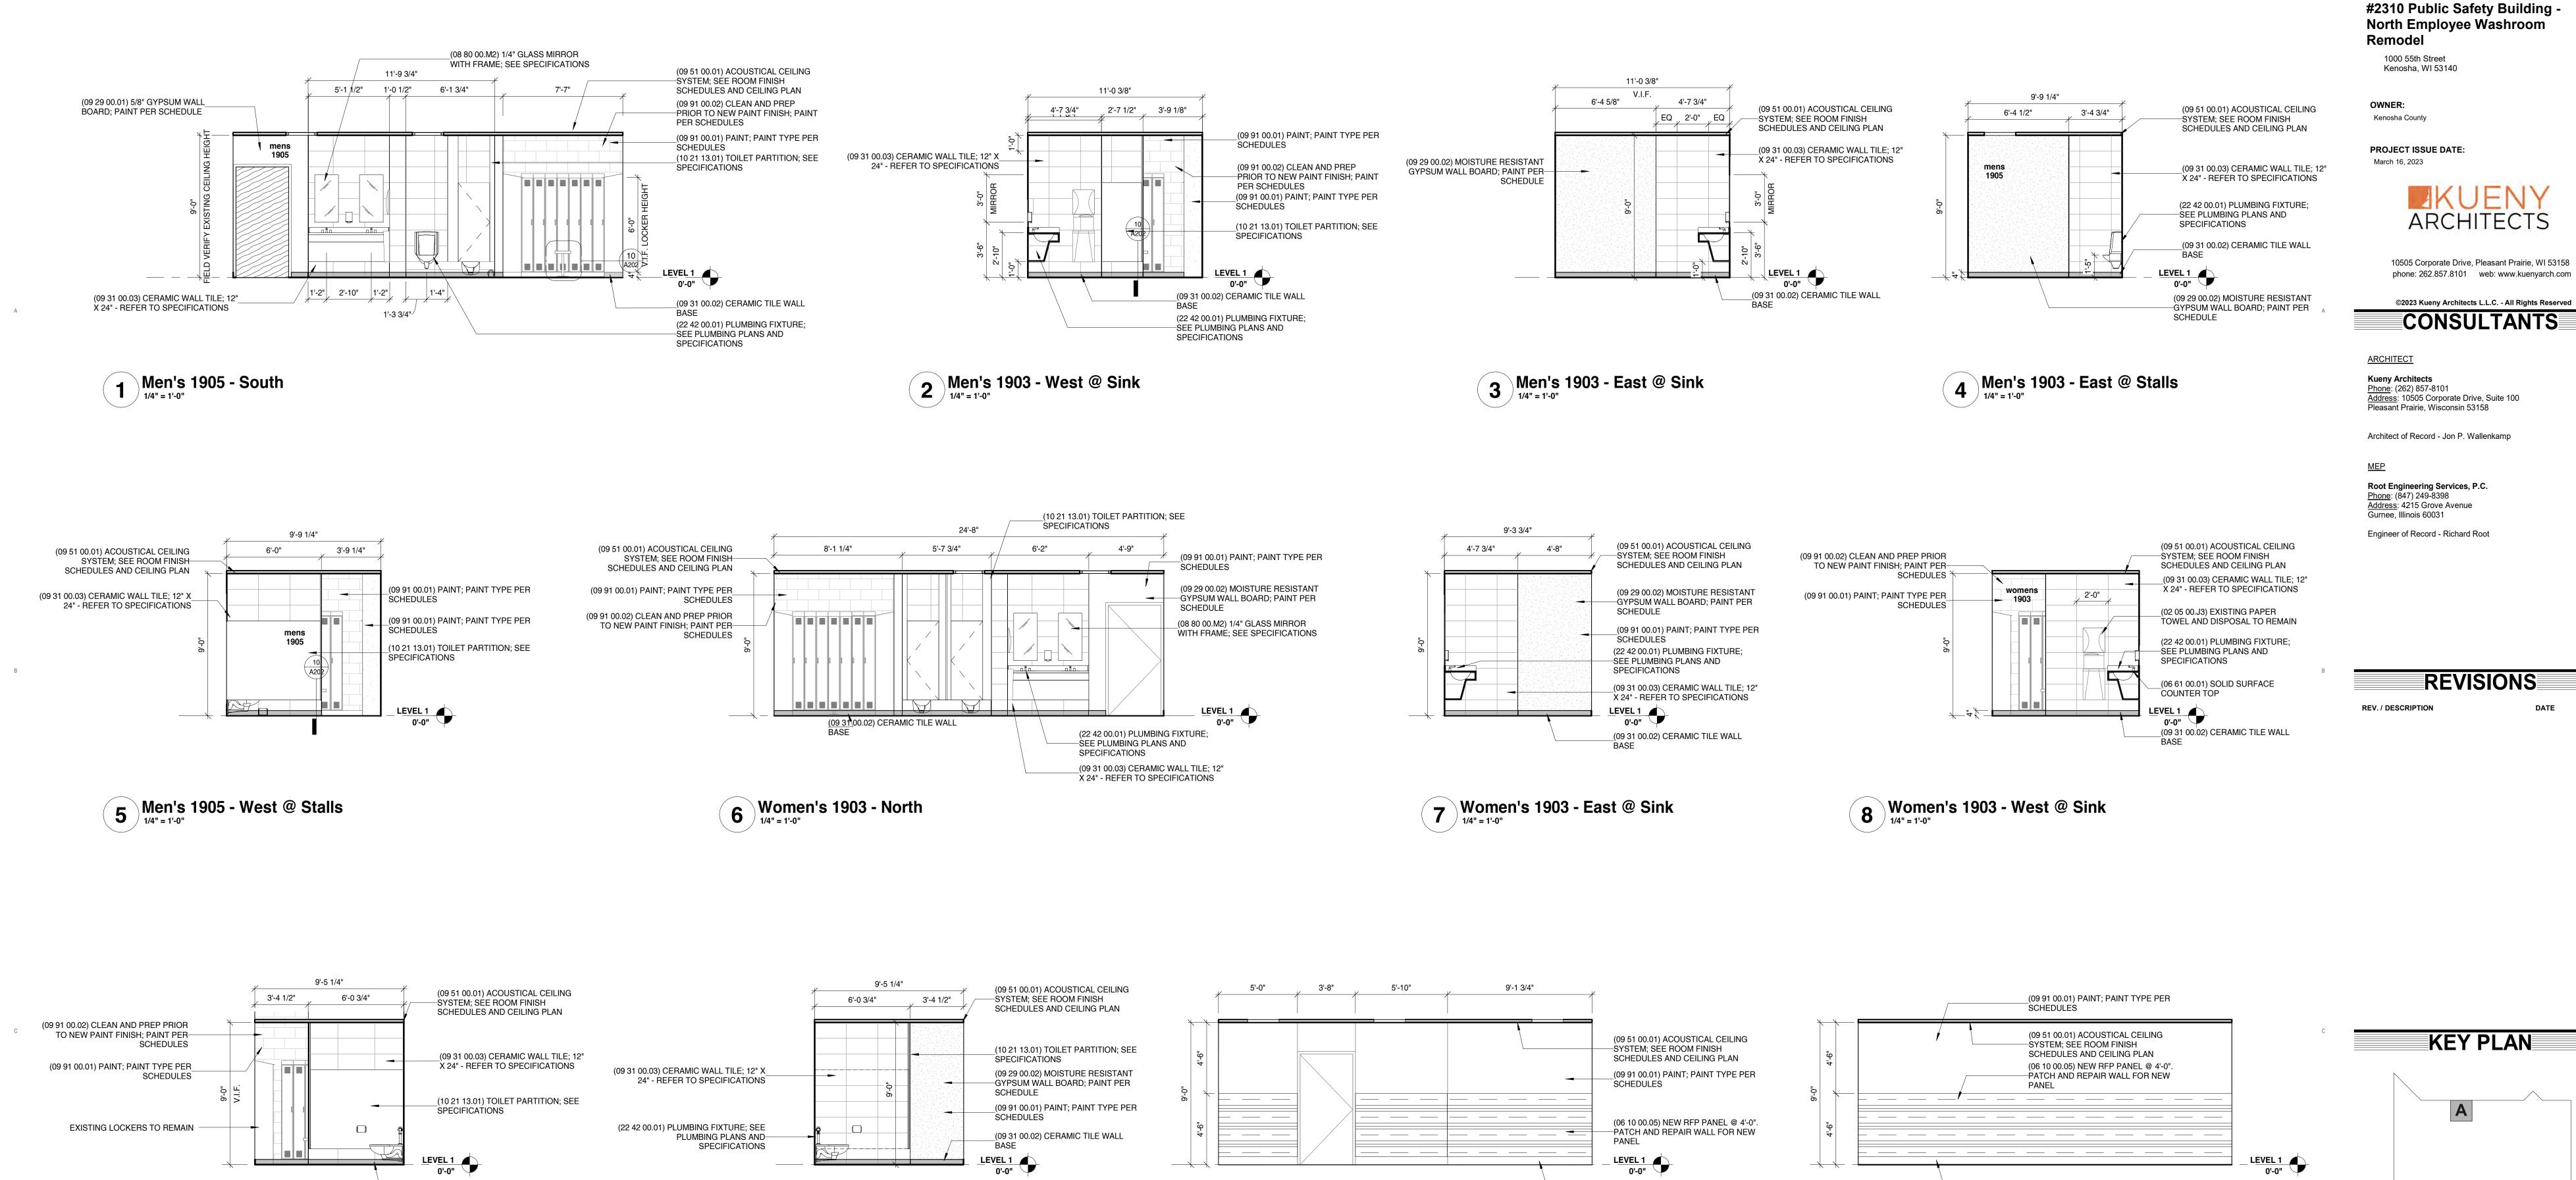

11 Cooridor 1908 - West

_(09 31 00.02) CERAMIC TILE WALL

(09 51 00) ACOUSTICAL CEILING

(08 11 00) NEW HOLLOW METAL

(08 41 13) NEW ALUMINUM DOOR

(09 91 00) PAINT EXISTING DOOR

(06 10 00) NEW FRP PANEL (4'-0")

EXISTING COVE BASE TO

AND FRAME; FIELD VERIFY

EXISTING OPENING

DOOR; EXISTING FRAME TO

TILE SYSTEM

REMAIN

9 Women's 1903 - West @ Stalls

13 Cooridor 1908 - North

10 Women's 1903 - East @ Stalls

(09 51 00) ACOUSTICAL CEILING

(08 11 00) NEW HOLLOW METAL

DOOR; EXISTING FRAME TO

EXISTING DOOR TO REMAIN

(09 91 00) PAINT EXISTING DOOR

(06 10 00) NEW FRP PANEL (4'-0")

EXISTING COVE BASE TO REMAIN

TILE SYSTEM

REMAIN

FRAME

14 Cooridor 1908 - South

KEY PLAN

REVISIONS

PROJECT

PROJECT:

SCALE: 1/4" = 1'-0"

SHEE

SHEET TITLE:


EXISTING COVE BASE TO REMAIN


12 Cooridor 1908 - East

EXISTING COVE BASE TO REMAIN


Interior Elevations

A201

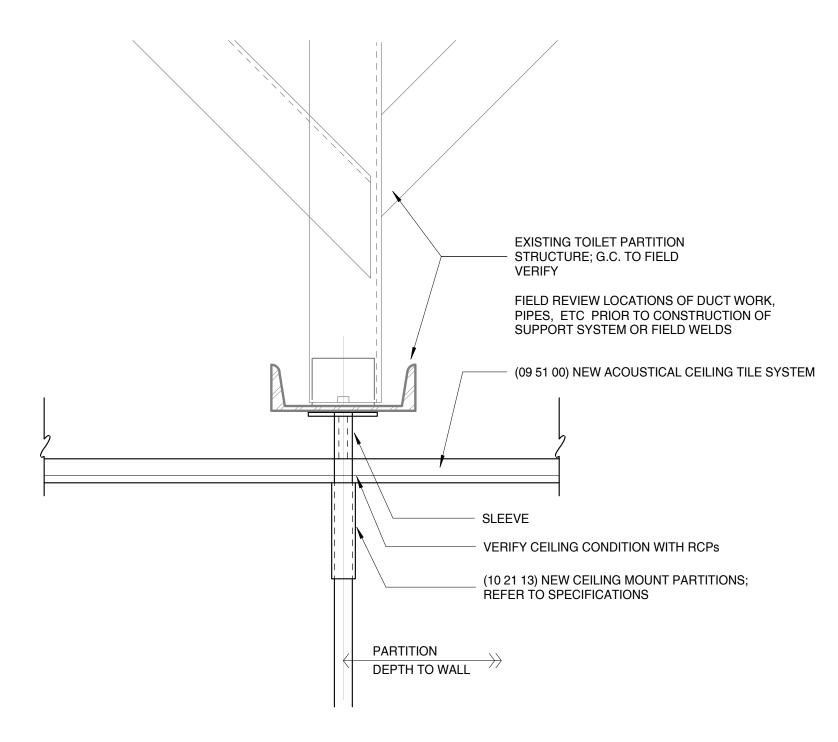


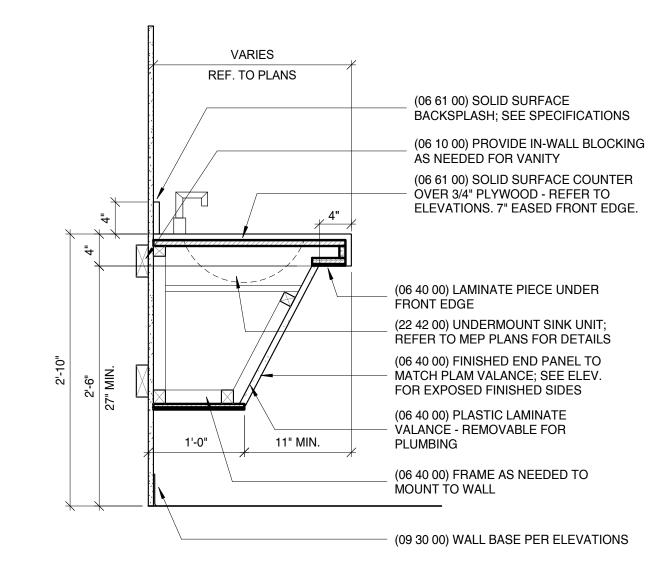


5 Wall Mount Sink Vanity - Typical

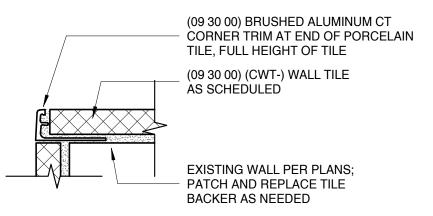


2 Wall Tile - Corner Trim Detail

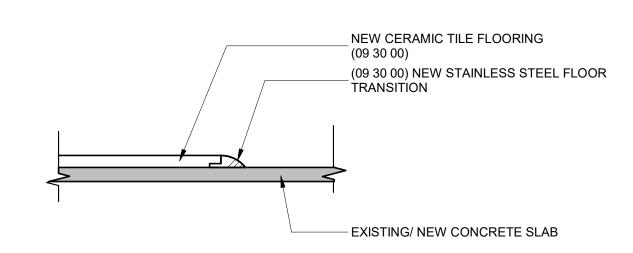



6 Base Transition at Existing Concrete

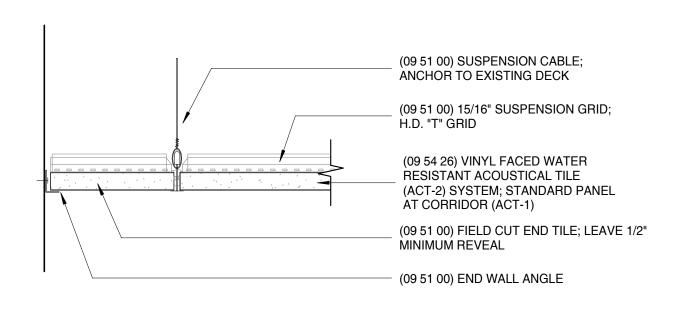


9 Acoustcial Tile Detail

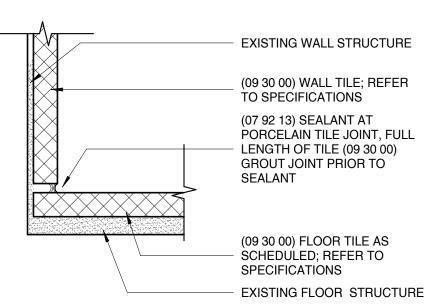


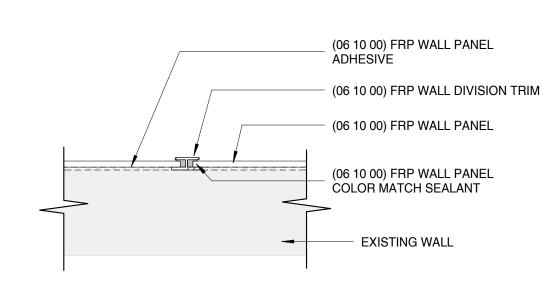


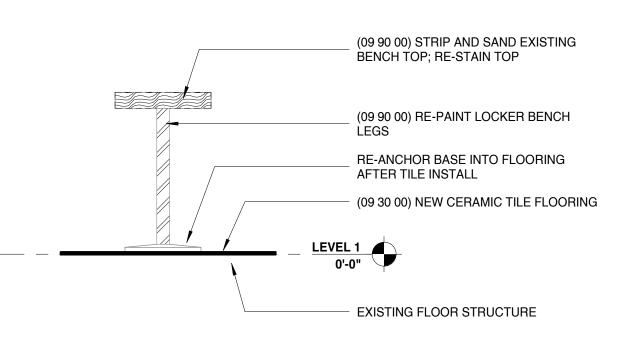


10 Wood Locker Bench

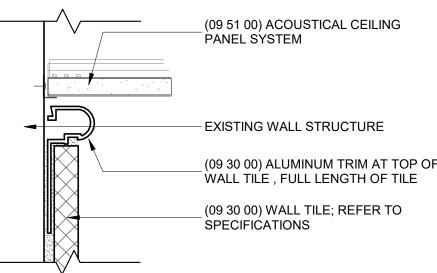

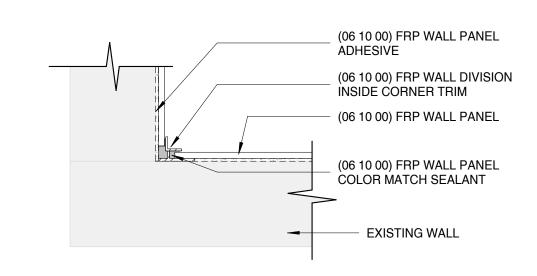

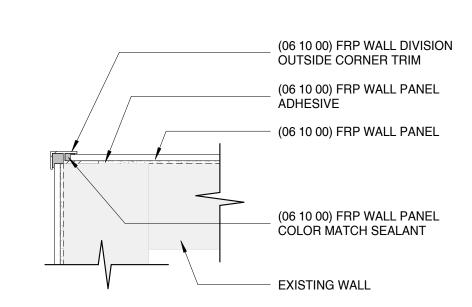

11 FRP Panel - Outside Joint Detail

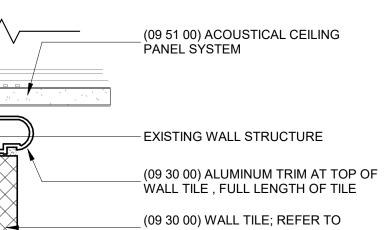

ARCHITECTS

10505 Corporate Drive, Pleasant Prairie, WI 53158

PROJECT

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<u>ARCHITECT</u>

PROJECT:

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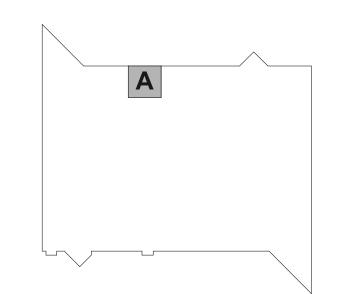
Gurnee, Illinois 60031

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REV. / DESCRIPTION

KEY PLAN



SCALE: As indicated


SHEET

SHEET TITLE:

Interior Elevations and Details

A202

Bid Set Drawings

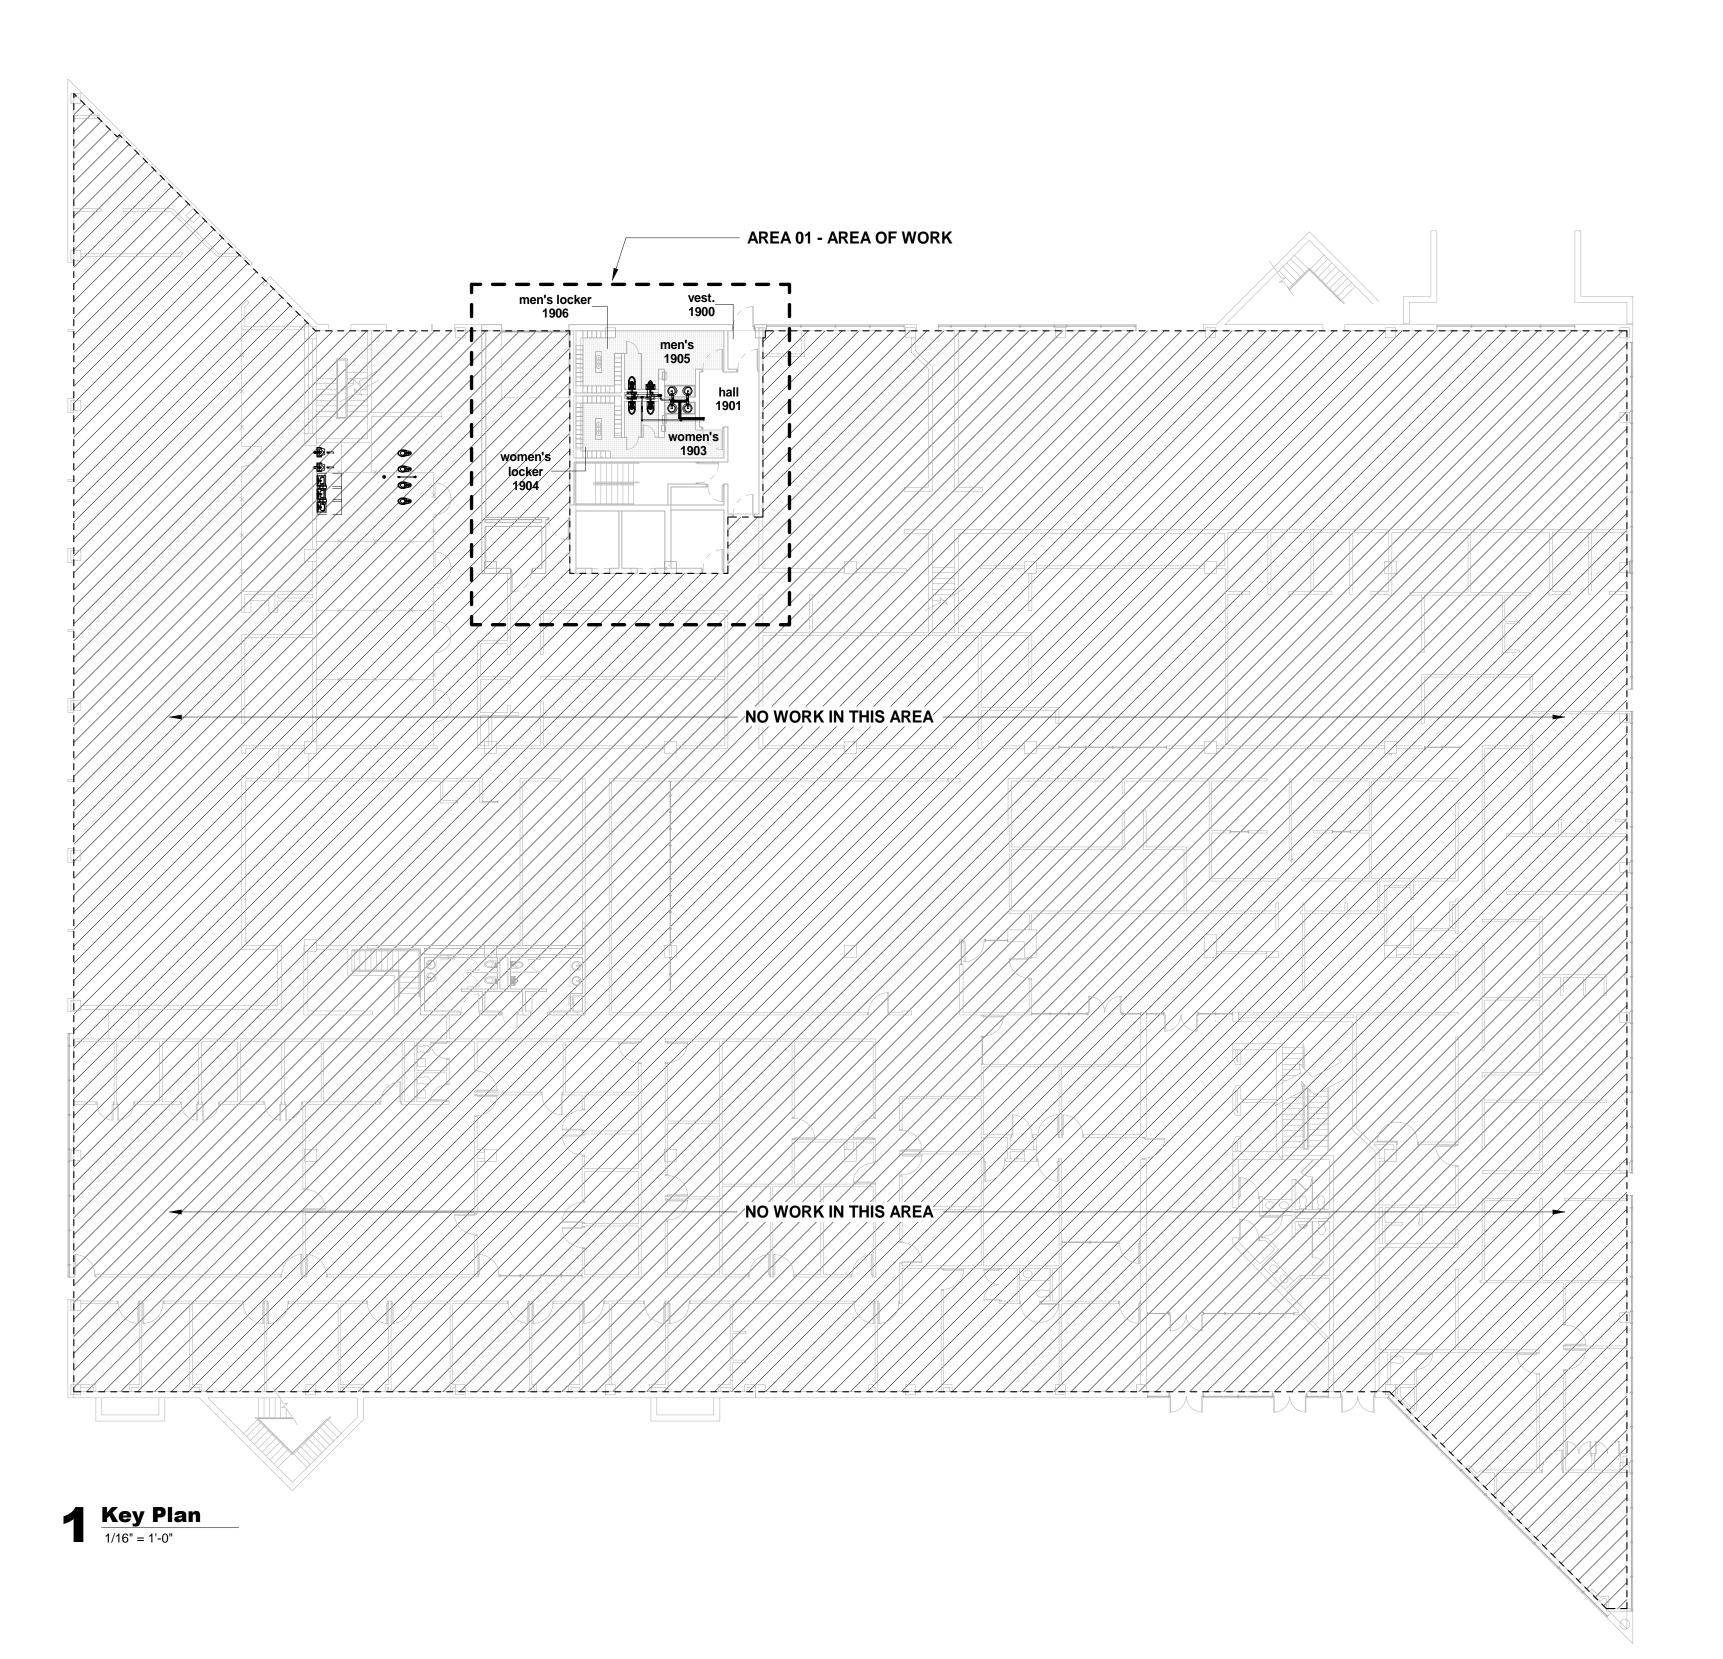

GENERAL PLUMBING NOTES (COPPER)

- 1. THE PLUMBING SUBCONTRACTOR SHALL PROVIDE A COMPLETE AND USABLE SYSTEM WITH THE INTENT AND SPRIT OF THAT INDICATED BY THESE DRAWINGS. WORK OR MATERIALS NOT SHOWN BY THE DRAWINGS, BUT NECESSARY TO COMPLETE THE SYSTEM, SHALL BE INCLUDED AT NO ADDITIONAL COST. THE PLUMBING SUBCONTRACTOR SHALL FURNISH AND INSTALL ALL PLUMBING SYSTEM REQUIREMENTS INCLUDING FIXTURES, WASTE, VENT, GAS AND WATER PIPE, ACCESSORIES, CUTTING AND PATCHING, ETC.
- 3. THE PLUMBING SUBCONTRACTOR SHALL VERIFY PLACEMENT OF ALL FIXTURES, EXISTING PIPE, MECHANICAL EQUIPMENT, AND RELATED WITH ARCHITECTURAL, MECHANICAL AND
- MINOR VARIATION IN PIPING TO AVOID CONFLICT WILL BE ACCEPTED. NOTIFY THE ENGINEER IN WRITING OF SIGNIFICANT CONSTRUCTABILITY ISSUES.
- 5. IF DEMOLITION OF EXISTING BUILDING COMPONENTS WHICH ARE TO REMAIN IS REQUIRED, COORDINATE RESTORATION OF DISTURBED FINISH WORK (E.G. FLOOR SLAB, FLOOR
- 6. LOCATIONS OF EXISTING PIPE INDICATED ON THIS DRAWING ARE BASED ON RECORDS WHICH MAY BE INACCURATE. THE PLUMBING SUBCONTRACTOR SHALL FIELD VERIFY ADJUST IF REQUIRED. AT NO ADDITIONAL COST.
- 8. ALL MATERIALS WILL BE NEW AND IN NEW CONDITION.
- CONTAIN DETAILED DATA ON PLUMBING FIXTURES, VALVES, DEVICES AND ACCESSORIES. EQUAL EQUIPMENT TO THAT SPECIFIED WILL BE CONSIDERED IF PERFORMANCE, APPEARANCE, SERVICEABILITY AND QUALITY ARE JUDGED BY THE ENGINEER AND/OR ARCHITECT TO BE EQUAL OR BETTER.
- 10. ALL WORK SHALL COMPLY WITH COGNIZANT CODES, REGULATIONS, LAWS AND THE DETERMINATIONS OF THE LOCAL BUILDING OFFICIAL AT NO EXTRA COST. THE CONTRACTOR SHALL INFORM THE ENGINEER IN WRITING OF ANY CONFLICT BETWEEN THE PLANS AND APPLICABLE CODES.
- 11. WHEN SYSTEMS ARE COMPLETE AND OPERATIONAL, A 'PUNCH LIST' INSPECTION SHALL BE REQUESTED BY THE CONTRACTOR. SUCH AN INSPECTION SHALL NOT BE CONDUCTED ON INCOMPLETE OR NON-OPERATIONAL SYSTEMS.
- 12. UPON COMPLETION OF WORK, SUBMIT FOUR COPIES OF OPERATION AND MAINTENANCE MANUALS, AS BUILT DRAWINGS, GUARANTIES AND WARRANTIES. AT MINIMUM, THE
- 13. SUPPORT ALL PIPE PER CODE WITH CLEVIS HANGERS, UNISTRUT OR SIMILAR. PLUMBERS TAPE WILL NOT BE ACCEPTED. CLEVISES FOR WATER PIPE SHALL BE COPPER.
- 14. INSULATE ALL WATER PIPE WITH FIBERGLASS PREFORMED PIPE INSULATION AND ALL PURPOSE JACKET. 1"THICK 4 PCF FOR 1/2" 1-3/4" PIPE SIZE, 1-1/2" THICK FOR 1-1/2" AND LARGER PIPE. KNAUF OR EQUAL.
- 16 ABOVE FLOOR PLUMBING MATERIALS:
- WASTE/VENT PIPE SHALL BE OF MATERIAL LISTED IN TABLE BELOW.
- WATER PIPE SHALL BE OF MATERIAL LISTED IN TABLE BELOW.
- WASTE/VENT PIPE SHALL BE OF MATERIAL LISTED IN TABLE BELOW WITH BELL AND SPIGOT PLACED IN A CLEAN SAND BED.

- 21 NO WATER PIPES TO BE INSTALLED IN ATTIC OR OTHER UNCONDITIONED SPACES.

- 2. THE CONTRACTOR SHALL VERIFY ALL EXISTING CONDITIONS AND MAKE ADJUSTMENTS TO AVOID CONFLICT. NOTIFY THE ENGINEER IN WRITING OF SIGNIFICANT CONSTRUCTABILITY
- ELECTRICAL DRAWINGS AND TRADES BEFORE ROUGHING IN.
- FINISHES, ETC.) WITH GC.
- FIELD VERIFY EXISTING WASTE PIPE INVERTS AND ADEQUACY OF NEW WASTE PIPE FALL. NOTIFY ENGINEER IN WRITING IF CONFLICTS EXIST.
- 9. THE PLUMBING SUBCONTRACTOR SHALL PREPARE A SUBMITTAL PACKAGE WHICH DETAILS PROPOSED EQUIPMENT (FIVE COPIES). AT MINIMUM THE SUBMITTAL PACKAGE WILL
- CONTRACTOR WILL WARRANTY ALL WORK, EQUIPMENT AND MATERIALS FOR ONE YEAR PAST BENEFICIAL OCCUPANCY OR SUBSTANTIAL COMPLETION.
- 15. ALL WATER VALVES SHALL BE 2-PIECE BALL VALVES, BRONZE BODY, SS BALL. GAS VALVES SHALL BE STEEL COCKS, RATED FOR GAS SERVICE. STOCKHAM OR EQUAL. INSTALL A UNION WITH EACH VALVE.
- WATER PIPE SHALL BE OF MATERIAL LISTED IN TABLE BELOW.
- 17 BELOW GROUND PLUMBING MATERIALS:
- MINIMUM UNDERGROUND BUILDING DRAIN SIZE IS TO BE 4".
- 18 MINIMUM BUILDING SEWER SIZE IS TO BE 6".
- 19 COLORED PRIMER AND COLORED GLUE SHALL BE USED ON ALL PVC PIPING OR A STACK TEST SHALL BE PERFORMED
- 20 NO PVC WASTE OR VENT PIPING MAY BE INSTALLED IN A PLENUM CEILING.

PLUMBING FIXTURE SCHEDULE

- ADA ADULT WC: STANDARD CONSUMPTION FLOOR MOUNT, TOP SPUD, ELONGATED BOWL, FLUSH VALVE WATER CLOSET. AMERICAN STANDARD "MADERA" 3461.001. INCLUDE BATTERY POWERED SLOAN 115 SMO FLUSH VALVE, 1.28 GPF. BEMIS SOLID PLASTIC ANTIBACTERIAL OPEN FRONT SEAT. TOP OF SEAT 18" AFF.
- ADULT WC: SAME AS P-1A, EXCEPT MOUNT SEAT AT 15"AFF
- ADA ADULT URINAL: AMERICAN STANDARD "WASHBROOK" 6590.001 WALL MOUNTED. VITREOUS CHINA, 3/4" INLET TOP SPUD URINAL. FURNISH AND INSTALL WITH BATTERY POWERED SLOAN 186 SMO SENSOR FLUSH VALVE 0.5 GPF. INCLUDE URINAL CARRIER JR SMITH MODEL #0609 OR EQUAL. TOP OF FRONT RIM TO BE 15 1/4" AFF.
- ADULT URINAL: SAME AS P-2a, EXCEPT MOUNT TOP OF FRONT RIM AT 24" AFF
- ADA LAVATORY: KOHLER VISTREOUS CHINA UNDERMOUNT ADA LAVATORY MODEL K-2882 "VERTICYL" 17.25x13" WITH SLOAN OPTIMA BATTERY SENSOR ACTIVATED FAUCET SF-2150 CENTERSET WATER SENSE LISTED. INCLUDE JR SMITH CARRIER. 1-1/4" H.C. STYLE TAILPIECE WITH GRID STRAINER. 17 GA C.P. P-TRAP. TWO 1/2" ANGLE SUPPLIES/STOPS. TRUBRO HC INSULATION. TOP OF RIM 33" AFF. INCLUDE UNDER SINK ASSE TEMPER VLV, WATTS USG-B OR EQ, SET AT 110F
- FLOOR DRAIN: JR SMITH M/N 2010A. SQUARE NI-BR TOP. 4" TRAP. INCLUDE TRAP GUARD.
- FLOOR DRAIN: JR SMITH M/N 2010A. SQUARE NI-BR TOP. 3" TRAP. INCLUDE TRAP GUARD.

3 Plumbing Fixture Schedule

PROJECT

Kenosha Courthouse Restroom

912 56th St, Kenohsa, WI 53140

Renovation

PROJECT ISSUE DATE:



10505 Corporate Drive, Pleasant Prairie, WI 53158 phone: 262.857.8101 web: www.kuenyarch.com

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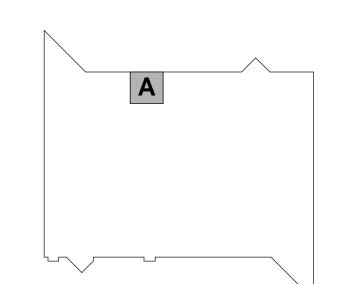
Pleasant Prairie, Wisconsin 53158

Architect of Record - Jon P. Wallenkamp

Root Engineering Services, P.C. Phone: (847) 249-8398 Address: 4215 Grove Avenue Gurnee, Illinois 60031

Engineer of Record - Richard Root


REVISIONS






Overall Plumbing Plan

P100

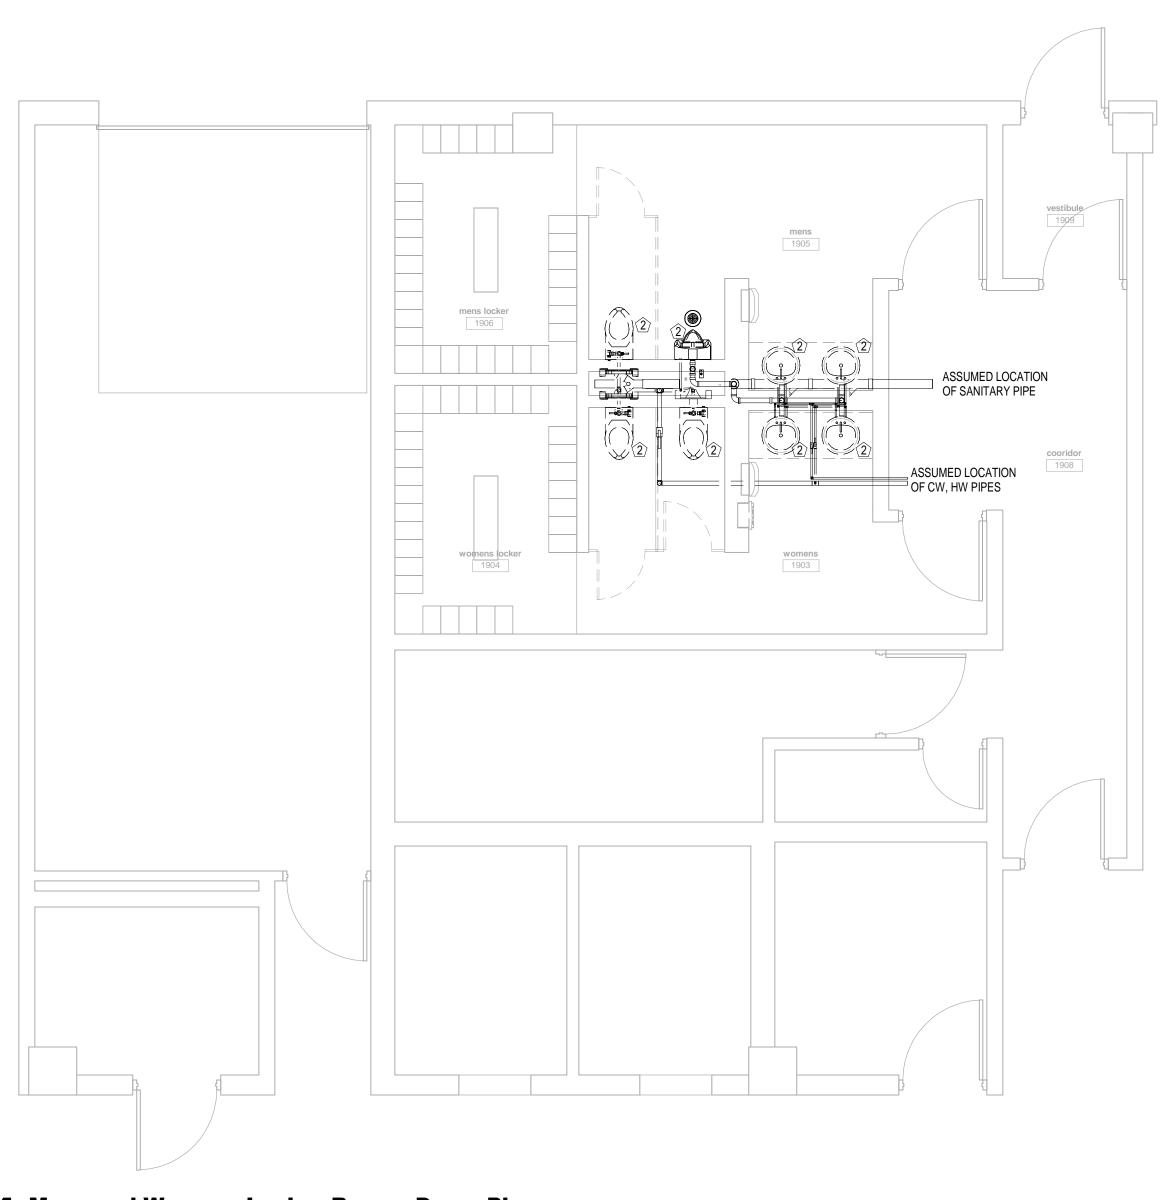


Mens and Womens Locker Rooms Demo Plan

1/4" = 1'-0"

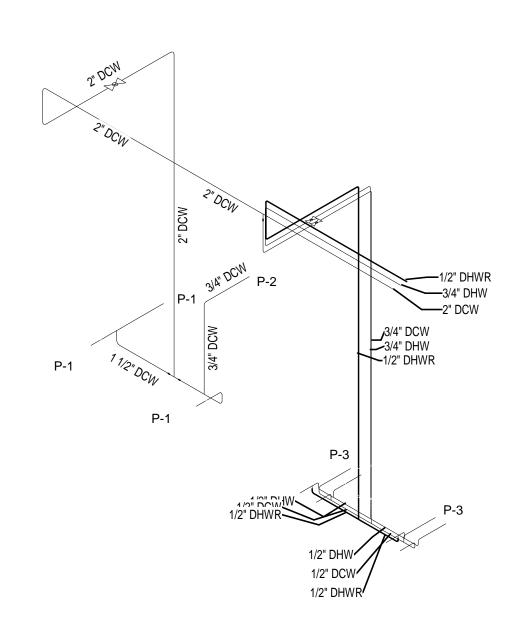


3 Locker Room Restroom - Water Riser

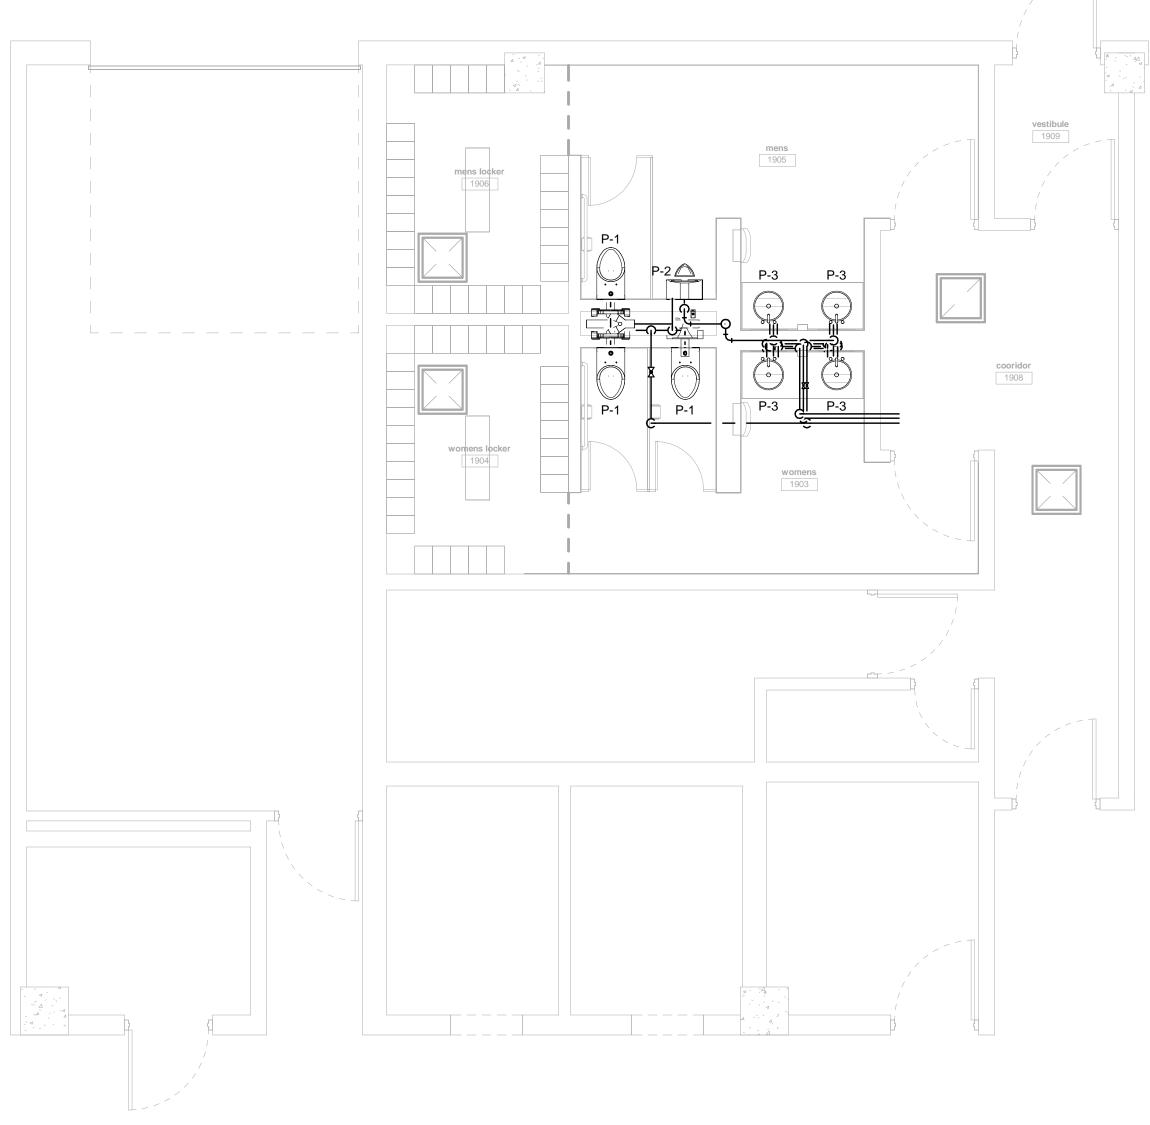

2 Mens and Womens Locker Rooms Plumbing Plan

1/4" = 1'-0"

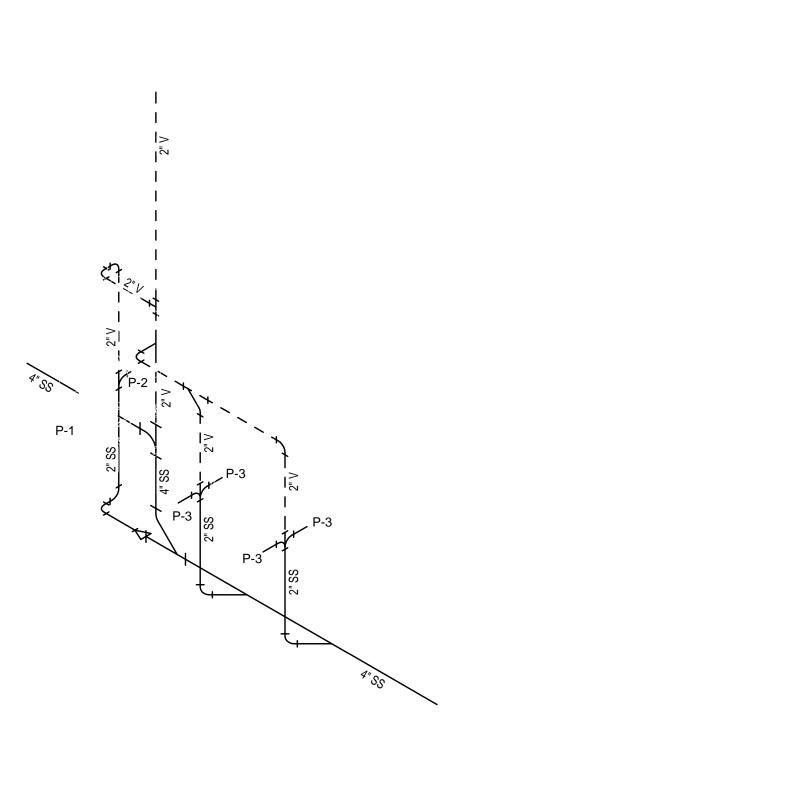

Locker Room Restoom - Waste & Vent Riser

- PLUMBING KEY NOTES
- 1 DEMO EXISTING PLUMBING FIXTURE. EXISTING ROUGH-IN TO REMAIN
 2 DEMO EXISTING PLUMBING FIXTURE. PC TO REWORK EXISTING SANITARY, CW, HW ROUGH-IN (AS NECESSARY) FOR NEW FIXTURE CONNECTIONS
 3 EXISTING FIXTURE TO REMAIN. NOT IN SCOPE
 4 DEMOLISH FIXTURE COMPLETE. DEMOLISH EXSITING ROUGH-IN PIPE CONNECTIONS BACK TO NEAREST ACTIVE BRANCH CONNECT NEW FIXTURE TO EXISTING ROUGH-IN

- PC TO COORDINATE WITH GC FOR REMOVAL AND REPLACEMENT OF ALL WALL, FLOOR, AND OTHER FINISHES INVOLVED WITH THE DEMOLISION OR REPLACEMENT OF PLUMBING FIXTURES, PARTS, AND ACCESSORIES
 PC SHALL BE RESPONSIBLE FOR ALL SAW CUTTING OF FLOORS AND REPLACEMENT OF NEW FLOORING. COORDINATE WITH GC AND ARCHITECT
- EXISTING PIPES SHOWN ON PLAN ARE ASSUMPTIONS BASED ON BEST AVAILABLE PLANS. PC SHALL FIELD VERIFY ALL SIZES AND LOCATIONS. ANY DISCREPANCIES SHALL BE REPORTED TO ARCH AND ENGINEER
 NEW URINALS TO BE WALL MOUNT STYLE. PC SHALL BE RESPONSIBLE FOR INSTALLING NEW CHAIR CARRIER IN
- EXISTING WALL. PC SHALL PROVIDE NEW VENTING IF EXISTING VENTING IS NOT REUSABLE. PC SHALL BE RESPONSIBLE
- FOR DEMOLITION AND REPLACEMENT OF ALL WALL, FLOOR, AND CEILING FINISHES. COORDINATE WITH GC & ARCH

 5. PC TO ADJUST HEIGHT OF CW CONNECTIONS IN ALL CHASE WALLS FOR NEW FLUSHOMETERS. PC SHALL BE
 RESPONSIBLE FOR ANY DEMOLITION AND REPLACEMENT OF WALL FINISHES.

 6. IT IS ASSUMED THERE IS A DETURN PIPE IN THE EXISTING BUILDING. PC TO FIELD VERIFY PRESENCE AND
- LOCATION OF HOT WATER RETURN SYSTEM 7. PC SHALL BE RESPONSIBLE FOR REPLACING ALL CHAIR CARRIERS FOR WALL MOUNT WATER CLOSETS AND URINALS

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PROJECT

Kenosha Courthouse Restroom

912 56th St, Kenohsa, WI 53140

<u>ARCHITECT</u>

PROJECT:

OWNER:

03-16-2023

PROJECT ISSUE DATE:

Renovation

Kueny Architects
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Address: 10505 Corporate Drive, Suite 100
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Architect of Record - Jon P. Wallenkamp




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Engineer of Record - Richard Root

REVISIONS

REV. / DESCRIPTION

KEY PLAN




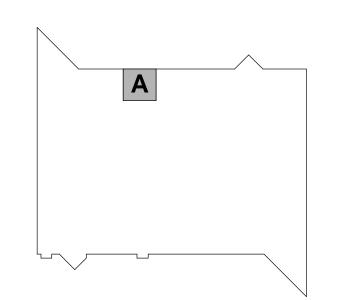

SHEET


SHEET TITLE:

Enlarged Plumbing Views

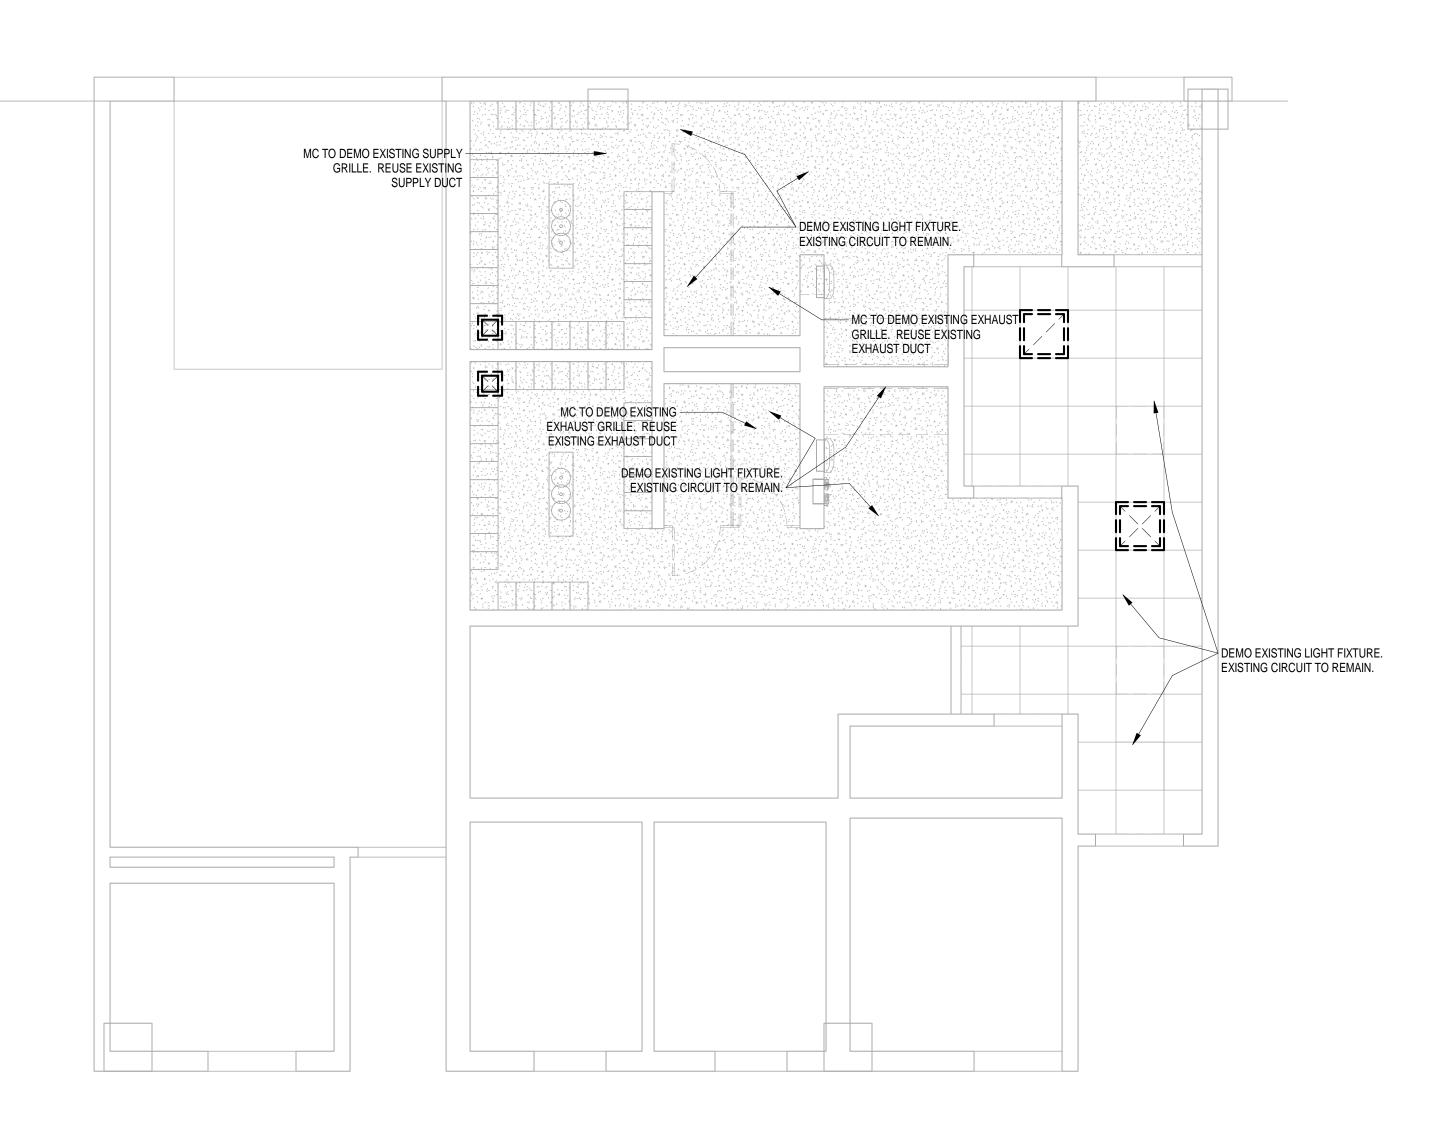


Upper Level Mech & Elec Demo Plan

1/4" = 1'-0"

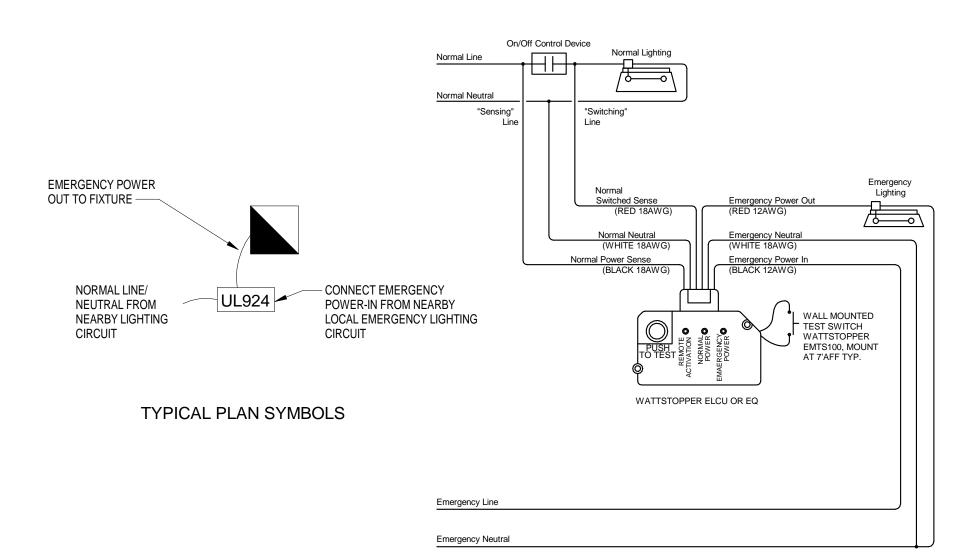

3 EM WIRING SCHEMATIC FOR EMERGENCY FIXTURES

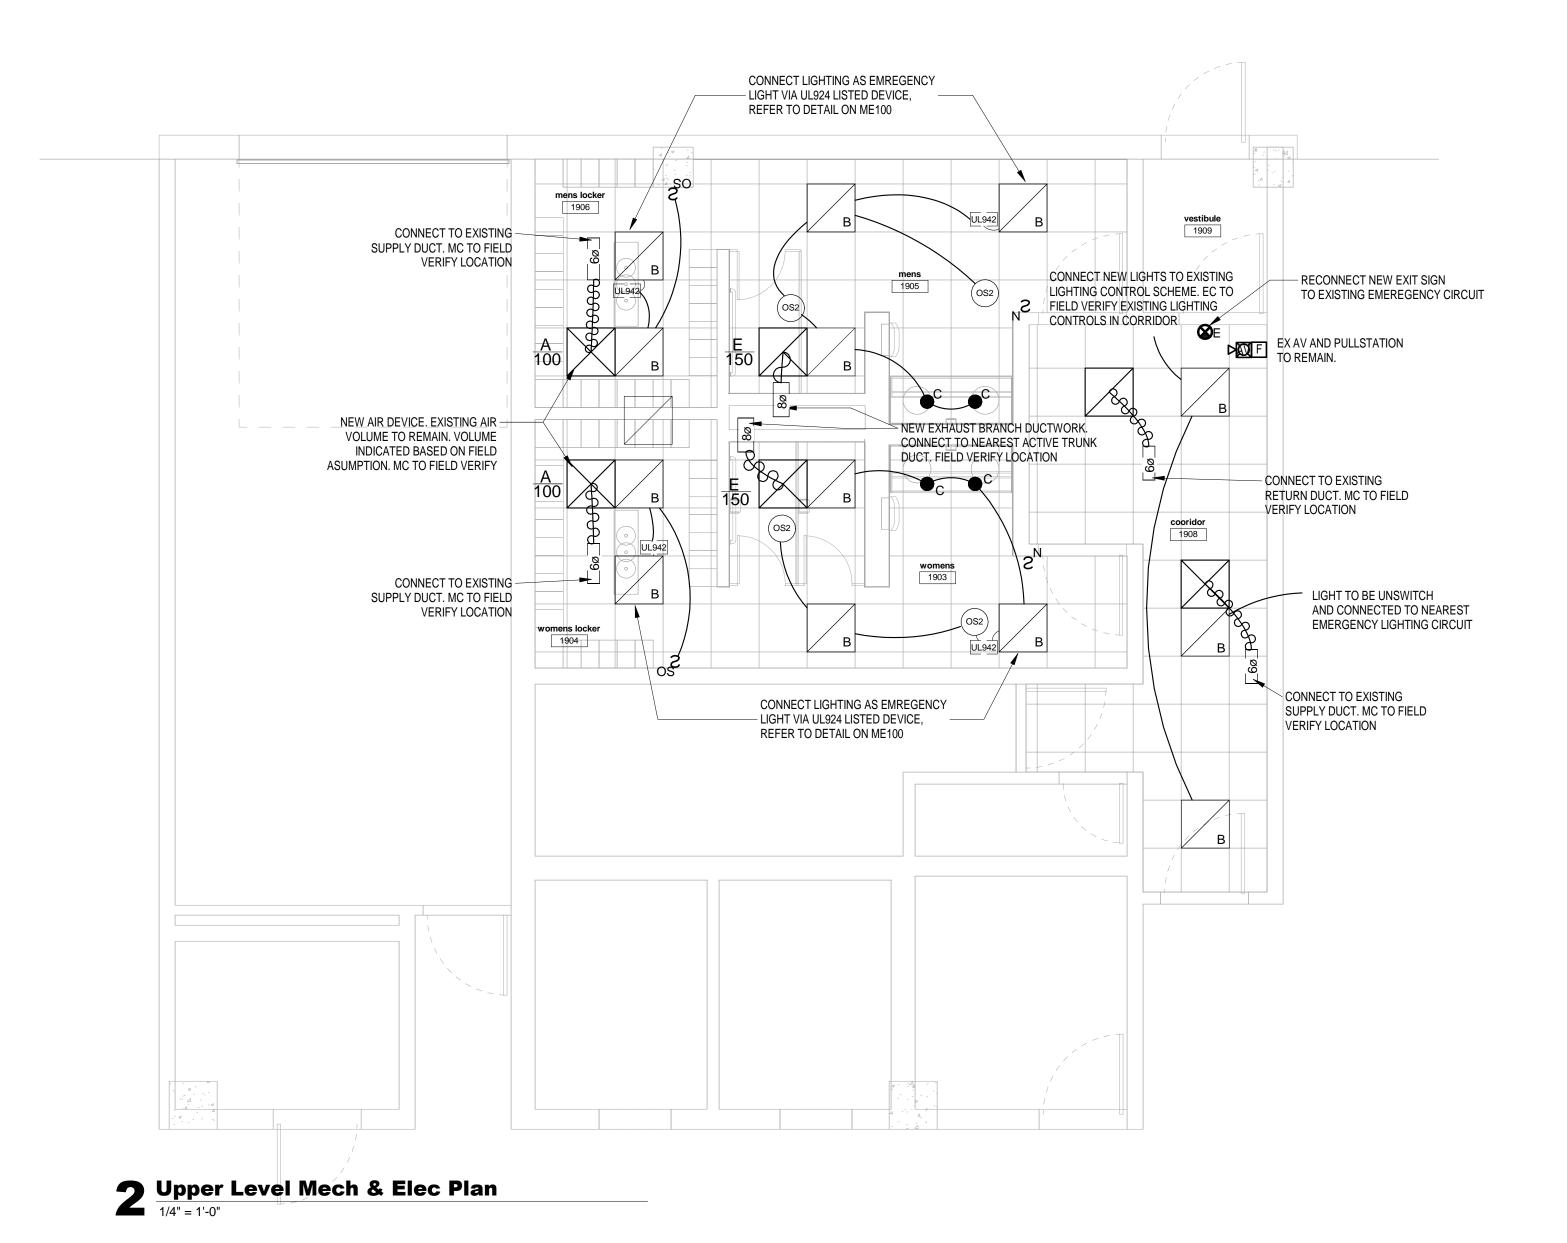

GENERAL MECHANICAL AND ELECTRICAL NOTES

MC TO FIELD VERIFY EACH AIR DEVICE DESIGNATION (SUPPLY, EXHAUST, RETURN). REPLACE IN KIND ACCORDING TO AIR DEVICE SCHEDULE

- 2. MC TO REPLACE EXISTING EXHAUST GRILLES AS NOTED ON PLANS. SIZES OF GRILLES TO MATCH EXISTING 3. MC SHALL BE RESPONSIBLE FOR NEW FLEX AND/OR HARD DUCT CONNECTIONS FOR NEW GRILLE LOCATIONS IN NEW CEILING AND EXISTING WALLS.
- 4. EXISTING EXHAUST, RETURN, SUPPLY AIR VOLUMES TO REMAIN. MC TO BE RESPONSIBLE FOR ANY REBALANCING OF SYSTEMS
- 5. EC TO PROVIDE NEW OCCUPANCY SENSORS LIGHT SWITCHES IN ALL RESTROOMS 6. EC SHALL BE RESPONSIBLE FOR DEMOLITION AND REPLACEMENT OF ALL CEILING AND WALL FINISHES.
- COORDINATE WITH GC 7. EC SHALL REUSE EXISTING FIRE ALARM DEVICES. IT SHALL BE THE RESPONSIBILITY OF THE EC TO
- RELOCATE AND REWIRE ANY AND ALL FIRE ALARM DEVICES IMPACTED BY DEMOLITION AND IMPLEMENTATION OF NEW FINISHES. CONNECT NEW FIRE ALARM DEVICES AS INDICATED ON PLANS

PROJECT

PROJECT:

Kenosha Courthouse Restroom Renovation

912 56th St, Kenohsa, WI 53140

OWNER:

PROJECT ISSUE DATE: 03-16-2023



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<u>ARCHITECT</u>


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Gurnee, Illinois 60031 Engineer of Record - Richard Root

REVISIONS

REV. / DESCRIPTION



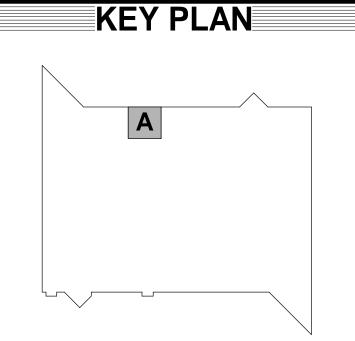

SHEET

SHEET TITLE:

Mechanical and **Electrical Plan**

ME100

GENERAL ELECTRICAL NOTES DESIGN BASED ON 2017 NEC

- ALL PATIENT CARE AREAS AS DEFINED BY NEC SHALL HAVE HOSPITAL GRADE RECEPTACLES. PATIENT CARE AREAS SHALL BE WIRES IN ACCORDANCE WITH WITH NEC SECTION 517, INCLUDING BUT NOT LIMITED TO REDUNDANT GROUNDING (517.13).
- THE ELECTRICAL SUBCONTRACTOR SHALL PROVIDE A COMPLETE AND USABLE SYSTEM WITHIN THE INTENT AND SPIRIT OF THAT INDICATED BY THESE DRAWINGS. WORK OR MATERIALS NOT SHOWN BY THE DRAWINGS, BUT NECESSARY TO COMPLETE THE SYSTEM SHALL BE INCLUDED AT NO ADDITIONAL COST. THE ELECTRICAL SUBCONTRACTOR SHALL FURNISH AND INSTALL ALL ELECTRICAL SYSTEM REQUIREMENTS INCLUDING FIRE ALARM DEVICES, SWITCHES, RACEWAY, DEVICES, CONDUCTOR, SPECIALTIES, CUTTING AND PATCHING, ETC.
- THE CONTRACTOR SHALL VERIFY ALL EXISTING CONDITIONS. MAKE ADJUSTMENTS TO AVOID CONFLICT. NOTIFY THE ENGINEER IN WRITING OF SIGNIFICANT CONSTRUCTABILITY ISSUES.
- TELEPHONE/DATA OUTLETS, UNLESS NOTED, SHALL BE CIRCUITED BY OTHERS. THE ELECTRICAL CONTRACTOR SHALL PROVIDE A CONDUIT TO AN ACCESSIBLE SPACE.
- 4. THE ELECTRICAL SUBCONTRACTOR SHALL VERIFY PLACEMENT OF ALL RECEPTACLES, WIRING DEVICES, SWITCHES, AND DISCONNECTS WITH
- ARCHITECTURAL, MECHANICAL AND PLUMBING DRAWINGS AND TRADES BEFORE ROUGHING IN. WIRING MEANS AND METHODS SHALL BE THE RESPONSIBILITY OF THE ELECTRICAL SUBCONTRACTOR. THE ELECTRICAL SUBCONTRACTOR SHALL
- VERIFY CEILING TYPE WITH FIXTURE SELECTION BEFORE ORDERING.
- 6. PANEL BOARDS SHALL BE SQUARE D NQOD OR EQUAL FROM CUTLER HAMMER, OR GE. BREAKERS SHALL BE BOLT-IN TYPE QOB OR EQUAL. 10kaic MINIMUM.
- CONDUCTOR SHALL BE THW, THWN, OR THHN. CONDUIT SHALL BE GALV. EMT, IMC OR RIGID.
- 8. POWER RECEPS, WALL SWITCHES, COVER PLATES, ETC. SHALL BE COMMERCIAL GRADE 20 RATED MATCHING THE STYLE AND APPEARANCE OF THE EXISTING DEVICES.
- 9. | EQUIPMENT SIZES ARE AS DESIGNED. CIRCUIT BREAKERS, CONDUIT, JUNCTION BOXES, DISC. SWITCHES, CONDUCTOR SIZES, DEVICE LOCATIONS, ETC. SHALL BE ADJUSTED TO THE EQUIPMENT SUBMITTED AND APPROVED FOR INSTALLATION ON THIS PROJECT.
- 10. $\,$ THE ELECT SUBCONTRACTOR SHALL BE RESPONSIBLE FOR COORDINATION BETWEEN THE ELECTRICAL AND MECHANICAL TRADES TO PROVIDE CLEARANCES ABOVE CEILING BETWEEN RECESSED LIGHT FIXTURES AND THERMAL INSULATION OR COMBUSTIBLE MATERIALS IN ACCORD WITH N.E.C.
- PARAGRAPH 410-65 & 66. 11. THE ELECTRICAL SUBCONTRACTOR SHALL PREPARE A SUBMITTAL PACKAGE WHICH DETAILS PROPOSED EQUIPMENT (FIVE COPIES). AT MINIMUM THE
- SUBMITTAL PACKAGE WILL CONTAIN DETAILED DATA ON LIGHTING FIXTURES, PANELBOARDS, AND ACCESSORIES. EQUAL EQUIPMENT TO THAT SPECIFIED WILL BE CONSIDERED IF PERFORMANCE, APPEARANCE, SERVICEABILITY AND QUALITY ARE JUDGED BY THE ENGINEER AND/OR ARCHITECT TO BE EQUAL.
- 12. ALL WORK SHALL COMPLY WITH COGNIZANT CODES, REGULATIONS, LAWS AND THE DETERMINATIONS OF THE LOCAL BUILDING OFFICIAL AT NO EXTRA
- COST. THE CONTRACTOR SHALL INFORM THE ENGINEER IN WRITING OF ANY CONFLICT BETWEEN THE PLANS AND APPLICABLE CODES.
- 13. ALL MATERIALS WILL BE NEW AND IN NEW CONDITION.
- 14. ALL ELECTRICAL CONNECTIONS 120V OR HIGHER SHALL BE THE RESPONSIBILITY OF THE ELECTRICAL SUBCONTRACTOR. MECHANICAL SHALL FURNISH DUCT SMOKE DETECTORS AS REQUIRED TO ELECTRICAL FOR FIRE ALARM INSTALLATION. MECHANICAL SHALL PROVIDE HVAC CONTROL WIRING. ELECTRICAL SHALL COORDINATE EQUIPMENT CONNECTION WITH MECHANICAL AND PLUMBING.
- 15. WHEN SYSTEMS ARE COMPLETE AND OPERATIONAL, A 'PUNCH LIST' INSPECTION SHALL BE REQUESTED BY THE CONTRACTOR. SUCH AN INSPECTION SHALL NOT BE CONDUCTED ON INCOMPLETE OR NON-OPERATIONAL SYSTEMS.
- 16. UPON COMPLETION OF WORK, SUBMIT FOUR COPIES OF OPERATION AND MAINTENANCE MANUALS, AS BUILT DRAWINGS, GUARANTIES AND WARRANTIES.
- AT MINIMUM, THE CONTRACTOR WILL WARRANTY ALL WORK, EQUIPMENT AND MATERIALS FOR ONE YEAR PAST BENEFICIAL OCCUPANCY.
- 17. ALL RECEPS, LOCATED IN AREAS SUBJECT TO MOISTURE, OR ON THE EXTERIOR OF THE BUILDING SHALL BE G.F.I. TYPE, IN WEATHERPROOF, TYPE-FS, BOX WITH WEATHERPROOF COVER.
- 18. NO RECEP. OR DEVICE SHALL BE LOCATED WITHIN 4'-0" OF SINKS. OUTLETS NEAR SINKS, OR IN LOCATIONS SUBJECT TO MOISTURE SHALL BE G.F.I. TYPE. 19. ALL ELECTRICAL WIRING IN OR ON THE BUILDING SHALL BE IN IMC, RMC, OR EMT, IN ACCORDANCE WITH LOCAL CODE AMENDMENT. ALL EXTERIOR

WIRING SHALL BE BURIED IN CONDUIT APPROVED FOR THE ENVIRONMENT IN ACCORDANCE WITH LOCAL CODE AMENDMENT.

SENSOR SWITCH CM 10,

W/ PP20

	LIGHT CONTROL SCHEDULE	
ITEM	DESCRIPTION	REFERENCE MODEL
\$OS	SINGLE RELAY, PASSIVE DUAL TECH SENSING WALL SWITCH. AUTO ON SWITCHING	SENSOR SWITCH WSXA PDT
\$N	LOW-VOLTAGE PUSH BUTTON SWITCH WITH AUTOMATIC ON	SENSOR SWITCH SPODI

LOW VOLTAGE CEILING SENSOR, AUTOMATIC

ON. INCLUDE POWER PACK PER STRING OF

	LIGHTING FIXTURE SCHEDULE										
	TAG MOUN	TING VOLTAGE	LOAD	MAKE	DESCRIPTION	MODEL					
В	GRID	MVOLT	26 VA	CREE	2x2 3000 NOMINAL LUMENS Curved Linear Prismatic lens with trim rings 4000K CCT	ZR22-30L-840-10V5-UNV					
С	RECESSED	MVOLT	13 VA	CREE	6" Round downlight, 1050 delivered lumens, dimmable to 10% (0-10V dimming) 90 CRI 4000 K color temperature	CDR 6 ALS 9ACK 10V5 WH UNV					
E	SURFACE	120/277	5 VA	CREE	Thermoplastic exit sign with stencil face, white housing, red letters,EM CIRCUIT.	C-EE A EX DF RED (VERIFY ARROW AND FACE QTY)					

FIRE PROTECTION SCOPE OF WORK

THE FIRE PROTECTION SYSTEM WORK SHALL BE DESIGN BUILD. THE CONTRACTOR SHALL PROVIDE ALL NECESSARY LABOR, MATERIALS, DESIGN, CALCULATIONS AND COORDINATE WITH ALL LOCAL AUTHORITIES HAVING JURISDICTION TO PRODUCE A COMPLETE AND USABLE SYSTEM WHICH COMPLIES WITH ALL APPLICABLE CODES. LAWS AND REGULATIONS INCLUDING NFPA13 AND THE LOCAL BUILDING CODE. COORDINATE ALL INSTALLATIONS WITH THE GC AND OTHER TRADES TO AVOID CONFLICTS. THE FP SUBCONTRACTOR SHALL BE OBLIGATED TO RELOCATE/REDESIGN ANY PIPE WHICH COME INTO CONFLICT WITH OTHER TRADES AT NO ADDITIONAL COST TO THE OWNER, UNDER ALL CIRCUMSTANCES.

SYSTEM TYPE: WET PIPE WATER SPRINKLER, NFPA 13. ((MODIFY EXISTING SYSTEMS TO ACCOMMODATE THE NEW INSTALLATION.))

WATER SERVICE/RISER: EXISTING TO REMAIN

DESIGN: THE DESIGN BUILD CONTRACTOR SHALL BE SOLELY RESPONSIBLE FOR THE SURVEY OF EXISTING, FLOW TEST, DESIGN. CALCULATIONS, DETAILING, SUBMITTAL, APPROVAL, COORDINATION, LABOR MATERIAL, TESTING AND FINAL PRODUCT. IF REQUIRED, THE CONTRACTOR SHALL INCLUDE ANY REQUIRED FLOW TEST. RELOCATED HEADS IN THE EXISTING RESTROOM IN NEW DROP CEILING AS NEEDED FOR DESIGN/COVERAGE.

MATERIALS: PIPE SHALL BE BLACK STEEL. 2" AND SMALLER SHALL BE SCH40 WITH THREADED FITTINGS. 2-1/2" AND LARGER MAY BE SCH10 WITH MECHANICAL COUPLINGS OR BUTT WELD FITTINGS.

HEADS: SHALL BE CONCEALED TYPE. HEADS DO NOT HAVE TO BE CENTERED IN TILE.

GENERAL MECHANICAL NOTES

- THE CONTRACTOR SHALL VERIFY ALL EXISTING CONDITIONS, MAKE ADJUSTMENTS TO AVOID CONFLICT. NOTIFY THE ENGINEER IN WRITING OF SIGNIFICANT
- 3. PROVIDE VOLUME DAMPERS WHERE INDICATED.
- 4. ALL RECTANGULAR AND ROUND DUCTWORK SHALL BE GALVANIZED SHEET METAL, FABRICATED AND SUPPORTED TO SMACNA STANDARDS. ALL SUPPLY DUCT SHALL
- FLEXIBLE DUCT SHALL BE FLEXMASTER TYPE V OR EQUAL FIBERGLASS INSULATED TYPE. FLEX DUCT SHALL NOT EXCEED 6' IN LENGTH. RIGID ROUND DUCT WITH EXTERIOR INSULATION. USE RIGID ROUND DUCT WITH EXTERIOR INSULATION ABOVE WHERE SHOWN ON THE PLAN. USE RIGID ELBOW FITTINGS WHENEVER POSSIBLE TO AVOID UNNECESSARY CHANGE OF DIRECTION WITH FLEXDUCT.
- SEAL ALL DUCTWORK SEAMS WITH FIBERGLASS TAPE IMBEDDED IN ARABOL SEALER OR ALUMINUM TAPE. DUCT TAPE IS NOT ACCEPTABLE. VAPOR SEAL ALL
- 8. ALL WORK SHALL COMPLY WITH APPLICABLE CODES, REGULATIONS, LAWS AND THE DETERMINATIONS OF THE LOCAL BUILDING OFFICIAL AT NO EXTRA COST. THE
- 10. | ELECTRICAL CONNECTIONS 120V OR HIGHER SHALL BE THE RESPONSIBILITY OF THE ELECTRICAL SUBCONTRACTOR, MECHANICAL SHALL COORDINATE THIS WORK.
- THE MECH SUBCONTRACTOR SHALL START UP EACH UNIT, TEST FOR HEAT AND COOL OPERATION, INSURE ALL DUCTWORK IS FREE OF RATTLES, LEAKS, WHISTLES, ETC. AN INDEPENDENT CONTRACTOR SHALL BALANCE THE SYSTEM AS INDICATED BY DRAWINGS, RTU SCHEDULE, AND VENTILATION SCHEDULES. SUBMIT FOUR COPIES OF A CERTIFIED TEST AND BALANCE REPORT TO THE ARCHITECT FOR APPROVAL. UPON APPROVAL CONTRACTOR SHALL FILE REPORT WITH LOCAL
- WHEN SYSTEMS ARE COMPLETE AND OPERATIONAL, A 'PUNCH LIST' INSPECTION SHALL BE REQUESTED BY THE CONTRACTOR. SUCH AN INSPECTION SHALL NOT BE
- 13. ALL DUCTWORK (SUPPLY AND RETURN) IN UNCONDITIONED SPACES SHALL BE INSULATED WITH A MINIMUM VALUE OF R-5 INSULATION. ALL DUCTS OUTSIDE OF THE
- 14. DUCTS SHALL BE SUPPORTED WITH APPROVED HANGERS AT INTERVALS NOT EXCEEDING 10 FEET OR BY OTHER APPROVED DUCT SUPPORT SYSTEMS DESIGNED IN ACCORDANCE WITH THE INTERNATIONAL MECHANICAL CODE. FLEXIBLE AND OTHER FACTORY MADE DUCTS SHALL BE SUPPORTED IN ACCORDANCE WITH THE
- 15. SMOKE DETECTORS SHALL BE INSTALLED IN RETURN AIR SYSTEMS WITH A DESIGN CAPACITY GREATER THAN 2000 CFM IN THE RETURN AIR DUCT OR PLENUM
- UPON SELECTION OF MECHANICAL APPLIANCES SUBMIT MANUFACTURING INSTALLATION INSTRUCTION TO BUILDING DEPARTMENT, INCLUDE ANY LISTING FOR
- 17. EQUIPMENT SHALL BE INSTALLED AS REQUIRED BY THE TERMS OF THEIR APPROVAL, IN ACCORDANCE WITH THE CONDITIONS OF THE LISTING, THE MANUFACTURERS
 - WHEN TESTED IN ACCORDANCE WITH ASTM-E84.

WHERE APPROVAL CODES HAVE BEEN ESTABLISHED BY OSHA, UNDERWRITER'S LABORATORY, AMERICAN CODES, ANSI, ASME, ASA, ASHRAE, ASTM, ARI, NEL, NFPA, SMACNA, OR THE STATE FIRE INSURANCE REGULATORY BODY, FOLLOW THESE STANDARDS WHETHER OR NOT INDICATED ON THE DRAWINGS AND SPECIFICATIONS. THE MECHANICAL SUBCONTRACTOR SHALL PROVIDE A COMPLETE AND USABLE SYSTEM WITHIN THE INTENT AND SPIRIT OF THAT INDICATED BY THIS DRAWING. WORK OR MATERIALS NOT SHOWN BY THIS DRAWING, BUT NECESSARY TO COMPLETE THE SYSTEM SHALL BE INCLUDED AT NO ADDITIONAL COST. THE MECHANICAL SUBCONTRACTOR SHALL FURNISH AND INSTALL ALL HVAC SYSTEM REQUIREMENTS INCLUDING GRILLES, DIFFUSERS, DUCTWORK, CONTROLS, CONTROL WIRING, DUCTWORK, EQUIPMENT, HVAC PIPING, CUTTING AND PATCHING, ETC.

- CONSTRUCTABILITY ISSUES.
- HAVE 2", 1.5# BLANKET INSUL W/ VAPOR BARRIER. (R-8) FURNISH AND INSTALL NEOPRENE FLEX CONNECTION BETWEEN DUCTWORK AND RTUS/AHUS.
- EXTERIOR INSULATION WITH ALUMINUM TAPE. DUCT TAPE IS NOT ACCEPTABLE.
- CONTRACTOR SHALL ADJUST CURB PLACEMENT AND TRANSITION DUCTWORK AS REQUIRED TO CLEAR STRUCTURAL AND OTHER OBSTACLES. THE CONFIGURATION OF THE STRUCTURE AND OTHER OBSTACLES IN THE EXISTING BUILDING IS NOT KNOWN IN DETAIL. THE CONTRACTOR WILL INVESTIGATE, VERIFY THE DESIGN SHOWN, AND ADJUST AS REQUIRED.
- CONTRACTOR SHALL INFORM THE ENGINEER IN WRITING OF ANY CONFLICT BETWEEN THE PLANS AND APPLICABLE CODES
- ALL MATERIALS WILL BE NEW AND IN NEW CONDITION. SCRATCH AND DENTED, SECONDHAND, SURPLUS, ETC ARE NOT ACCEPTABLE.
- MECHANICAL SHALL FURNISH DUCT SMOKE DETECTORS AS REQUIRED TO ELECTRICAL FOR FIRE ALARM INSTALLATION.
- AUTHORITY.
- CONDUCTED ON INCOMPLETE OR NON-OPERATIONAL SYSTEMS.
- MANUFACTURERS INSTRUCTIONS.
- UPSTREAM OF ANY FILTERS, EXHAUST AIR CONNECTIONS, OUTDOOR AIR CONNECTIONS, OR DECONTAMINATION EQUIPMENT AND APPLIANCES.
- OUTDOOR INSTALLATION, IF APPLICABLE

AIR DEVICE SCHEDULE

FACE SIZE

24 x 24

24 X 24

24 x 24

NECK SIZE

TYPE

Directional Ceiling

Diffuser Round Neck

Exhaust

Cube Core Ceiling

THROW

4-WAY

PATTERN | MOUNTING | MANUFACTURER |

Lay-In

Lay-In

Lay-In

TITUS

TITUS

TITUS

- INSTALLATION INSTRUCTIONS AND APPLICABLE CODES. MANUFACTURERS INSTALLATION INSTRUCTIONS SHALL BE AVAILABLE ON THE JOB SITE FOR INSPECTION.
- 18. ALL COVERING, LININGS, ADHESIVES, WHEN USED SHALL HAVE A FLAME SPREAD RATING NOT MORE THAN 25 AND SMOKE DEVELOPED RATING NOT MORE THAN 50

MODEL

TMS

AA-06-24x24-3-26

PAR-08-24x24-3-

26

50F

PROJECT

10505 Corporate Drive, Pleasant Prairie, WI 53158

phone: 262.857.8101 web: www.kuenyarch.com

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REVISIONS

Kenosha Courthouse Restroom

912 56th St, Kenohsa, WI 53140

Renovation

PROJECT ISSUE DATE:

Kueny Architects

Phone: (262) 857-8101

Address: 10505 Corporate Drive, Suite 100

Architect of Record - Jon P. Wallenkamp

Pleasant Prairie, Wisconsin 53158


Root Engineering Services, P.C. Phone: (847) 249-8398

Engineer of Record - Richard Root

Address: 4215 Grove Avenue

Gurnee, Illinois 60031

REV. / DESCRIPTION

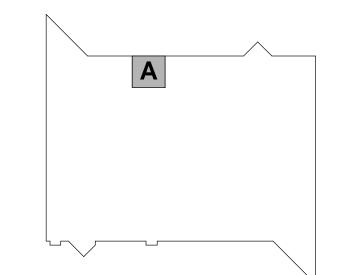



SHEE

SHEET TITLE:

Mechanical and **Electrical Schedules**