

Revisions:		
No.	Date:	Description:
Graphic Scale	As indicated	
DFD Number	KC23-001	
Set Type	100% CD SET	
Date Issued	05/26/2023	
Sheet Number	G000	





## DEMOLITION - EAST ELEVATION


[illegible]

Graphic Scale	3/16" = 1'-0"
DFD Number	KC23-001
Set Type	100% CD SET
Date Issued	05/26/2023
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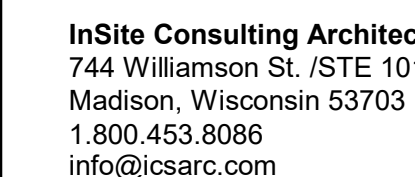




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- DEMO EXISTING STOREFRONT ENTRY DOOR ASSEMBLY.  
 DEMO EXISTING TILE AND DISCARD.  
 DEMO EXISTING CONCRETE STOOP. CONTRACTOR TO ANTICIPATE PERFORMING WATERPROOFING REPLACEMENT BEHIND CONCRETE STOOP.  
 DEMO EXISTING EXPANSION FILLER, BOND BREAKER, AND SEALANT BETWEEN CONCRETE SIDEWALK AND CONCRETE STOOP.  
 CONCRETE SIDEWALK TO REMAIN  
 SHEET APPLIED WATERPROOFING (2 LAYERS) TO REMAIN.  
 GRAVEL BASE TO REMAIN  
 EARTH SUB-BASE TO REMAIN  
 EXISTING WATERPROOFING AT EXTERIOR FOUNDATION WALL TO REMAIN.  
 EXISTING CONCRETE FOUNDATION WALL AND FLOOR STRUCTURE TO REMAIN.
- CONCRETE SILL & DOOR SECTION - DEMOLITION**  
 SCALE: 1" = 1'-0"

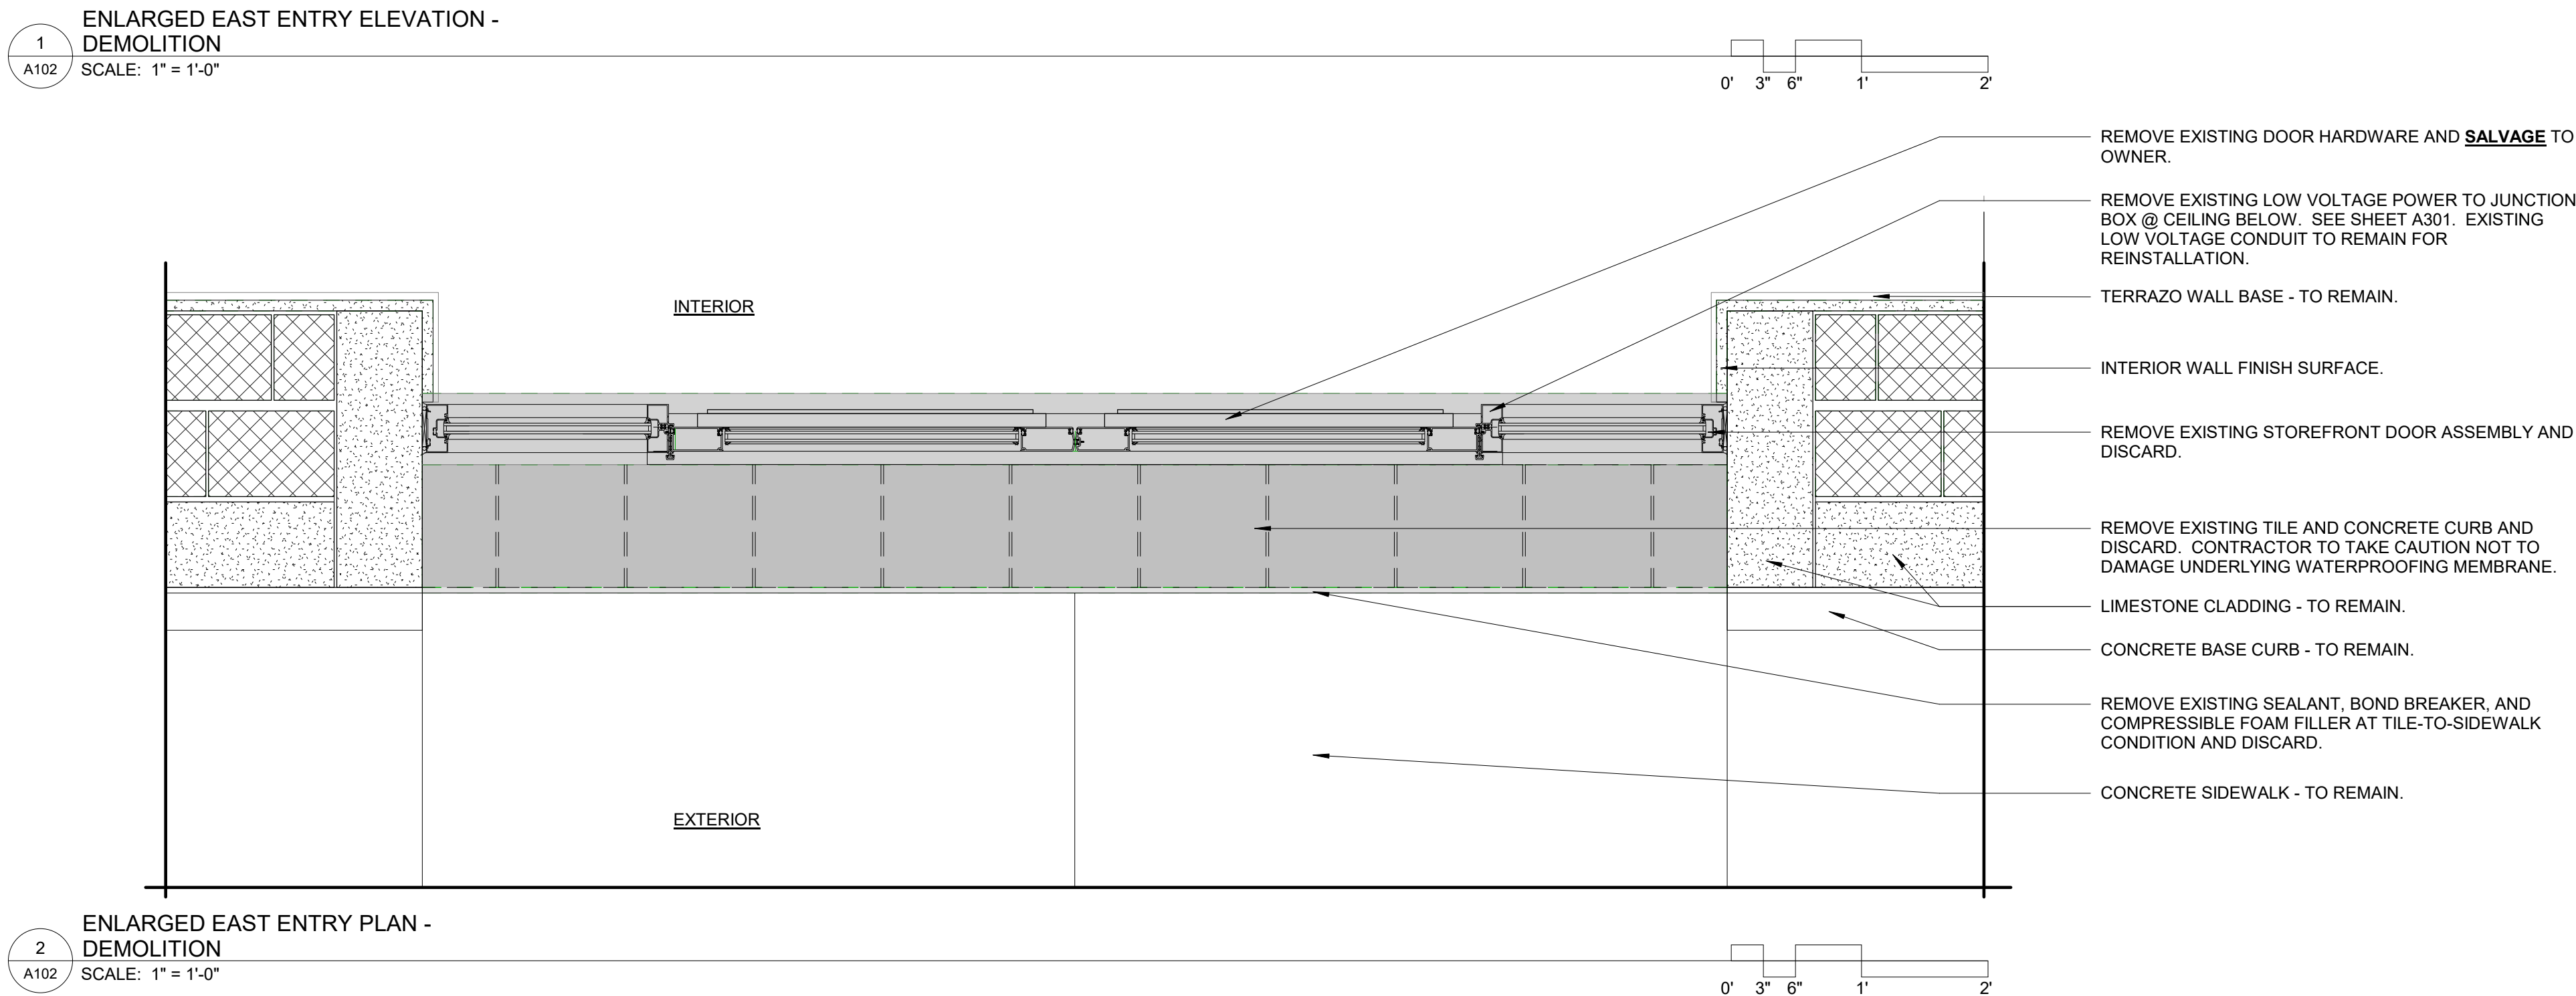

EAST ENTRY REPLACEMENT  
KENOSHA COUNTY ADMINISTRATION BUILDING  
KENOSHA COUNTY  
1010 56TH STREET KENOSHA, WI 53140  
EAST ELEVATION


Revisions:

[illegible]

Graphic Scale	3/16" = 1'-0"
DFD Number	KC23-001
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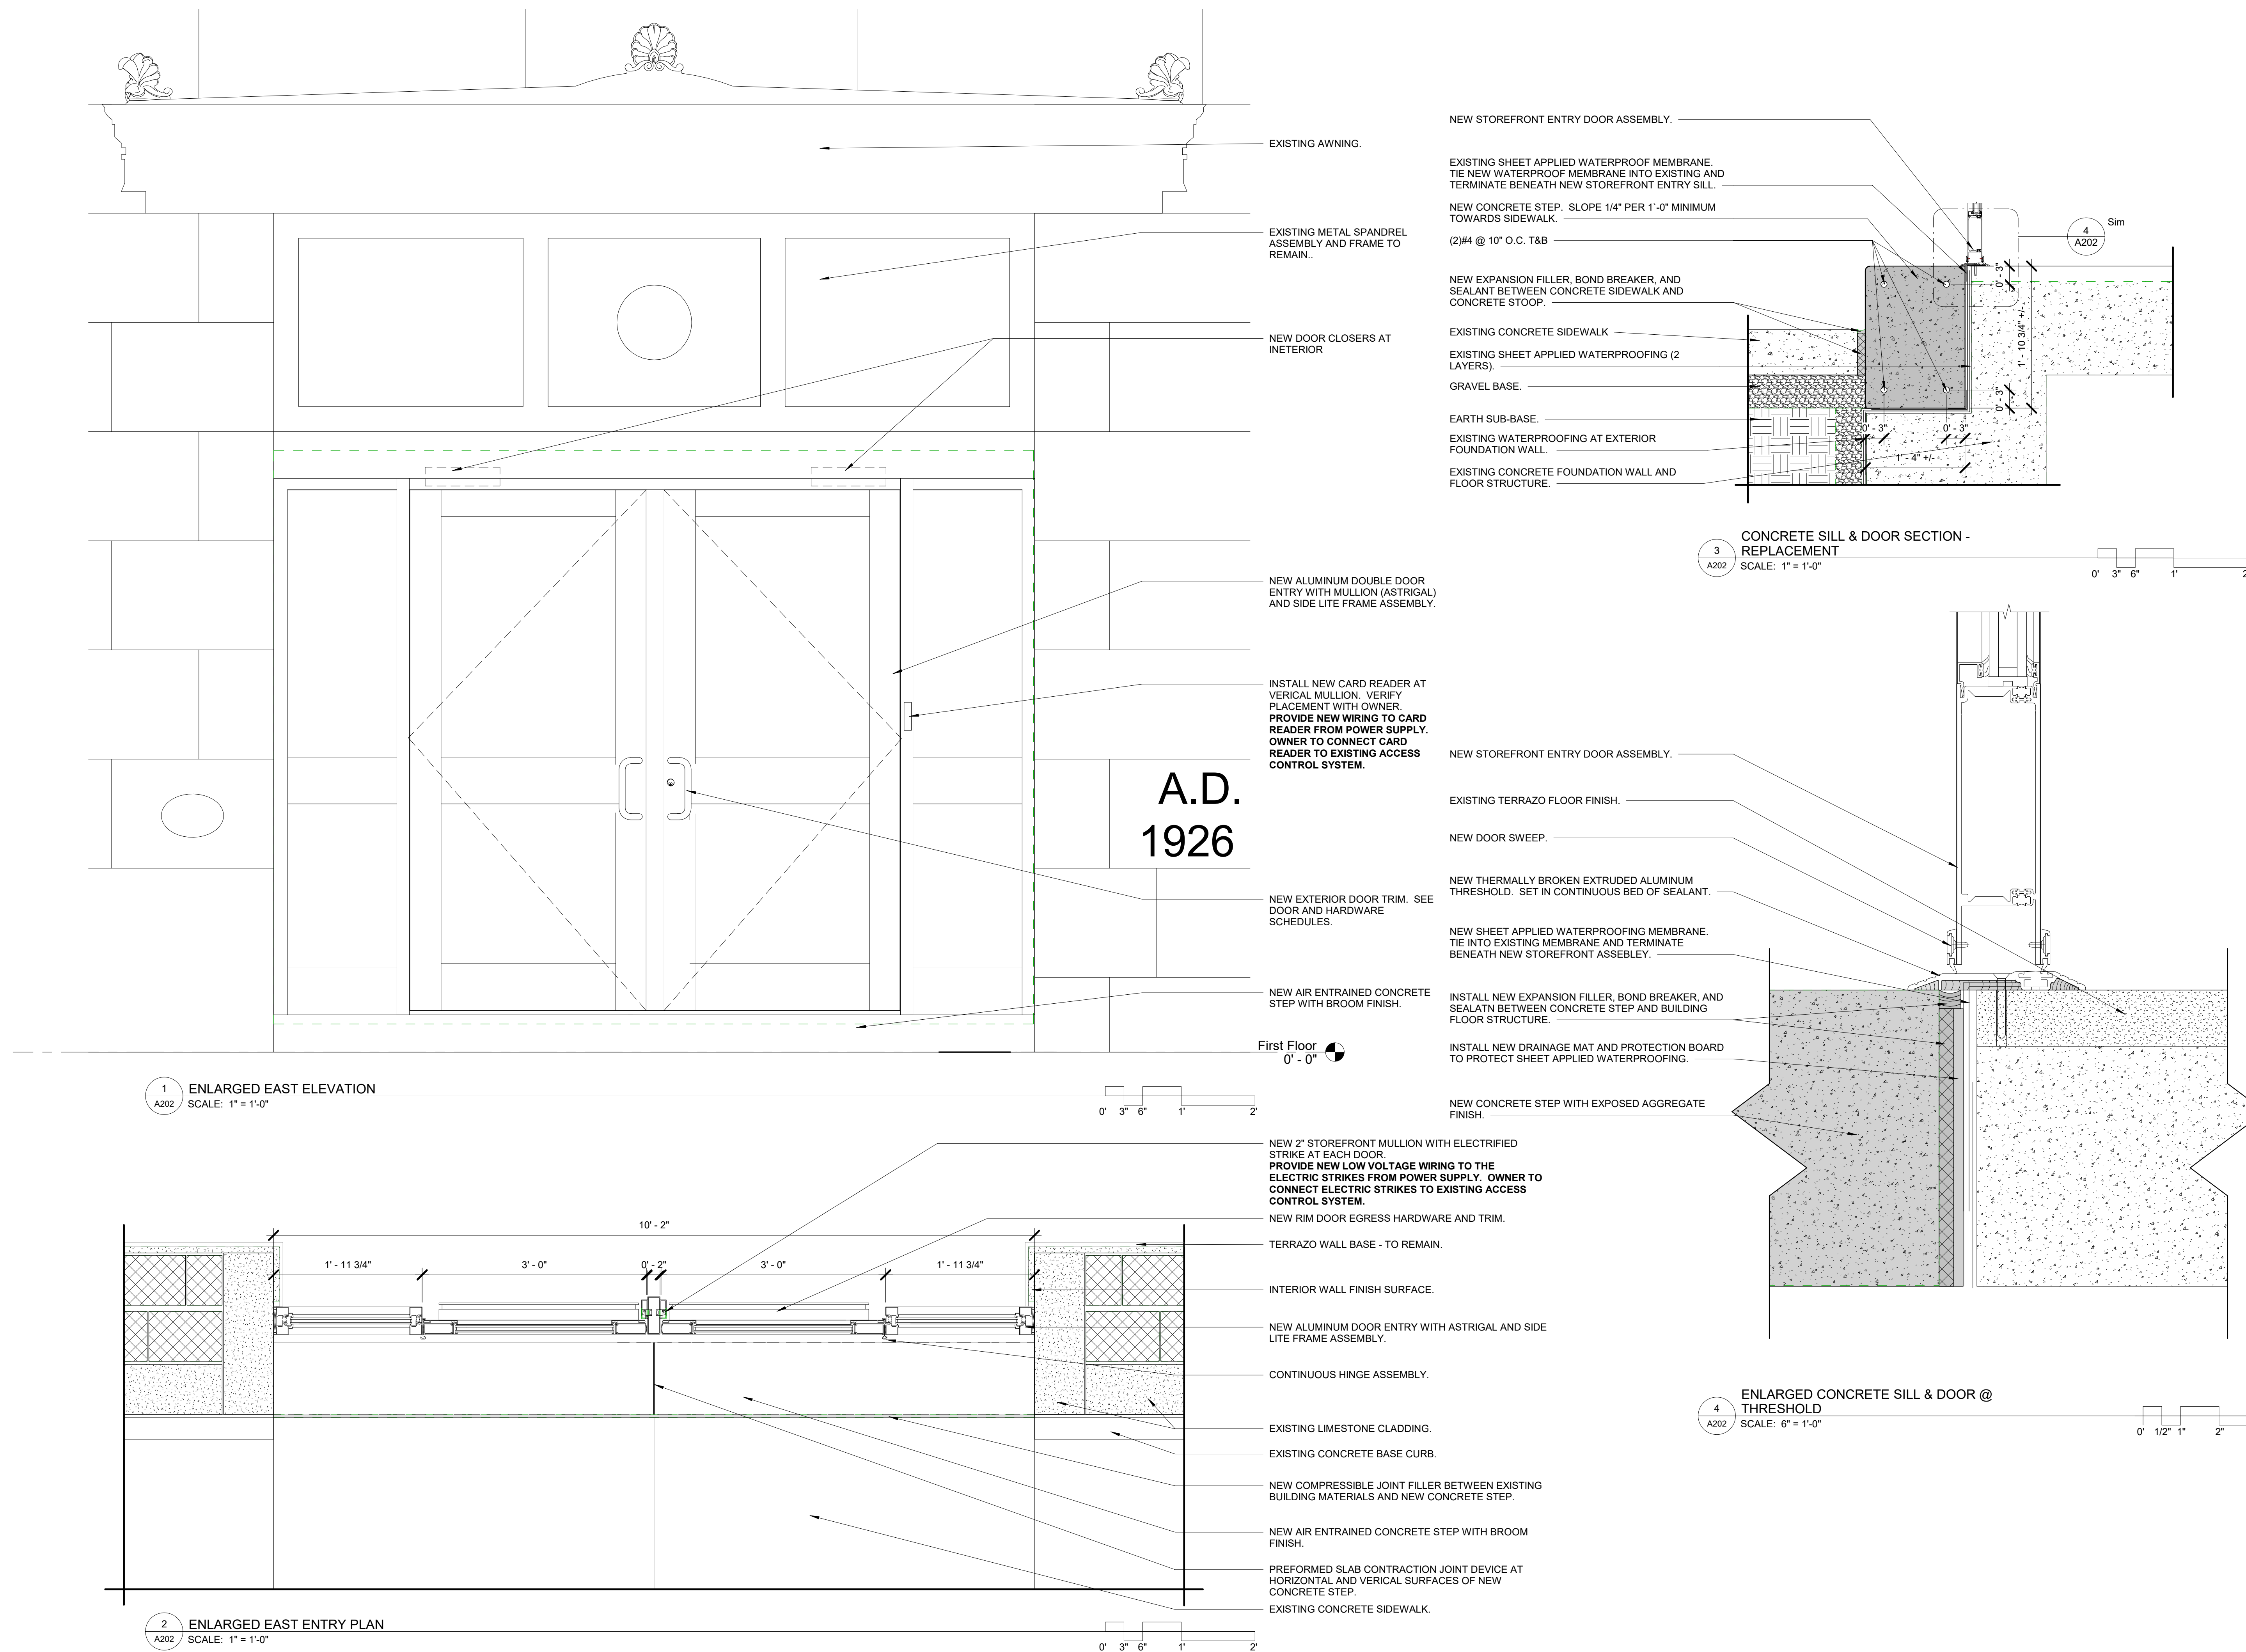





EAST ENTRY REPLACEMENT  
KENOSHA COUNTY ADMINISTRATION BUILDING  
KENOSHA COUNTY  
1010 56TH STREET KENOSHA, WI 53140  
ENLARGED ELEVATION, PLAN & SECTION

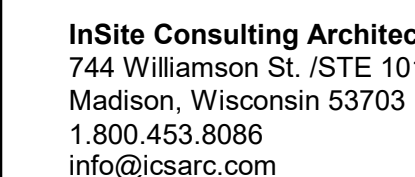[illegible]

Graphic Scale	As indicated
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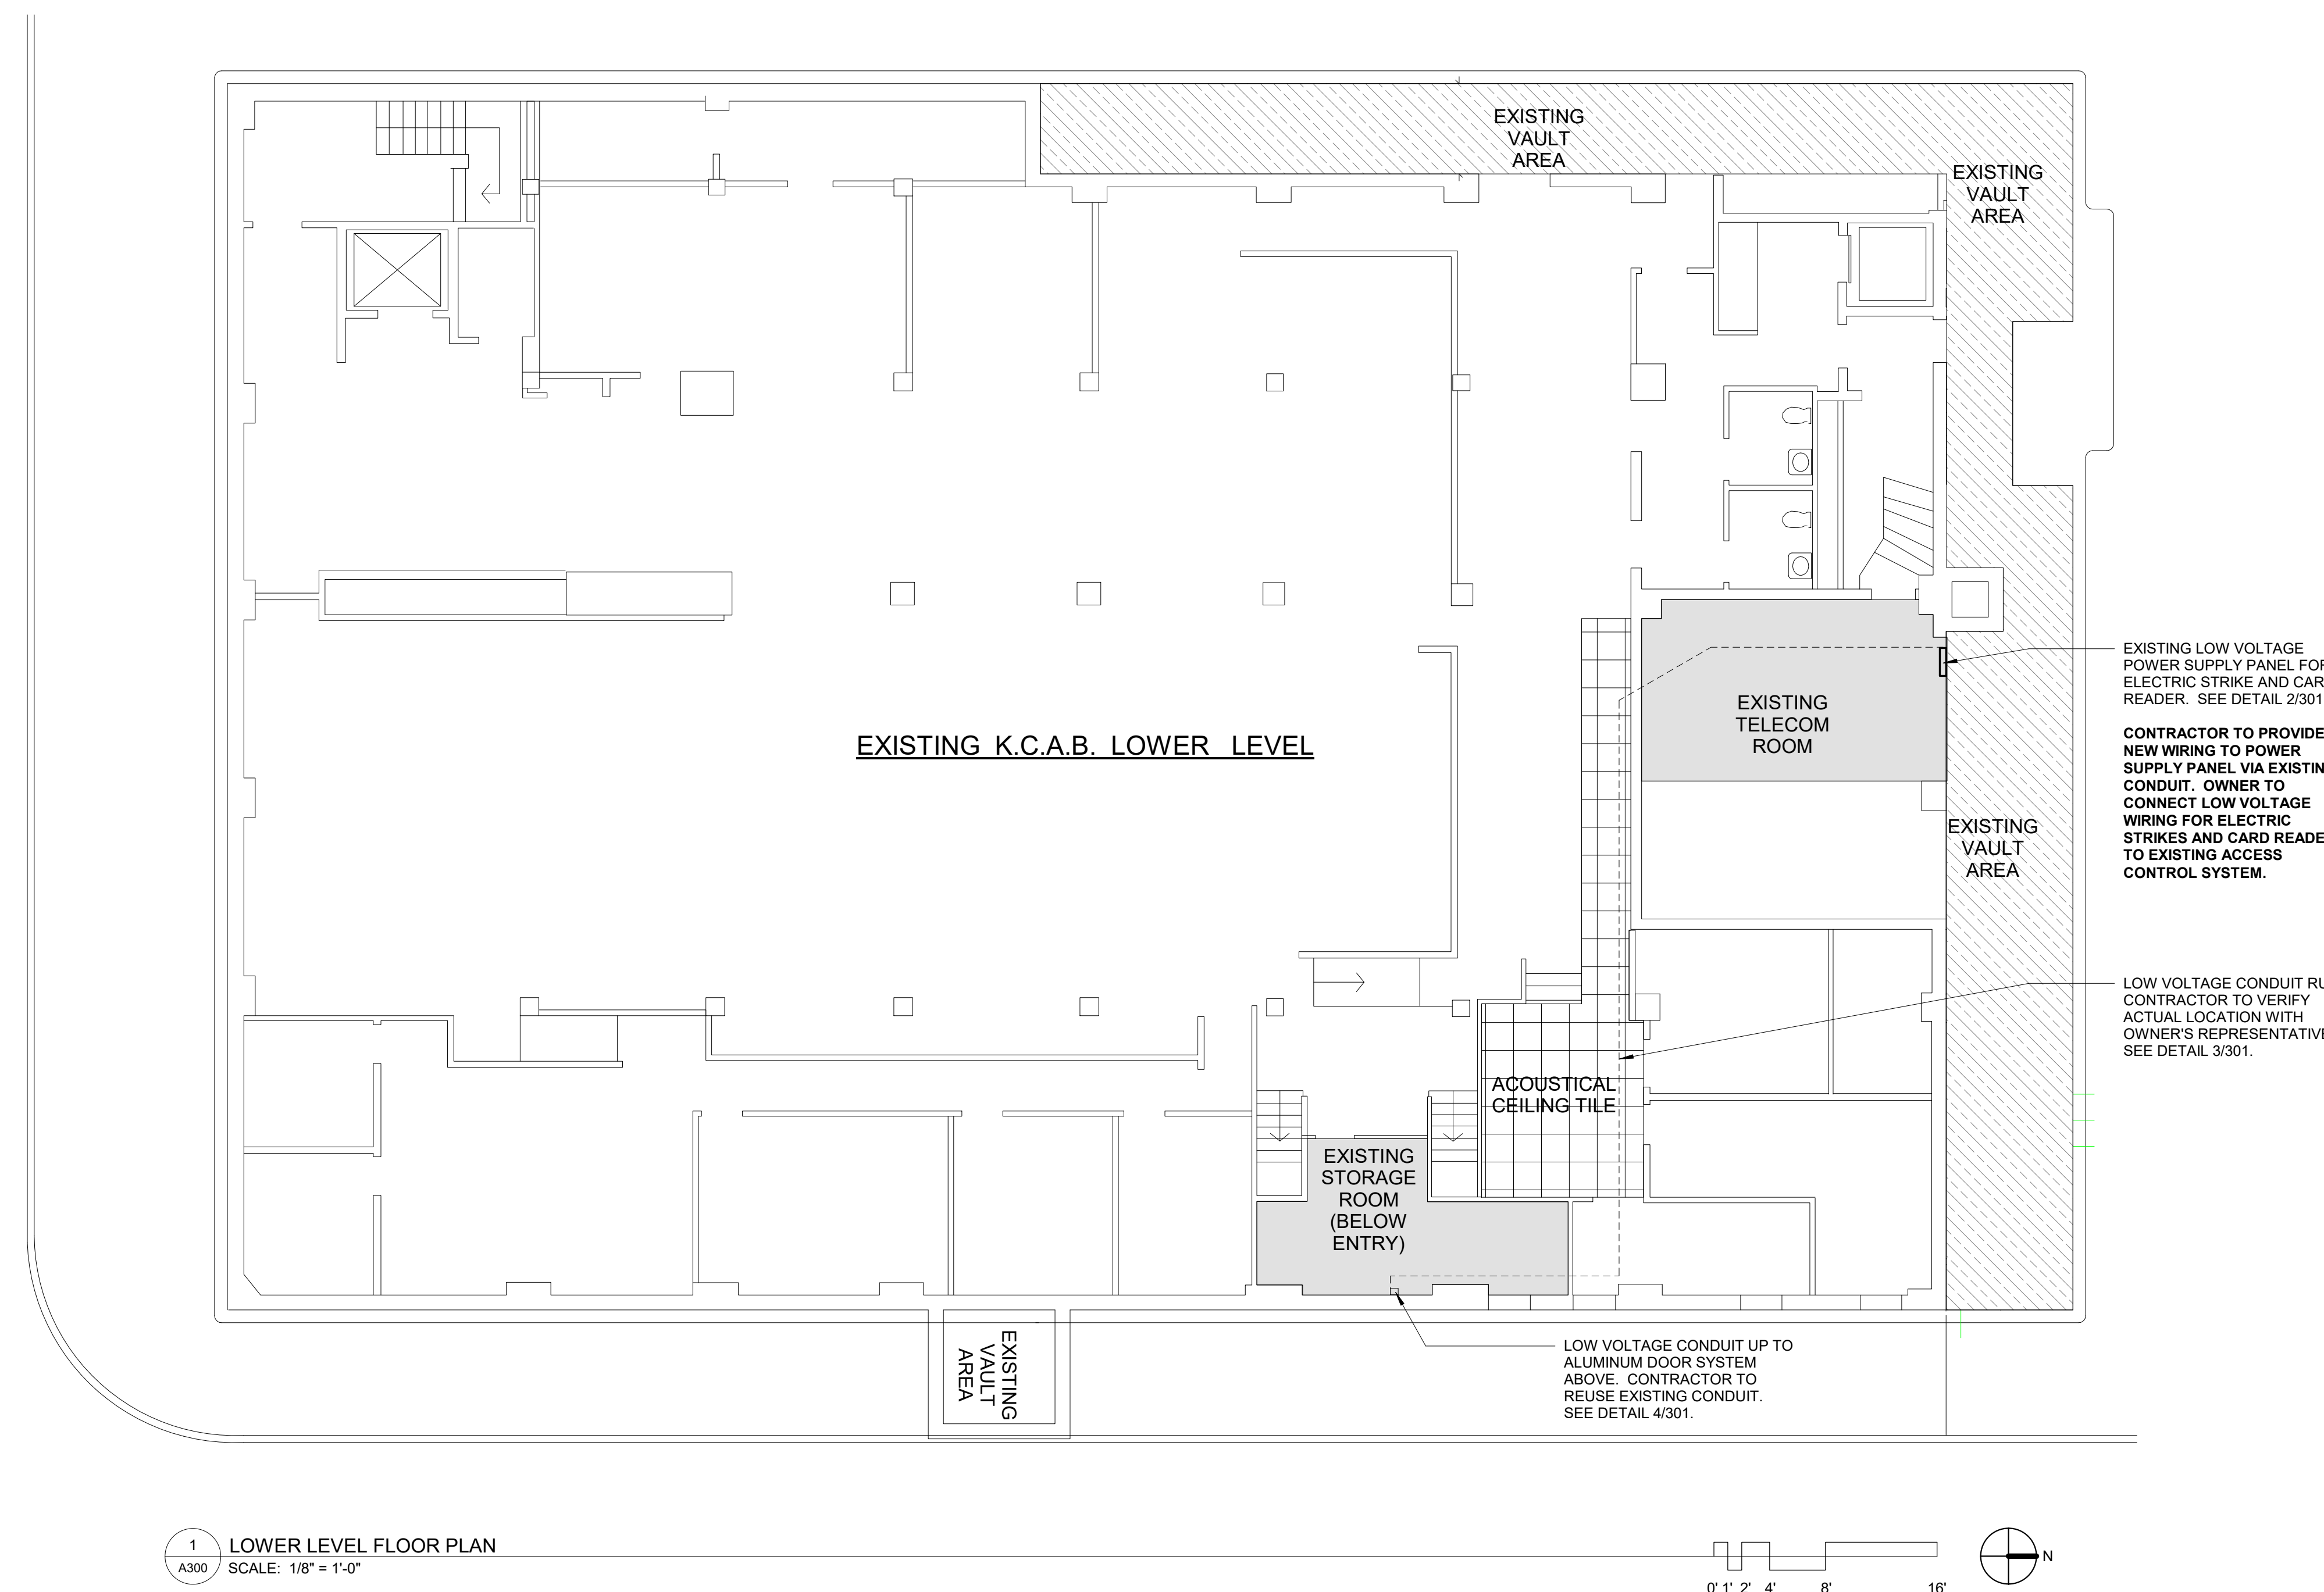
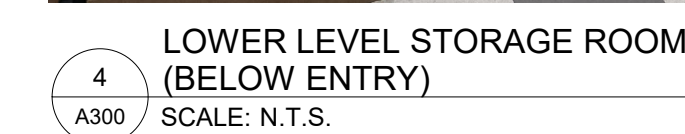
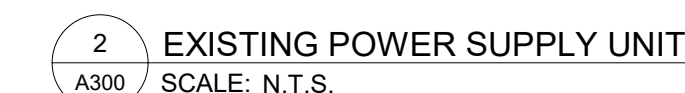


EAST ENTRY REPLACEMENT  
KENOSHA COUNTY ADMINISTRATION BUILDING  
KENOSHA COUNTY  
1010 56TH STREET KENOSHA, WI 53140

LOWER LEVEL FLOOR PLAN

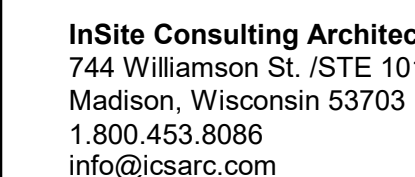[illegible]

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**BUILT-UP ALUMINUM ASTRAGAL (MULLION).**

**ASTRAGAL (MULLION) BASIS OF DESIGN:**  
 MODEL #: 061208 - DIMENSION: 2"x6"  
 MODEL #: 027881 - DIMENSION: 1"x3"  
 MANUFACTURER: KAWNEER  
 FINISH: MATCH DOOR/FRAME ASSEMBLY

**ALUMINUM DOOR ASSEMBLY WITH 1" INTERIOR GLAZED GLAZING UNIT.**


**DOOR ASSEMBLY BASIS OF DESIGN:**  
 MODEL: 500T INSULPOUR ENTRANCE W/TRIFAB VERSA GLAZE 451T FRAMING SYSTEM  
 MANUFACTURER: KAWNEER  
 FINISH: DARK BRONZE

Technical drawings showing cross-sections of door and window assemblies with dimensions:

- Top view dimensions: 0' - 4", 0' - 2", 0' - 1", 0' - 1", 0' - 0 1/2", 0' - 5", 0' - 6", 0' - 2 1/4".
- Side view dimensions: 0' - 5 1/2", 0' - 2".
- End view dimensions: 0' - 2", 0' - 4 1/2".

3	CGH STILE W/SIDELITE - 1" INFILL	4	JAMB - 1" INF
A700	SCALE: 6" = 1'-0"	A700	SCALE: 6" = 1'-0"


7 SILL WITH SEALANT OPTION - 1" INFILL  
A700 SCALE: 6" = 1'-0"

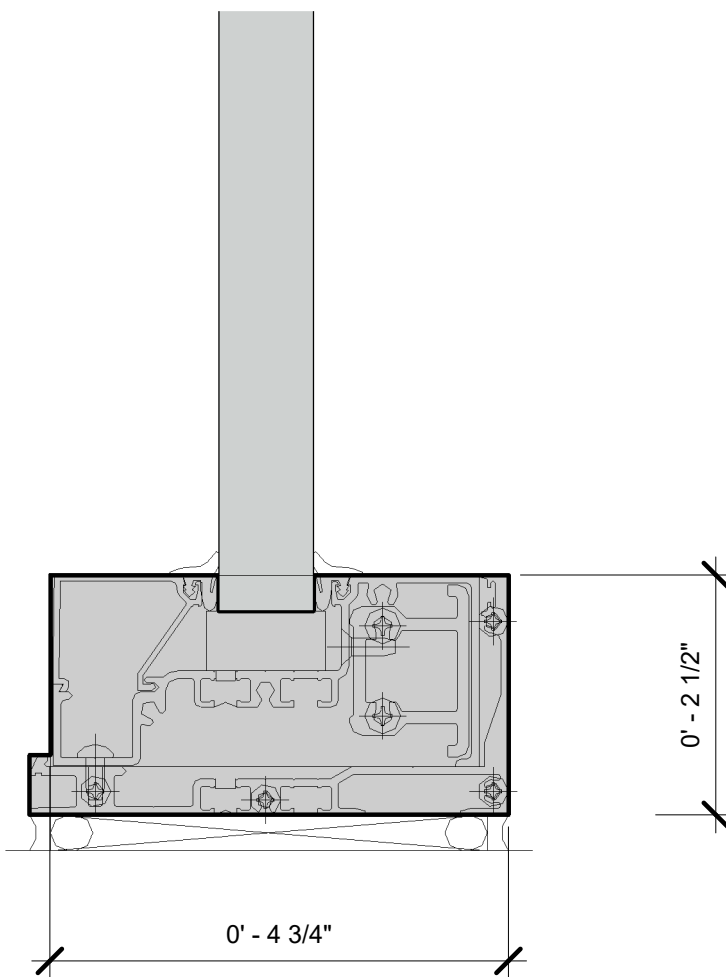


Technical drawing of a vertical component, likely a valve or actuator, showing a side view. The drawing includes the following dimensions:

- Top width:  $0' - 2 \frac{1}{4}"$
- Overall height:  $0' - 8"$

The component features a central vertical shaft, a main body with internal components visible, and a flared base. The drawing is a black and white line drawing with a shaded central area.

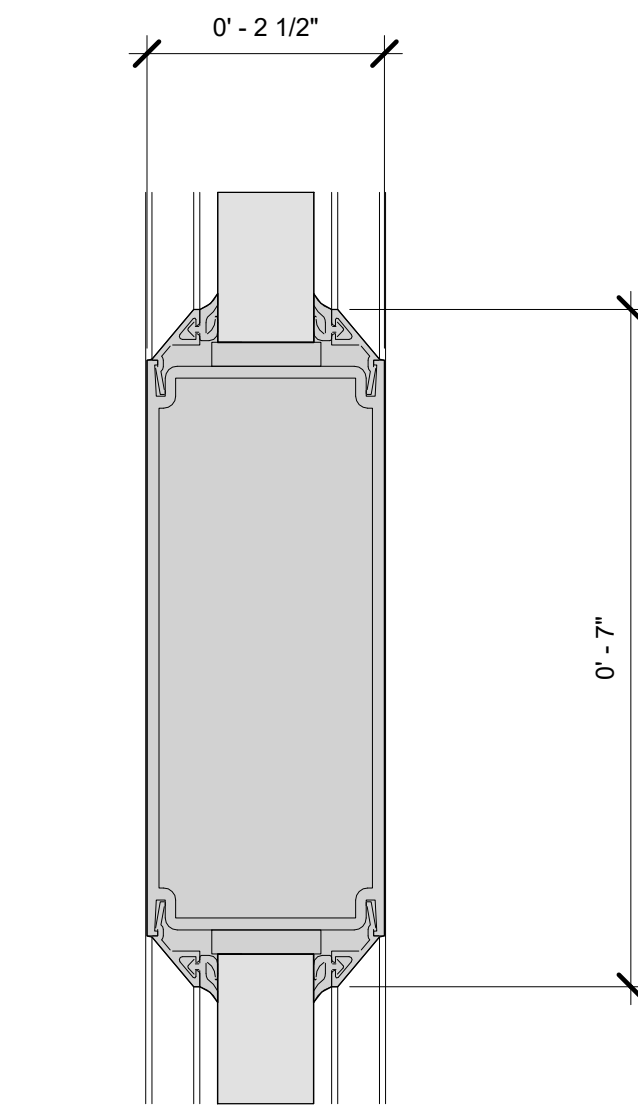

0.70

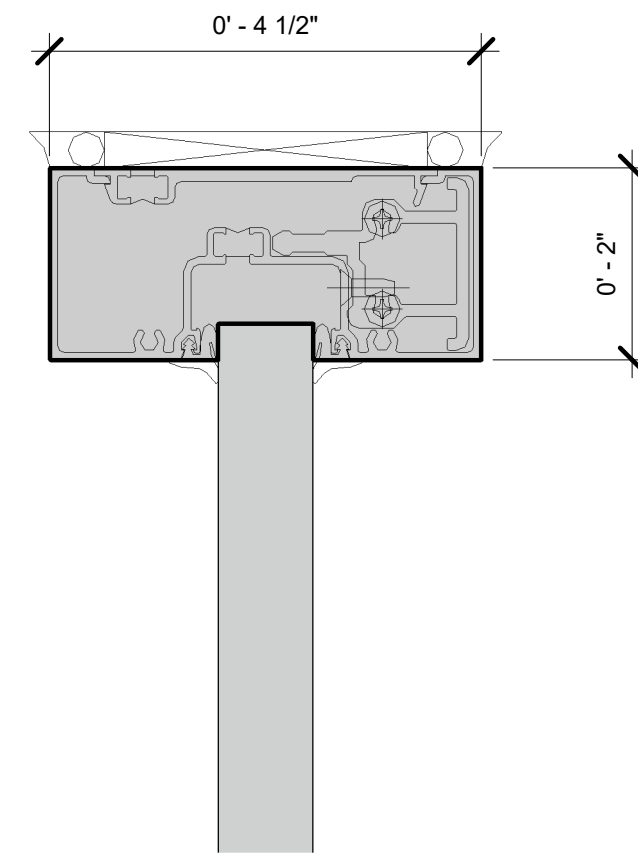

Technical drawing of a T-shaped floor plan. The overall dimensions are 0' - 5 1/2" wide and 0' - 4 1/2" deep. The plan includes a central rectangular area labeled 'LIVING ROOM' and a smaller rectangular area labeled 'KITCHEN' at the top. The kitchen area contains a sink, stove, and refrigerator. The living room area contains a sofa, coffee table, and a fireplace. The drawing also shows a front door, a back door, and a window.

8 DOOR HEADER - 1" INFILL  
A700 SCALE: 6" = 1'-0"















- A. **Setting Blocks:** Silicone, with 80 to 90 Shore A durometer hardness; ASTM C864 Option II. Length of 0.1 inch for each square foot of glazing or minimum 4 inch by width of glazing rabbit space minus 1/16 inch by height to suit glazing method and pane weight and area.
- B. **Spacer Shims:** Neoprene, 50 to 60 Shore A durometer hardness; ASTM C864 Option II. Continuous by one half the height of the glazing stop by thickness to suit application, self adhesive on one face.
- C. **Glazing Splices:** Resilient silicone extruded shape to suit glazing channel retaining slot; ASTM C864 Option II; color black.

### 3.01 VERIFICATION OF CONDITIONS

- ### 3.02 PREPARATION

- ### 3.03 INSTALLATION, GENERAL

- ### 3.04 INSTALLATION - DRY GLAZING METHOD (GASKET GLAZING)

- ### 3.05 CLEANING

- ### 3.06 PROTECTION

- END OF SECTION 088000**

**InSite Consulting Architects**  
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# GUIDELINE SPECIFICATIONS

[illegible]

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